

**JOINT**  
**PUBLIC NOTICE**

**CHARLESTON DISTRICT, CORPS OF ENGINEERS**  
69A Hagood Avenue  
Charleston, South Carolina 29403-5107  
and

**THE S.C. DEPARTMENT OF HEALTH AND ENVIRONMENTAL CONTROL**  
Office of Environmental Quality Control  
Water Quality Certification and Wetlands Programs Section  
2600 Bull Street  
Columbia, South Carolina 29201

REGULATORY DIVISION  
Refer to: P/N #2003-1G-183-C

13 FEBRUARY 2003

Pursuant to Sections 401 and 404 of the Clean Water Act (33 U.S.C. 1344), and the South Carolina Coastal Zone Management Act (48-39-10 et seq.) an application has been submitted to the Department of the Army and the S.C. Department of Health and Environmental Control by

**BURROUGHS & CHAPIN CO., INC.**  
C/O AMANDA CARRELL, WESI  
2411 OAK STREET, SUITE 108  
MYRTLE BEACH, SOUTH CAROLINA 29577

for a permit to place fill in

**FRESHWATER WETLANDS**

at a location, the existing Pine Lakes Golf Course, located at 5603 Woodside Drive, Myrtle Beach, Horry County, South Carolina.  
(Latitude -78.8471° - Longitude 33.7342°)

In order to give all interested parties an opportunity to express their views

**NOTICE**

is hereby given that written statements regarding the proposed work will be received by both of the above mentioned offices until

**12 O'CLOCK NOON, MONDAY, MARCH 15, 2004**

from those interested in the activity and whose interests may be affected by the proposed work.

The proposed work consists of placing 10,623 cubic yards of fill material in 4.24 acres of jurisdictional waters of the U. S. (golf course retention/drainage ponds) and 5.68 acres of non-jurisdictional freshwater wetlands for access and residential development of the site adjacent to the existing golf course. As mitigation for the proposed impacts, the applicant proposes to preserve and enhance the remaining 9.18 acres of waters of the U. S. onsite with upland buffers (25-foot average width adjacent to single-family homes and 50-foot width adjacent to the golf course). As additional mitigation, the applicant proposes to purchase 91 non-buffer restoration and enhancement credits and 11.37 preservation credits from the Historic Ricefields Mitigation Program. The purpose of the proposed work is to facilitate residential and commercial development of the site.

**NOTE:** Plans depicting the work described in this notice are available and will be provided, upon receipt of a written request, to anyone that is interested in obtaining a copy of the plans for the specific project. The request must identify the project of interest by public notice number and a self-addressed stamped envelope must also be provided for mailing the drawings to you. Your request for drawings should be addressed to the

**U.S. Army Corps of Engineers  
ATTN: REGULATORY DIVISION  
69A Hagood Avenue  
Charleston, South Carolina 29403-5107.**

The District Engineer has concluded that the discharges associated with this project, both direct and indirect, should be reviewed by the South Carolina Department of Health and Environmental Control in accordance with provisions of Section 401 of the Clean Water Act. As such, this notice constitutes a request, on behalf of the applicant, for certification that this project will comply with applicable effluent limitations and water quality standards. The work shown on this application must also be certified as consistent with applicable provisions of the South Carolina Coastal Zone Management Act (15 CFR 930). The District Engineer will not process this application to a conclusion until such certifications are received. The applicant is hereby advised that supplemental information may be required by the State to facilitate the review. Persons wishing to comment or object to State certification must submit all comments in writing to the S.C. Department of Health and Environmental Control at the above address within thirty (30) days of the date of this notice.

This notice initiates the Essential Fish Habitat (EFH) consultation requirements of the Magnuson-Stevens Fishery Conservation and Management Act. Implementation of the proposed project would impact 9.92 acres of freshwater wetlands inland of estuarine substrates and emergent wetlands utilized by various life stages of species comprising the red drum, shrimp, and snapper-grouper management complexes. Our initial determination is that the proposed action would not have a substantial individual or cumulative adverse impact on EFH or fisheries managed by the South Atlantic Fishery Management Council and the National Marine Fisheries Service (NMFS). Our final determination relative to project impacts and the need for mitigation measures is subject to review by and coordination with the NMFS.

The District Engineer has consulted the most recently available information and has determined that the project will have no effect on any Federally endangered, threatened, or proposed species and will not result in the destruction or adverse modification of designated or proposed critical habitat. This public notice serves as a request to the U.S. Fish and Wildlife Service and the National Marine Fisheries Service for any additional information they may have on whether any listed or proposed endangered or threatened species or designated or proposed critical habitat may be present in the area which would be affected by the activity, pursuant to Section 7(c) of the Endangered Species Act of 1973 (as amended).

The District Engineer has consulted the latest published version of the National Register of Historic Places for the presence or absence of registered properties, or properties listed as being eligible for inclusion therein, and this worksite is not included as a registered property or property listed as being eligible for inclusion in the Register. Consultation of the National Register constitutes the extent of cultural resource investigations by the District Engineer, and he is otherwise unaware of the presence of such resources. Presently unknown archaeological, scientific, prehistorical, or historical data may be lost or destroyed by the work to be accomplished under the requested permit.

Any person may request, in writing, within the comment period specified in this notice, that a public hearing be held to consider this application. Requests for a public hearing shall state, with particularity, the reasons for holding a public hearing.

13 FEBRUARY 2004


The decision whether to issue a permit will be based on an evaluation of the probable impact including cumulative impacts of the activity on the public interest and will include application of the guidelines promulgated by the Administrator, Environmental Protection Agency (EPA), under authority of Section 404(b) of the Clean Water Act and, as appropriate, the criteria established under authority of Section 102 of the Marine Protection, Research and Sanctuaries Act of 1972, as amended. That decision will reflect the national concern for both protection and utilization of important resources. The benefit which reasonably may be expected to accrue from the project must be balanced against its reasonably foreseeable detriments. All factors which may be relevant to the project will be considered including the cumulative effects thereof; among those are conservation, economics, aesthetics, general environmental concerns, wetlands, historic properties, fish and wildlife values, flood hazards, flood plain values, land use, navigation, shoreline erosion and accretion, recreation, water supply and conservation, water quality, energy needs, safety, food and fiber production and, in general, the needs and welfare of the people. A permit will be granted unless the District Engineer determines that it would be contrary to the public interest. In cases of conflicting property rights, the Corps of Engineers cannot undertake to adjudicate rival claims.

The Corps of Engineers is soliciting comments from the public; Federal, state, and local agencies and officials; Indian Tribes; and other interested parties in order to consider and evaluate the impacts of this activity. Any comments received will be considered by the Corps of Engineers to determine whether to issue, modify, condition or deny a permit for this project. To make this decision, comments are used to assess impacts on endangered species, historic properties, water quality, general environmental effects, and the other public interest factors listed above. Comments are used in the preparation of an Environmental Assessment and/or an Environmental Impact Statement pursuant to the National Environmental Policy Act. Comments are also used to determine the need for a public hearing and to determine the overall public interest of the activity.

If there are any questions concerning this public notice, please contact me at 843-329-8044 or toll free at 1-866-329-8187.




Mary Hope Glenn  
Project Manager  
Regulatory Division  
U.S. Army Corps of Engineers

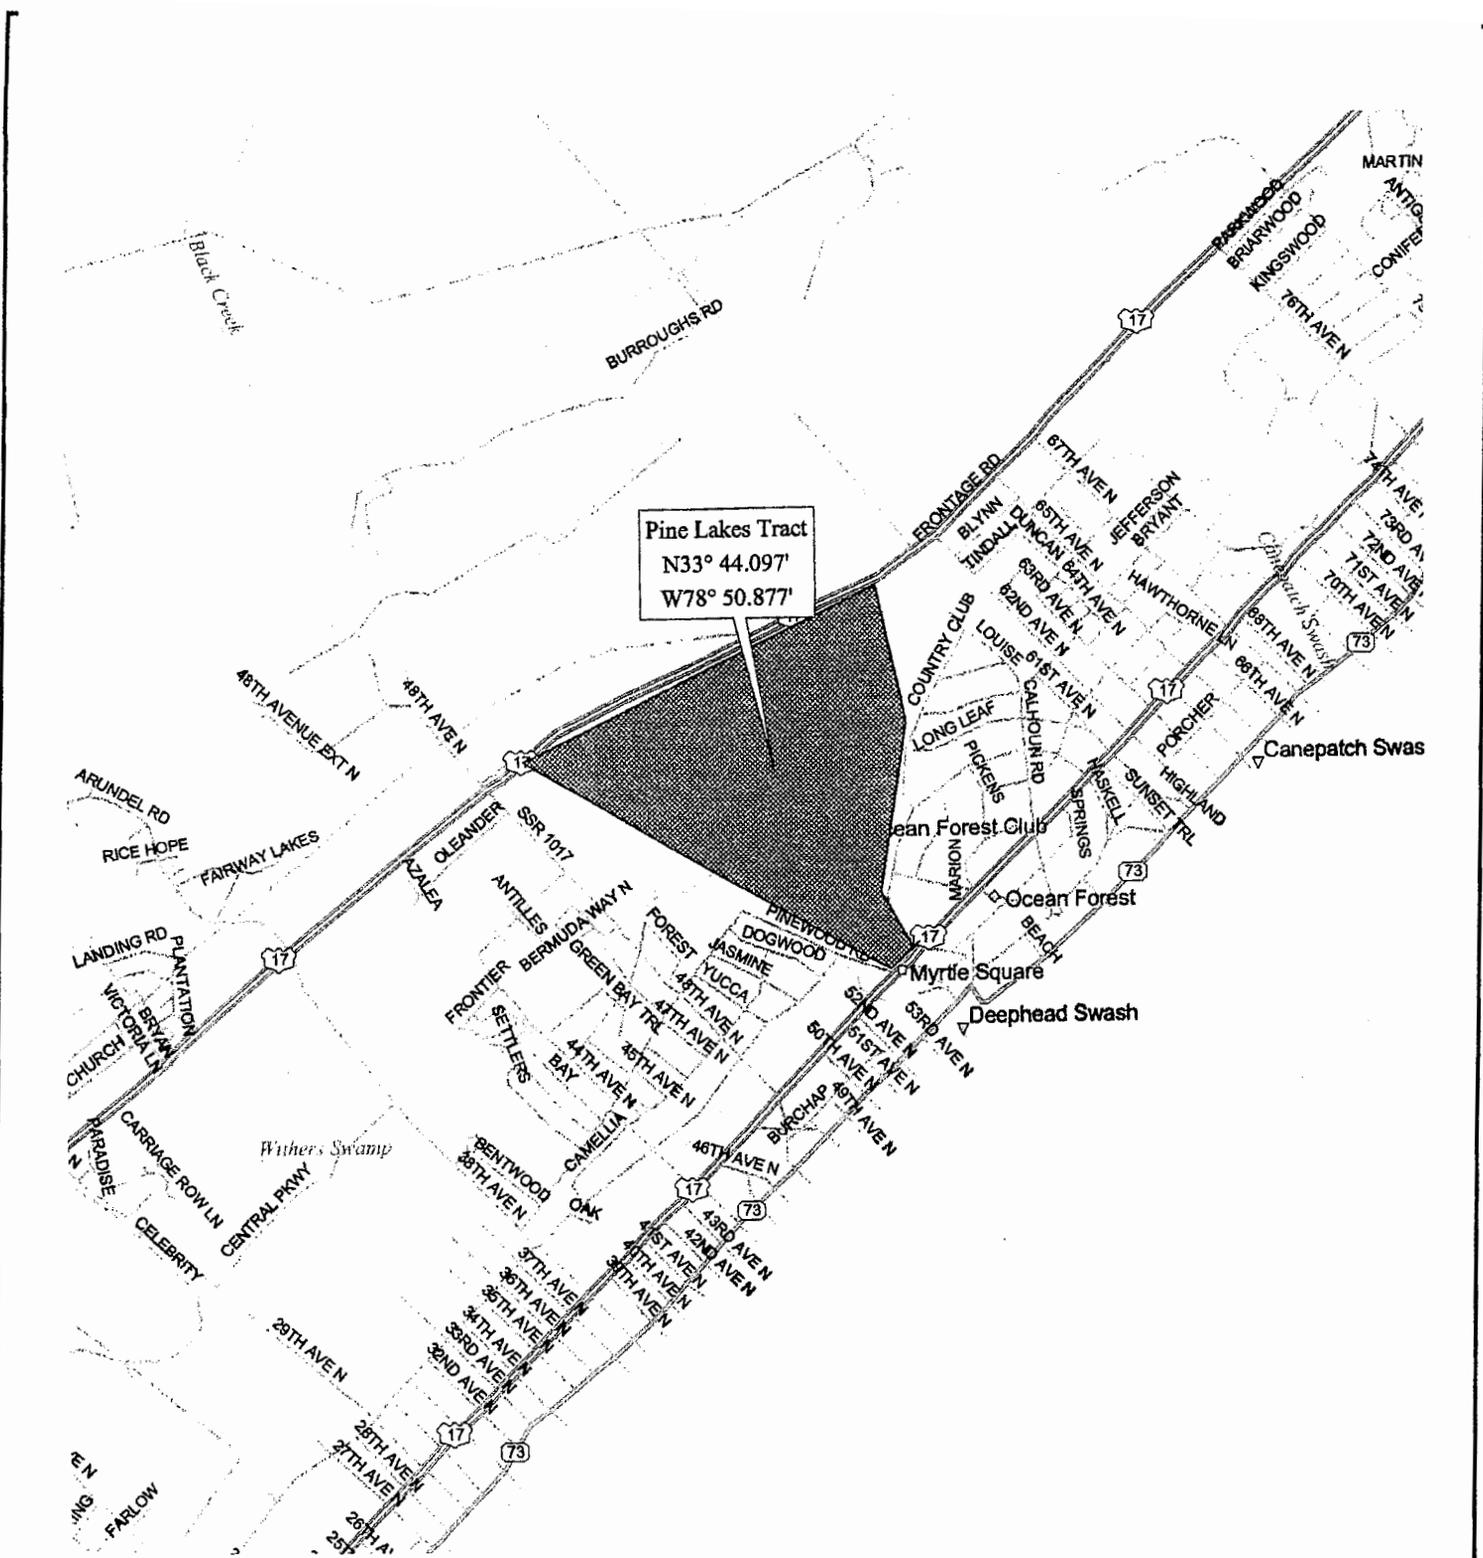

Pine Lakes Tract  
 N33° 44.097'  
 W78° 50.877'

Sheet Title: Vicinity Map	
Project Title: Pine Lakes Permit Application	
Project Location: Myrtle Beach, South Carolina	
Applicant: Burroughs & Chapin Company, Inc.	
Authorized Agent: Amanda L. Carrel, WESI Consulting, Inc.	
Scale: not to scale	Date: 1/20/04
Application # 2003-16-183	Page: 1 of 19

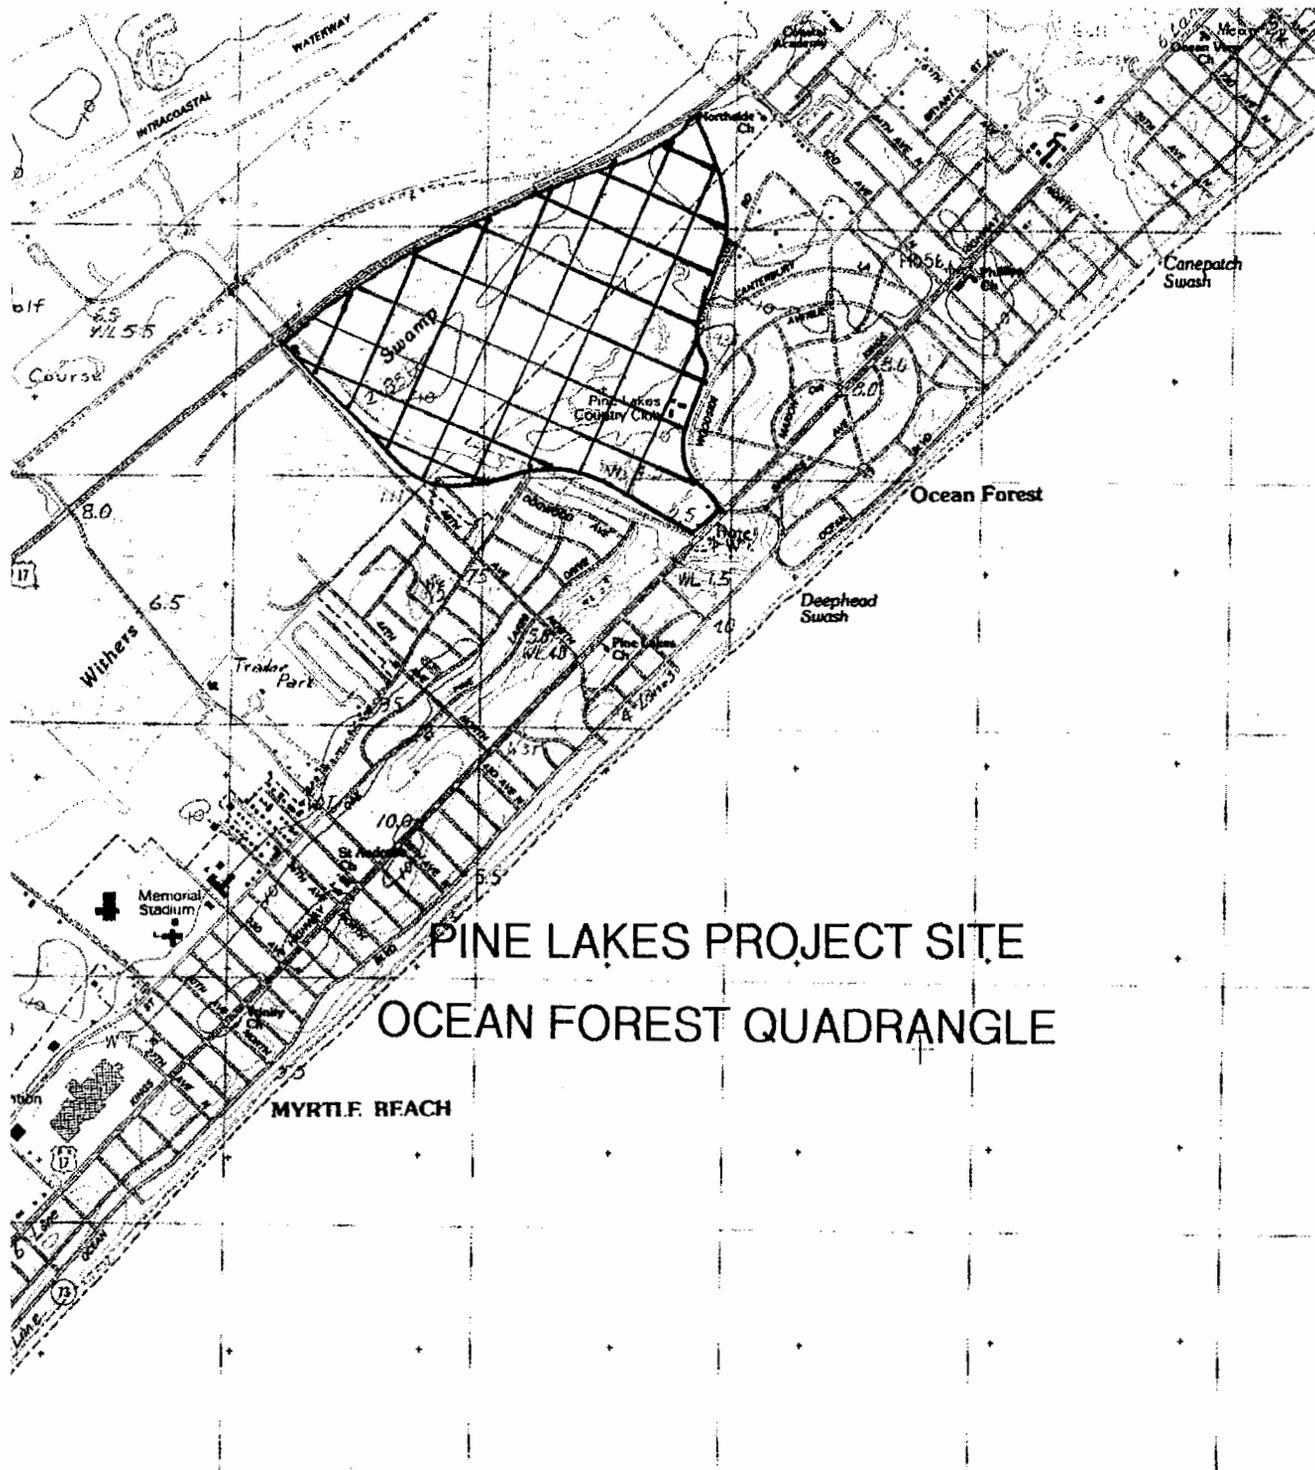

**PINE LAKES PROJECT SITE  
OCEAN FOREST QUADRANGLE**

**MYRTLE BEACH**

<b>Sheet Title:</b> Topographic Map	
<b>Project Title:</b> Pine Lakes Permit Application	
<b>Project Location:</b> Myrtle Beach, South Carolina	
<b>Applicant:</b> Burroughs & Chapin Company, Inc.	
<b>Authorized Agent:</b> Amanda L. Carrel, WESI Consulting, Inc.	
<b>Scale:</b> not to scale	<b>Date:</b> 1/20/04
<b>Application #</b> 2003-19-183	<b>Page:</b> 2 of 19

Compensatory Mitigation  
Credit Factors and Worksheets

ADVERSE IMPACT FACTORS FOR WETLANDS AND OTHER WATERS OF THE U.S. EXCLUDING STREAMS

Factors		Options				
Lost Type	Type C 0.2	Type B 2.0		Type A 3.0		
Priority Category	Tertiary 0.1	Secondary 0.2			Primary 0.4	
Existing Condition	Very Impaired 0.1	Impaired 1.0	Slightly Impaired 2.0	Fully Functional 2.5		
Duration	Seasonal 0.1	0 to 1 0.2	1 to 3 0.5	3 to 5 1.0	5 to 10 1.5	Over 10 2.0
Dominant Impact	Seasonal 0.2	Clear 1.0	Dredge 1.5	Drain 2.0	Impound 2.5	Fill 3.0
Cumulative Impact	0.05 x EAA <sub>i</sub>					

Note: For the Cumulative Impact factor, EAA<sub>i</sub> stands for the sum of the acres of adverse impacts to aquatic areas for the overall project. When computing this factor, round to the nearest tenth decimal place using even number rounding. Thus 0.01 and 0.050 are rounded down to give a value of zero while 0.051 and 0.09 are rounded up to give 0.1 as the value for the cumulative impact factor. The cumulative impact factor for the overall project must be used in each area column on the Required Mitigation Credits Worksheet below.

REQUIRED MITIGATION CREDITS WORKSHEET

Lost Type	3.0
Priority Category	0.4
Existing Condition	2.5
Duration	2.0
Dominant Impact	3.0
Cumulative Impact	0.5
Sum of Factors	R <sub>i</sub> = 11.4
Impacted Area	AA <sub>i</sub> = 9.92
R x AA	113.09

Total Required Credits = Sum of all (R x AA) = 113.09

Total Acres of Impact = 9.92

Sheet Title: Adverse Impacts Credit Calculation

Project Title: Pine Lakes Permit Application

Project Location: Myrtle Beach, South Carolina

Applicant: Burroughs & Chapin Company, Inc.

Authorized Agent: Amanda L. Carrel, WESI Consulting, Inc.

Scale: not to scale

Date: 1/20/04

Application # 2003-16-183

Page: 3 of 19

Compensatory Mitigation  
Credit Factors and Worksheets

**RESTORATION AND ENHANCEMENT MITIGATION FACTORS**

Factors	Options				
	Minimal Enhancement 0.1 ----- to ----- Excellent Restoration 4.0				
Net Improvement	Not Applicable 0	Covenant Private 0.1	Covenant POA 0.2	Conservation Easement 0.4	Transfer Fee Title Conservancy 0.6
Control	Not Applicable 0	Over 20 -0.3	10 to 20 -0.2	5 to 10 -0.1	0 to 5 0
Temporal Lag	Schedule 5* 0	Schedule 4 0.1	Schedule 3 0.2	Schedule 2 0.3	Schedule 1 0.4
Credits Schedule	Category 5 -0.1	Category 4 0	Category 3 0.2	Category 2 0.3	Category 1 0.4
Kind	Zone 5 -0.1	Zone 4 0	Zone 3 0.2	Zone 2 0.3	Zone 1 0.4
Location					

\*Use this option to calculate credits for enhancement by buffering.

**Proposed Restoration and Enhancement Mitigation Worksheet**

total preserved wetland acreage	9.18-acres
total upland buffer acreage	6.69-acres

Factor	Pine Lakes
Net Improvement	2
Control	0.1
Temporal Lag	0
Credit Schedule	0
Kind	0.4
Location	0.4
Sum of M Factors	$M_{pl} = 2.9$
Mitigation Area	$AA_{pl} = 6.69$
$M \times A$	19.40

**Total Restoration and Enhancement Credits = Sum of all (M x A) = 19.40**

**Total Restoration and Enhancement Acreage = 6.69**

**Sheet Title:** Restoration and Enhancement Credit Calculation

**Project Title:** Pine Lakes Permit Application

**Project Location:** Myrtle Beach, South Carolina

**Applicant:** Burroughs & Chapin Company, Inc.

**Authorized Agent:** Amanda L. Carrel, WESI Consulting, Inc.

**Scale:** not to scale

**Date:** 1/20/04

**Application #** 2003-1G-183

**Page:** 4 of 19

Compensatory Mitigation  
Credit Factors and Worksheets

**PRESERVATION MITIGATION FACTORS FOR WETLANDS  
AND OTHER WATERS OF THE U.S. EXCLUDING STREAMS**

Factors	Options				
	Priority Category	Tertiary 0.1		Secondary 0.2	Primary 0.4
Existing Condition	Impaired -0.1		Slightly Impaired 0	Fully Functional 0.1	
Degree of Threat	Low -0.1		Moderate 0.1		High 0.2
Control	Covenant Private 0	Covenant POA 0.1	Conservation Easement 0.4	Transfer Fee Title Conservancy 0.6	
Kind	Category 5 -0.1	Category 4 0	Category 3 0.1	Category 2 0.2	Category 1 0.3
Location	Zone 5 -0.1	Zone 4 0	Zone 3 0.1	Zone 2 0.2	Zone 1 0.3

Note: Preservation credit should generally be limited to those areas that qualify as Fully Functional or Slightly Impaired. Impaired sites should be candidates for enhancement or restoration credit, not preservation credit. In Special circumstances when Impaired sites are allowed preservation credit (e.g. within the scope of some OCRM wetland master planned projects), a negative factor will be used to calculate credits as per the matrix table.

Proposed Preservation Mitigation Worksheet

total preserved wetland acreage	9.18-acres
restoration/enhancement acreage	6.69-acres

Factors	Value/Lakes
Priority Category	0.4
Existing Condition	0.1
Degree of Threat	0.1
Control	0
Kind	0.3
Location	0.3
Sum of M Factors	$M_1 = 1.2$
Mitigation Area	$AA_1 = 2.49$
$M \times A$	2.99

Total Preservation Credits = Sum of All (M x A) = 2.99

Total Restoration Acreage = 2.49

Sheet Title: Preservation Credit Calculation	
Project Title: Pine Lakes Permit Application	
Project Location: Myrtle Beach, South Carolina	
Applicant: Burroughs & Chapin Company, Inc.	
Authorized Agent: Amanda L. Carrel, WESI Consulting, Inc.	
Scale: not to scale	Date: 1/20/04
Application # 2003-1G-183	Page: 5 of 19

**Compensatory Mitigation  
Credit Factors and Worksheets**

**MITIGATION SUMMARY WORKSHEET  
WETLANDS AND OTHER WATERS OF THE U.S. EXCLUDING STREAMS**

Mitigation Summary Worksheet for Permit Application# \_\_\_\_\_

**I. Required Mitigation**

A. Total Required Mitigation Credits = 113.09 for 9.92-acres of impact

**II. Non-Banking Mitigation Credit Summary**

	Credits	Acres
B. Creation	0	0
C. Restoration and/or Enhancement (Non-Buffer Enhancement)	0	0
D. Restoration and/or Enhancement (Buffer Enhancement)	19.4	6.69
E. Total No Net Loss Non-Bank Mitigation = B + C + D	19.4	6.69
F. Preservation	2.99	2.48
G. Total Proposed Non-Bank Mitigation = E + F	22.39	9.17

**III. Banking Mitigation Credit Summary**

	Credits	Acres
H. Creation	0	0
I. Restoration and/or Enhancement (Non-Buffer Enhancement)	102.37	0
J. Restoration and/or Enhancement (Buffer Enhancement)	0	0
K. Total No Net Loss Bank Mitigation = H + I + J	102.37	0
L. Preservation	0	0
M. Total Proposed Bank Mitigation = K + L	102.37	0.00

**IV. Grand Totals**

	Credits	Acres
N. Total Preservation Mitigation = F + L	2.99	2.48
O. Total Non-Preservation Mitigation = E + K	121.77	6.69
P. Total Creation = B + H	0.00	0.00
Q. Total Restoration and/or Enhancement (Non-Buffer Enhancement) = C + I	102.37	0.00
R. Total Proposed Mitigation = G + M	124.76	9.17

The total Mitigation Credits (Row R) should be equal to or greater than the total Required Mitigation Credits (Row A) for the proposed mitigation to be acceptable. The other requirements given in the SOP must also be satisfied, e.g., in the credits column, Row O must equal at least 50% of Row A and the addition of Row P and Row Q must equal at least 25% of Row A. If the answer to either of the questions below is NO, then the proposed mix and/or quantity of mitigation is not in compliance with the policy and the plan should be revised or rejected, unless a variance is approved.

	TRUE	FALSE
$PMC \geq RMC$ or in words Are the credits in Row R greater than or equal to Row A?	TRUE	
$PMC_{Non-Preservation} \geq 1/2 RMC$ or in words Are the credits in Row O greater than or equal to 50% of Row A?	TRUE	
$PMC_{Creation + Restoration/Enhancement (Non-Buffer Enhancement)} \geq 1/4 RMC$ or in words Are the credits in Row P plus the credits in Row Q greater than or equal to 25% of Row A?	TRUE	

<b>Sheet Title:</b> Mitigation Credit Summary	
<b>Project Title:</b> Pine Lakes Permit Application	
<b>Project Location:</b> Myrtle Beach, South Carolina	
<b>Applicant:</b> Burroughs & Chapin Company, Inc.	
<b>Authorized Agent:</b> Amanda L. Carrel, WESI Consulting, Inc.	
<b>Scale:</b> not to scale	<b>Date:</b> 1/20/04
<b>Application #</b> 2003-16-183	<b>Page:</b> 6 of 19



# PINE LAKES SITE DATA AND LEGEND




GOLF COURSE RETENTION/DRAINAGE POND  
(USACE JURISDICTIONAL) TO BE FILLED

TOTAL = 4.24 ACRES



GOLF COURSE RETENTION (USACE JURISDICTIONAL)  
TO BE PRESERVED

TOTAL = 3.31 ACRES

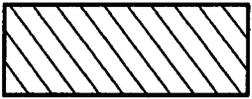


ISOLATED NON-JURISDICTIONAL WETLAND  
TO BE FILLED

TOTAL = 5.68 ACRES



ISOLATED NON-JURISDICTIONAL WETLAND  
TO BE PRESERVED

TOTAL = 5.87 AC.

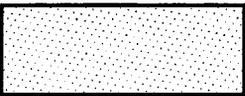


UPLAND BUFFER

TOTAL = 6.69 ACRES

Buffer Mean Width:

Single Family Residential=25 ft.  
Commercial=50ft.

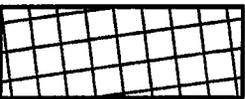

HAND CLEAR AREAS

TOTAL = 0.65 ACRES

Sheet Title: Legend

Project Title: Pine Lakes Permit Application

Project Location: Myrtle Beach, South Carolina

Applicant: Burroughs & Chapin Company, Inc.



Authorized Agent: Amanda L. Carrel, WESI Consulting, Inc.

Scale: Not To Scale

Date: 01/20/04

Application #: 2003-161-183


Page: 8 of 19

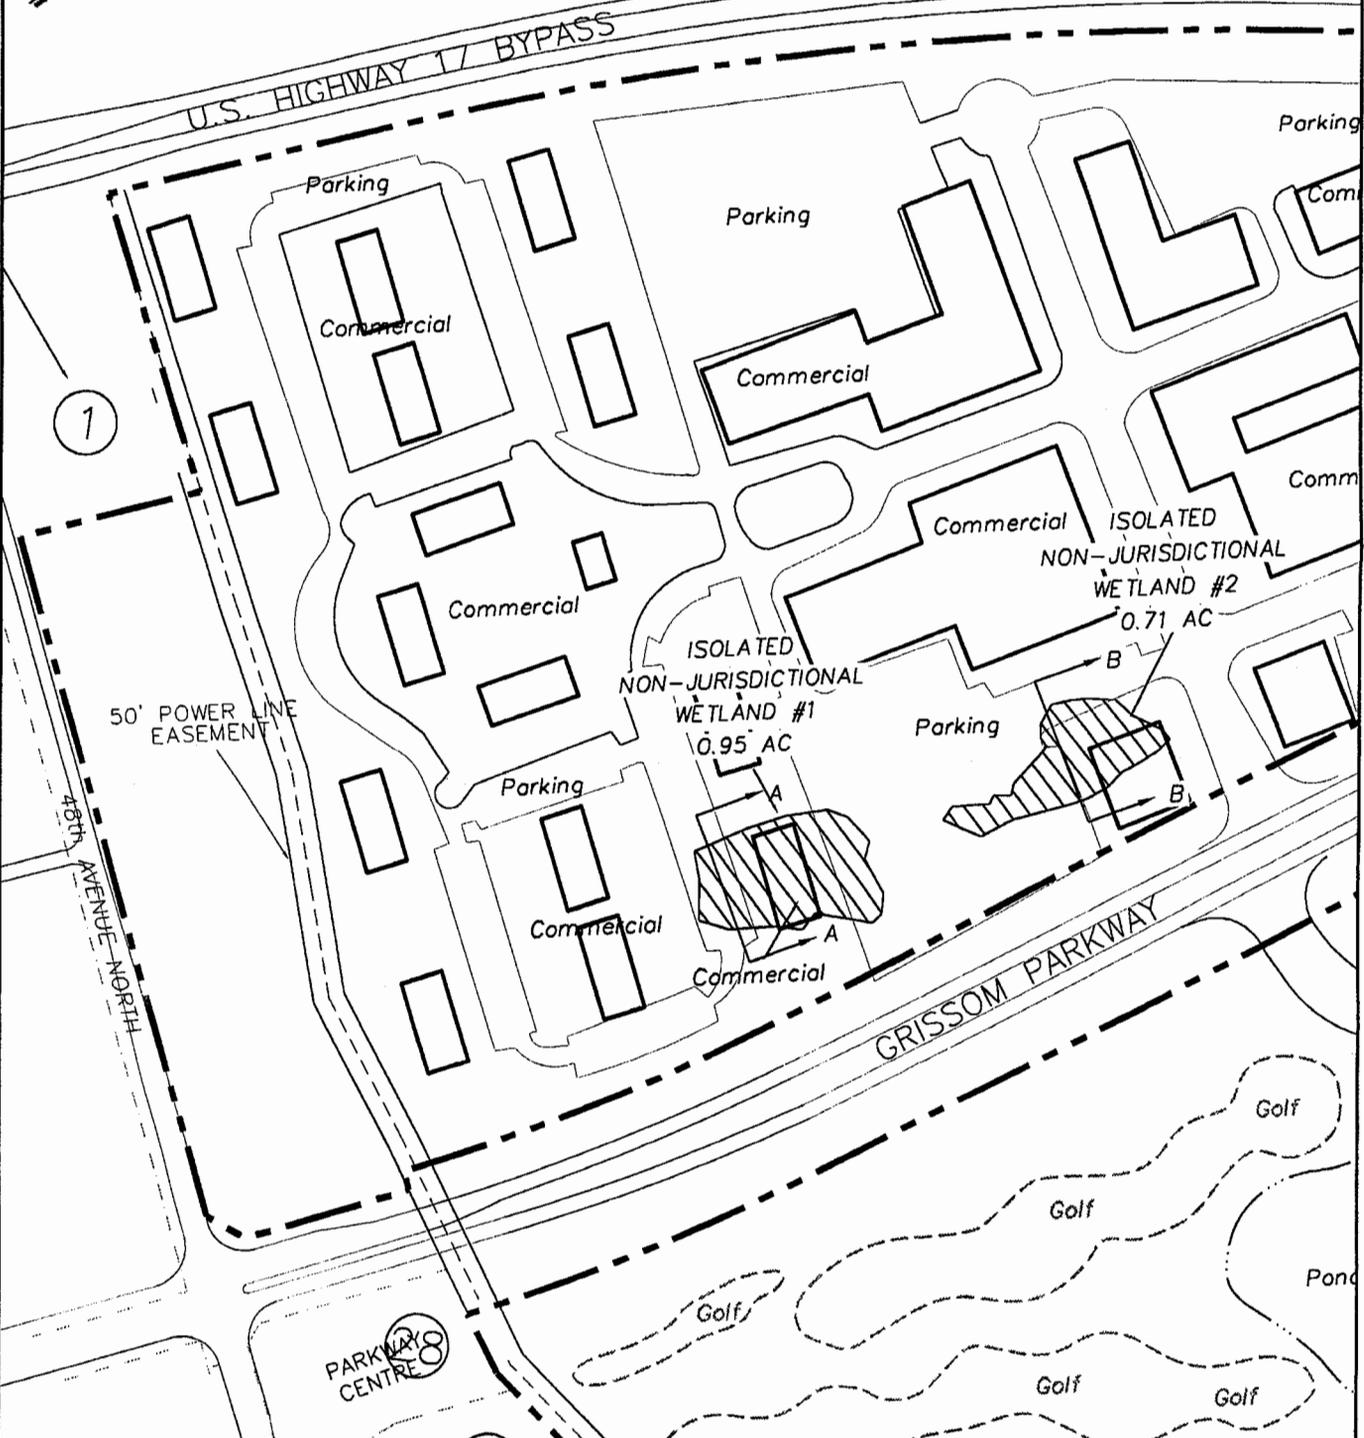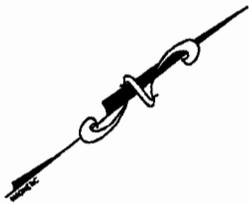

Sheet Title: Enlarged Site Plan	
Project Title: Pine Lakes Permit Application	
Project Location: Myrtle Beach, South Carolina	
Applicant: Burroughs & Chapin Company, Inc.	
Authorized Agent: Amanda L. Carrel, WESI Consulting, Inc.	
Scale: 1"=300'	Date: 01/20/04
Application #: 2003-16-183	Page: 9 of 19


I:\WESI\PROJECTS\2003\CAD\IBC-P547-03-AC (PINE LAKES)\PINELAKES WETLAND MASTER PLAN 01.DWG, 1/19/2004 1:23:40 PM

\\WESI\PROJECTS\2003\CAD\BC-P547-03-AC (PINE LAKES)\PINELAKES WETLAND MASTER PLAN 01.DWG, 1/19/2004 1:23:20 PM

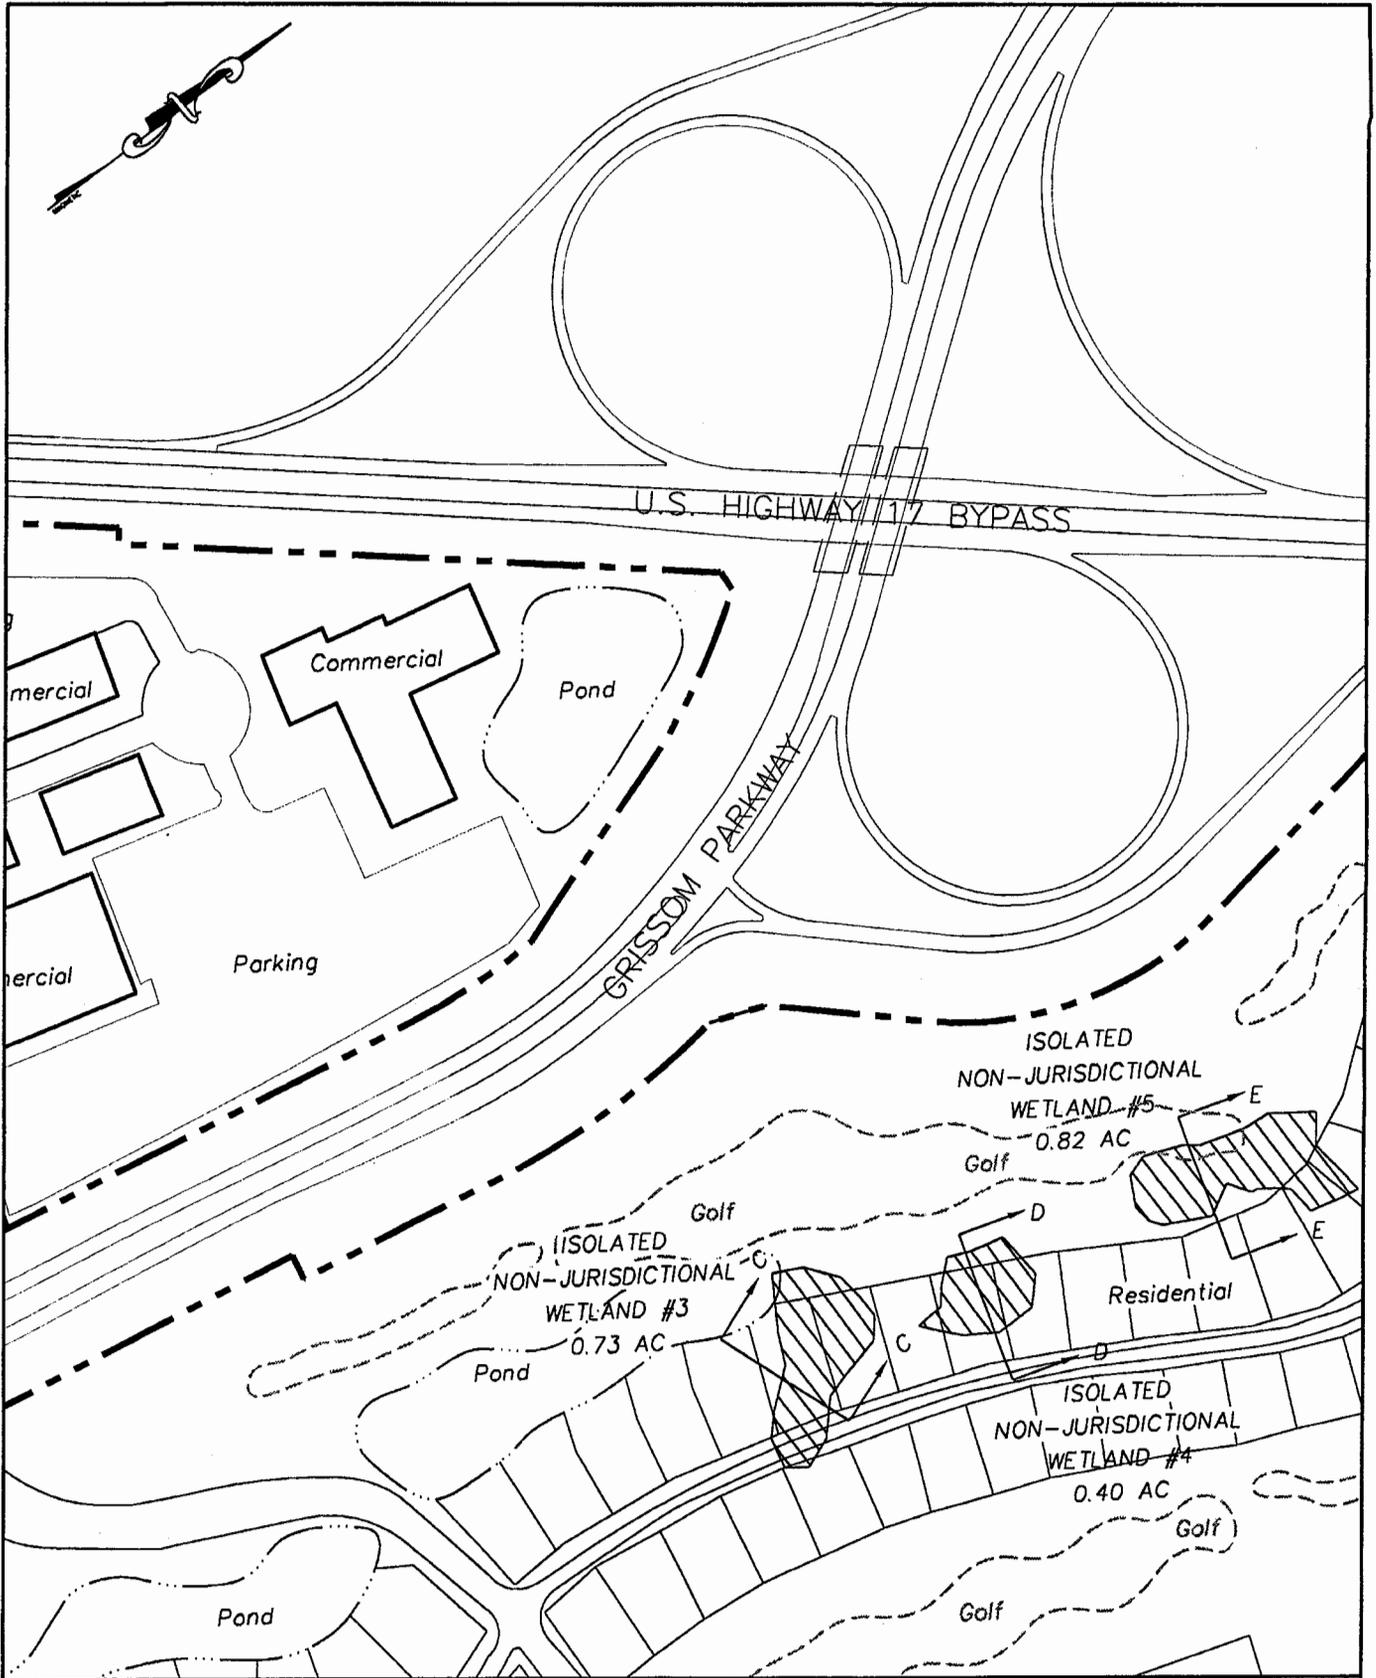


Sheet Title: Enlarged Site Plan	
Project Title: Pine Lakes Permit Application	
Project Location: Myrtle Beach, South Carolina	
Applicant: Burroughs & Chapin Company, Inc.	
Authorized Agent: Amanda L. Carrel, WESI Consulting, Inc.	
Scale: 1"=300'	Date: 01/20/04
Application #: 2003-1G-183	Page: 10 of 19

\\WES\PROJECTS\2003\CAD\IBC-P547-03-AC (PINE LAKES)\PINELAKES WETLAND MASTER PLAN 01.DWG, 1/28/2004 4:24:41 PM

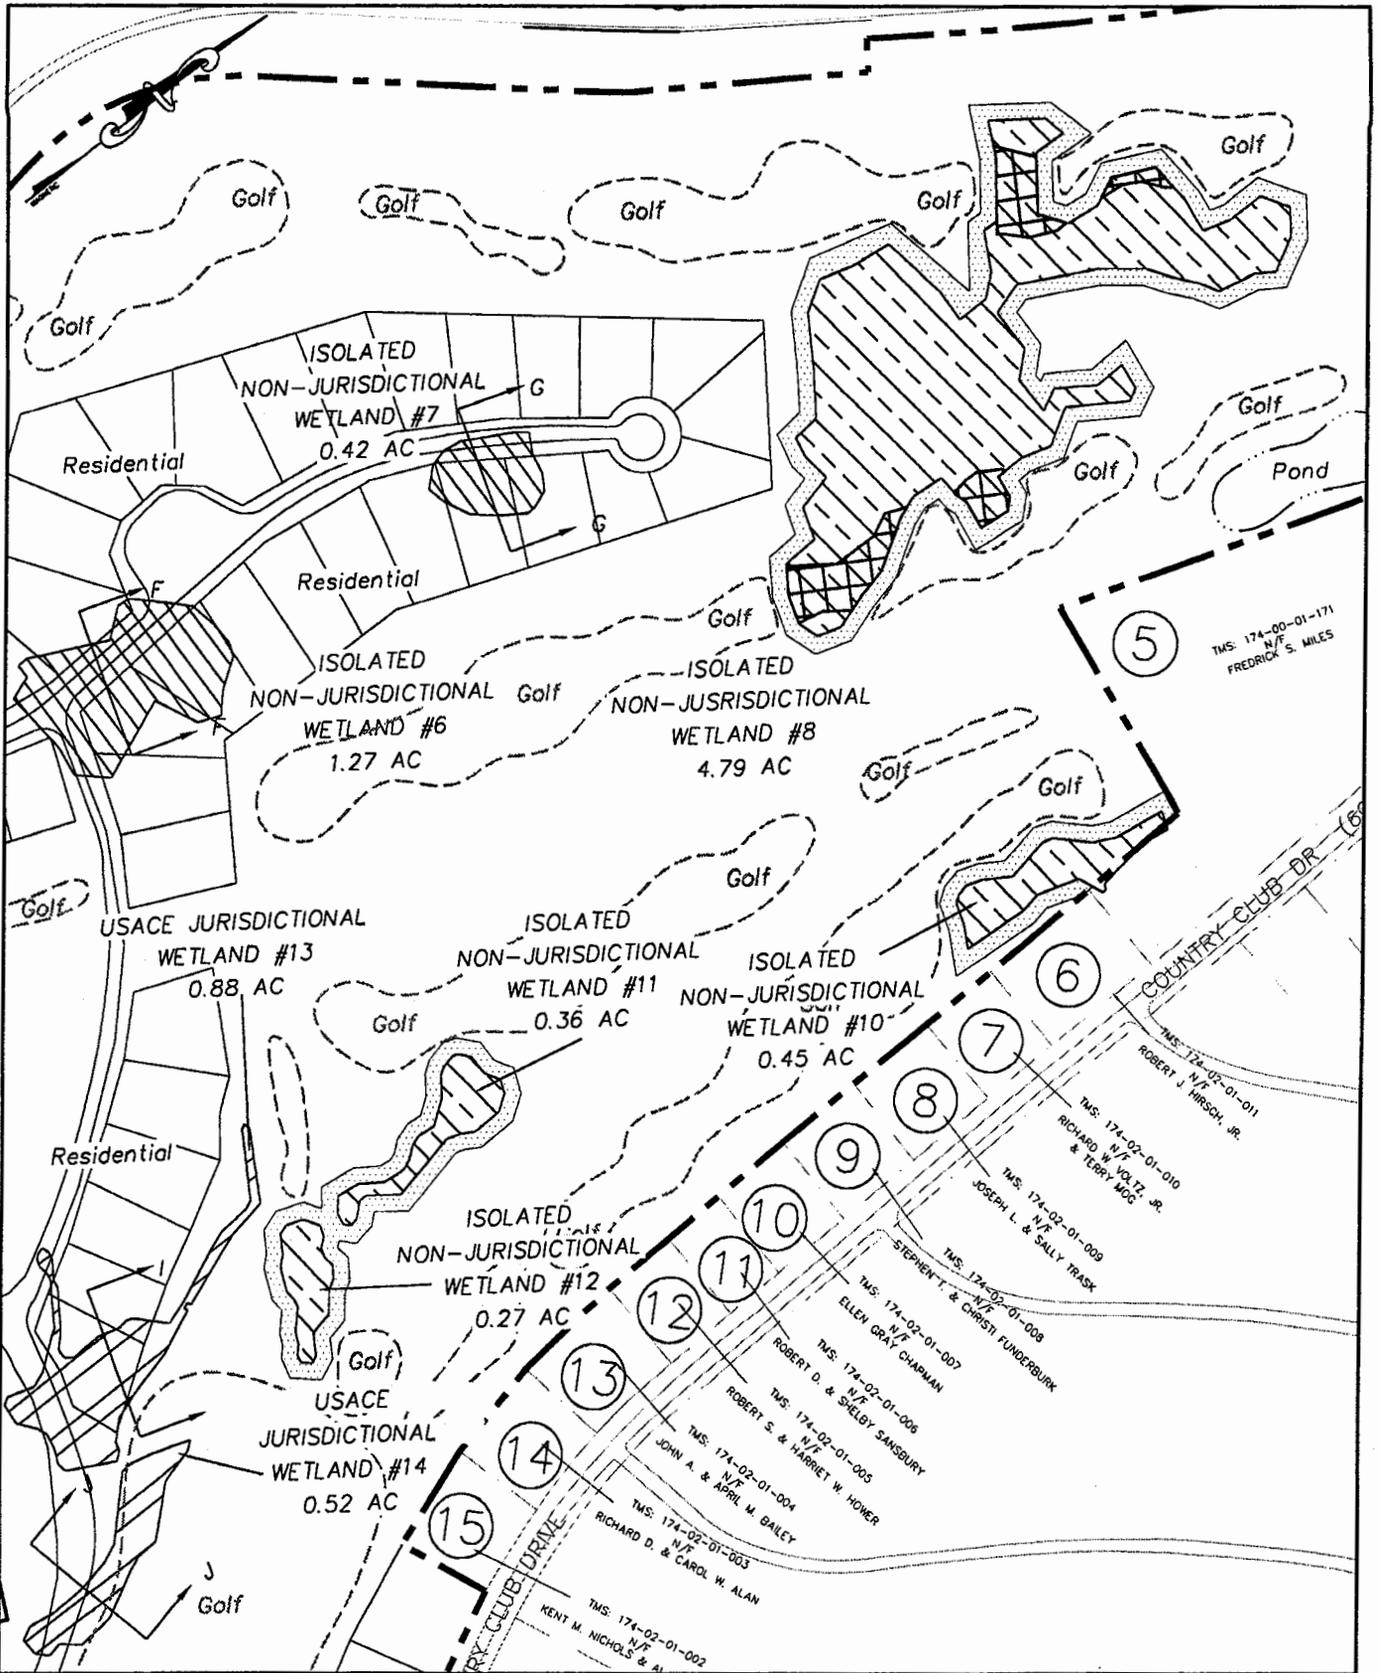


Sheet Title: Enlarged Site Plan	
Project Title: Pine Lakes Permit Application	
Project Location: Myrtle Beach, South Carolina	
Applicant: Burroughs & Chapin Company, Inc.	
Authorized Agent: Amanda L. Carrel, WESI Consulting, Inc.	
Scale: 1"=300'	Date: 01/20/04
Application #: 2003-16-183	Page: 11 of 19

I:\WESI\PROJECTS\2003\CAD\IBC-PS47-03-AC (PINE LAKES)\PINE LAKES WETLAND MASTER PLAN 01.DWG, 1/19/2004 1:24:17 PM

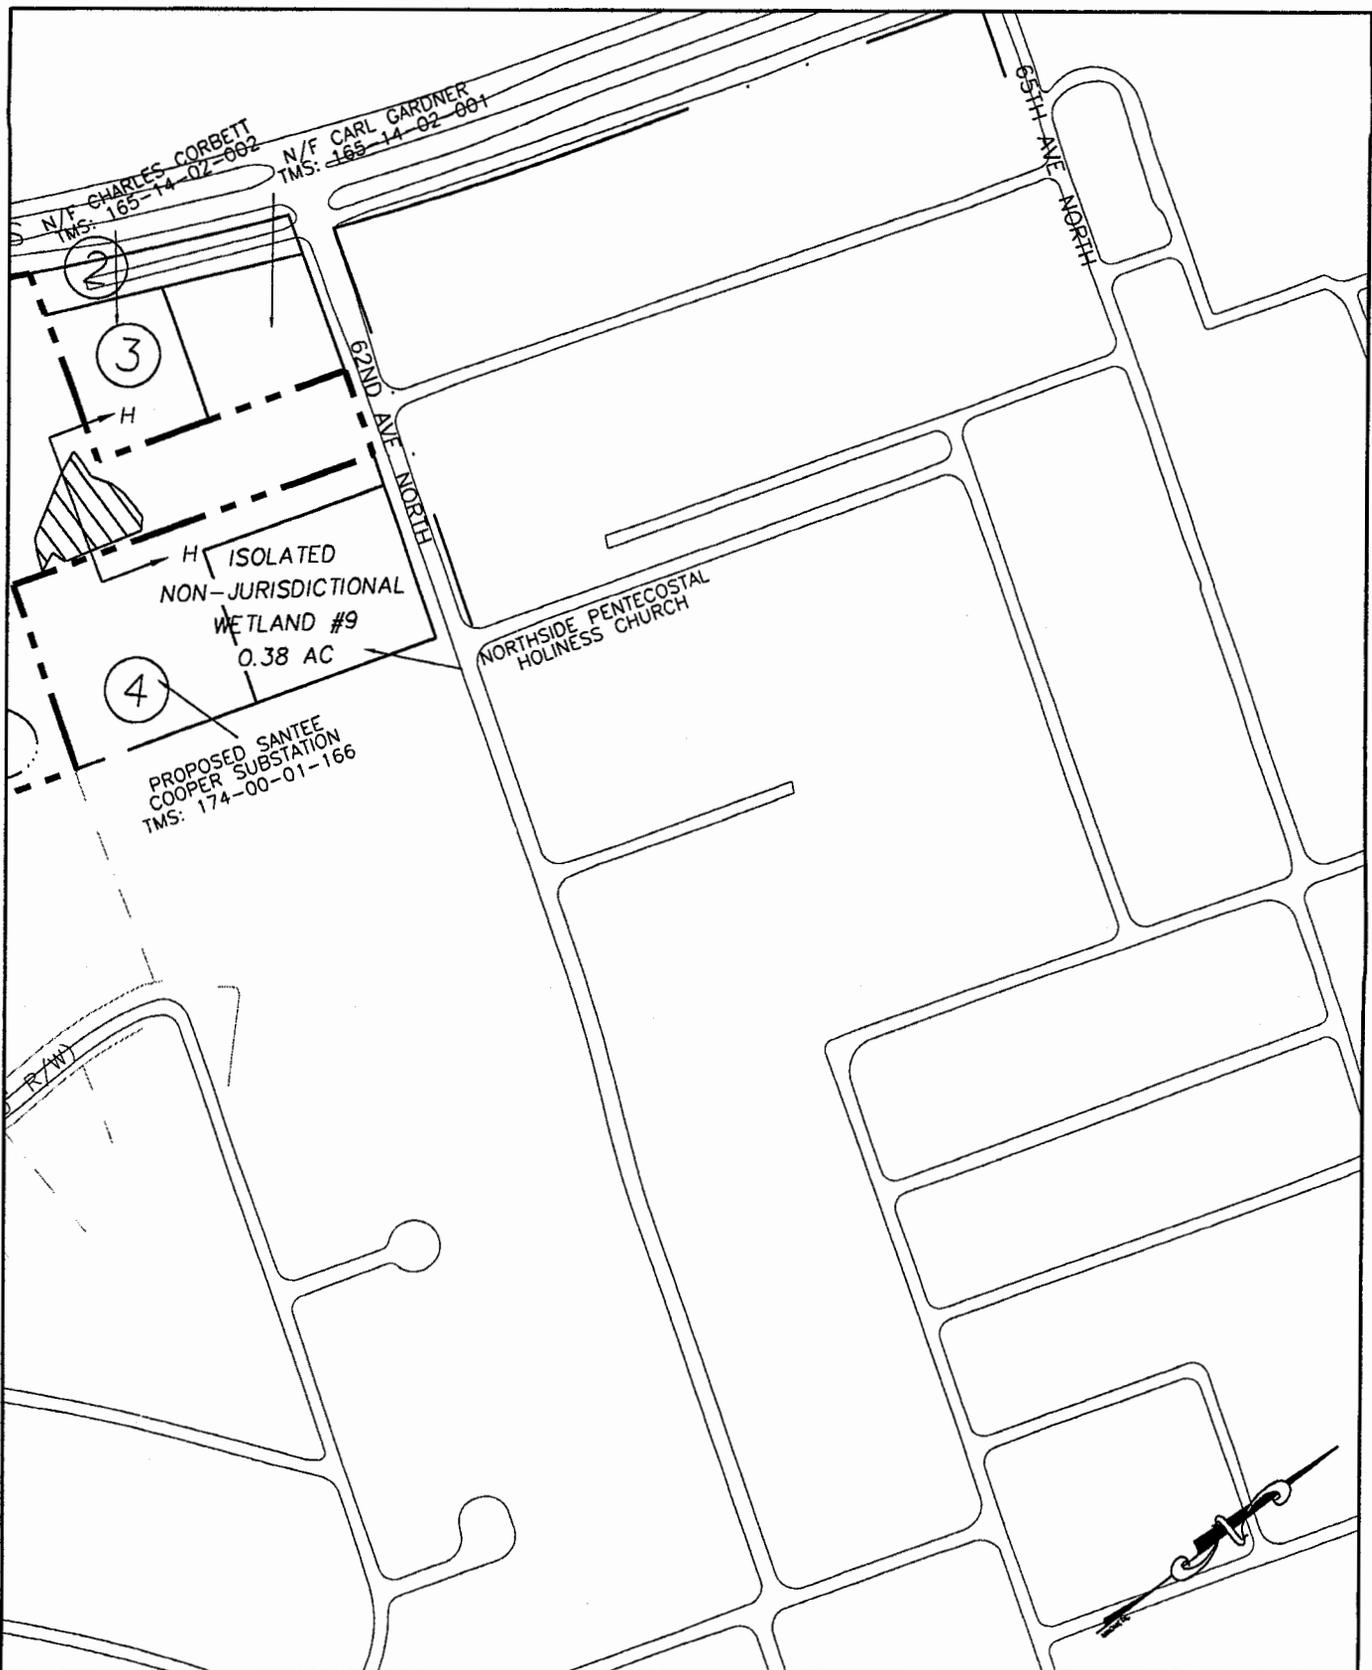


Sheet Title: Enlarged Site Plan	
Project Title: Pine Lakes Permit Application	
Project Location: Myrtle Beach, South Carolina	
Applicant: Burroughs & Chapin Company, Inc.	
Authorized Agent: Amanda L. Carrel, WESI Consulting, Inc.	
Scale: 1"=300'	Date: 01/20/04
Application #: 2003-16-183	Page: 12 of 19

\\WES\PROJECTS\2003\CAD\BC-P547-03-AC (PINE LAKES)\PINELAKES WETLAND MASTER PLAN 01.DWG, 1/28/2004 5:15:40 PM

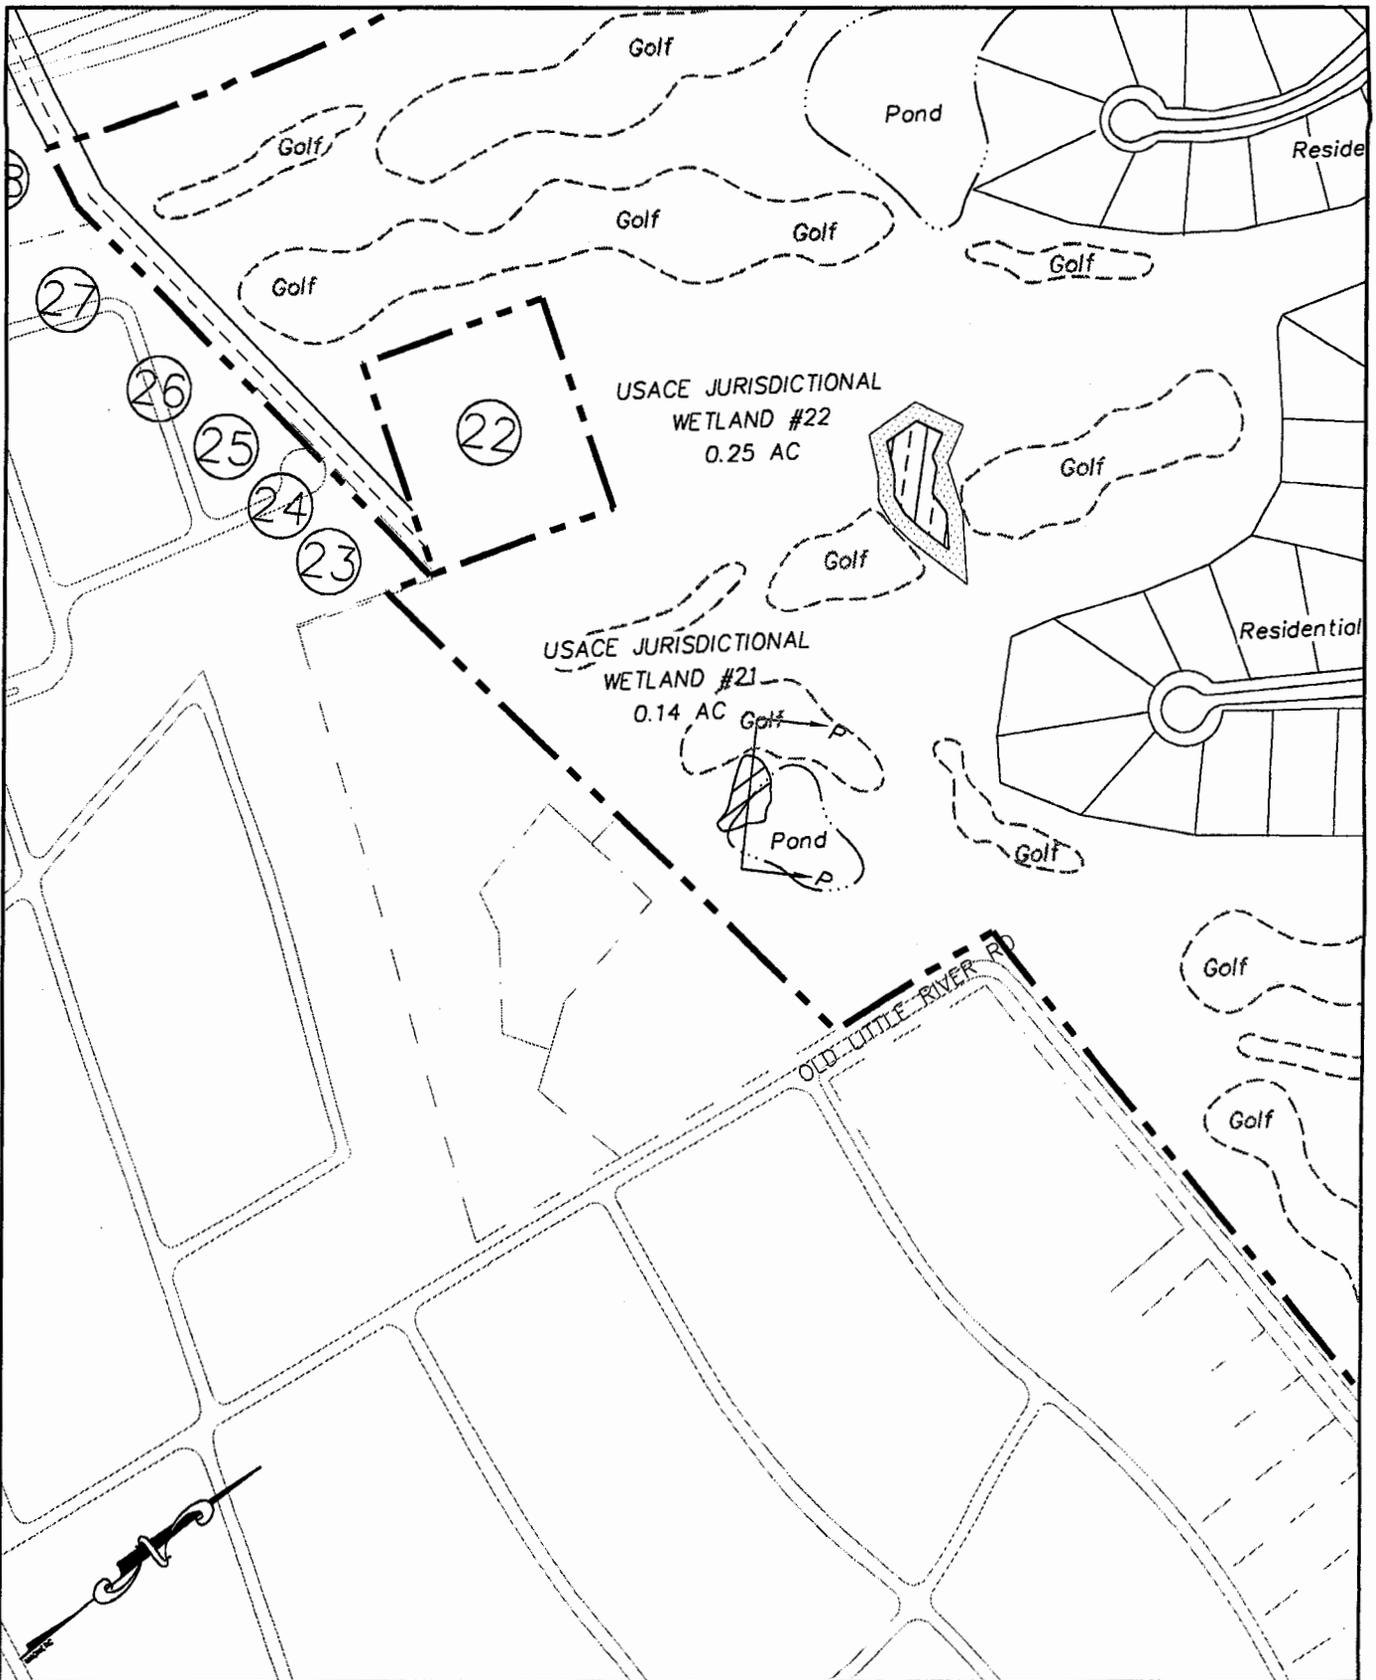


Sheet Title: Enlarged Site Plan	
Project Title: Pine Lakes Permit Application	
Project Location: Myrtle Beach, South Carolina	
Applicant: Burroughs & Chapin Company, Inc.	
Authorized Agent: Amanda L. Carrel, WESI Consulting, Inc.	
Scale: 1"=300'	Date: 01/20/04
Application #: 2003-1G-183	Page: 13 of 19

I:\WES\PROJECTS\2003\CAD\BC-P547-03-AC (PINE LAKES)\PINE LAKES WETLAND MASTER PLAN 01.DWG, 1/28/2004 5:13:40 PM

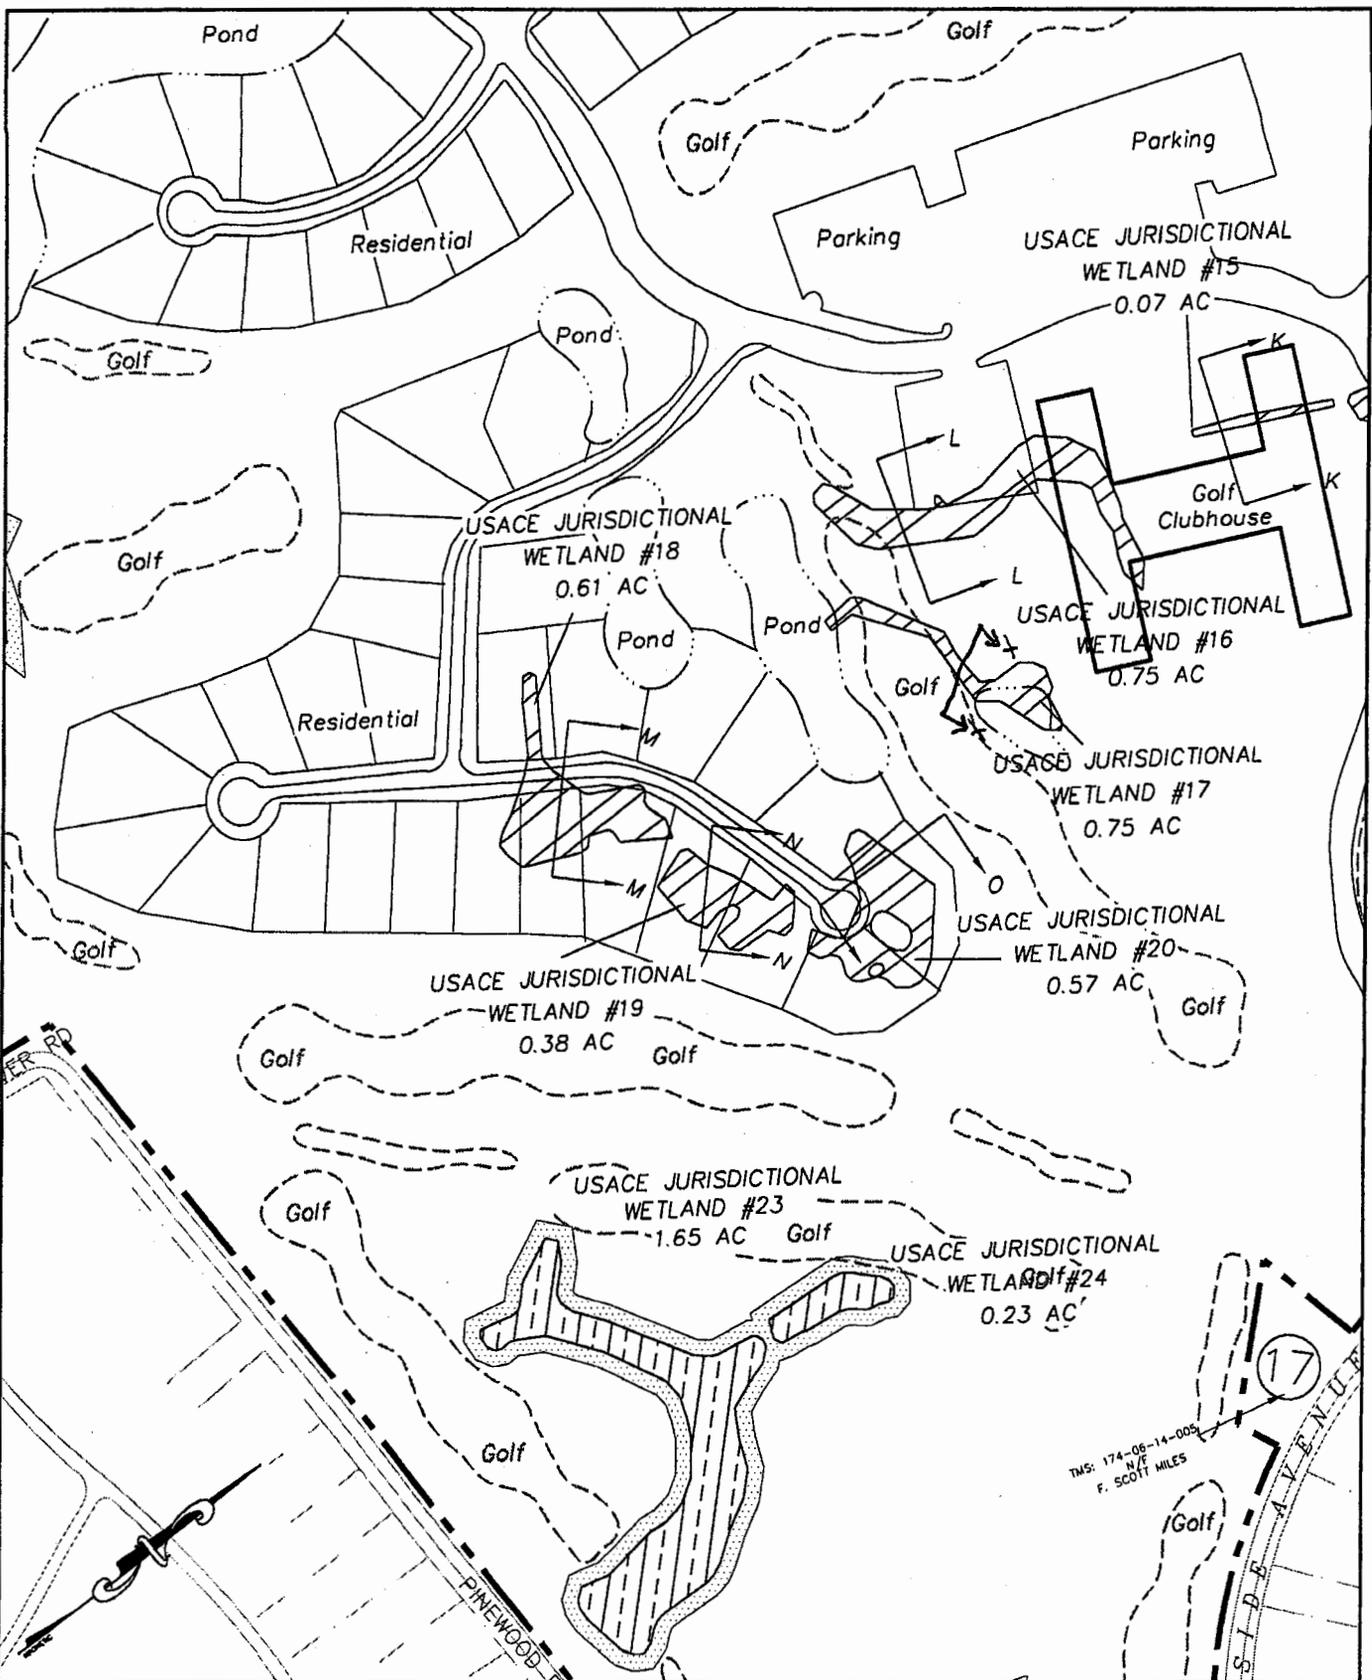


Sheet Title: Enlarged Site Plan	
Project Title: Pine Lakes Permit Application	
Project Location: Myrtle Beach, South Carolina	
Applicant: Burroughs & Chapin Company, Inc.	
Authorized Agent: Amanda L. Carrel, WESI Consulting, Inc.	
Scale: 1"=300'	Date: 01/20/04
Application #: 2003-1G-183	Page: 14 of 19

\\WES\PROJECTS\2003\CAD\BC-P547-03-AC (PINE LAKES)\PINE LAKES WETLAND MASTER PLAN 01.DWG, 1/28/2004 5:13:20 PM

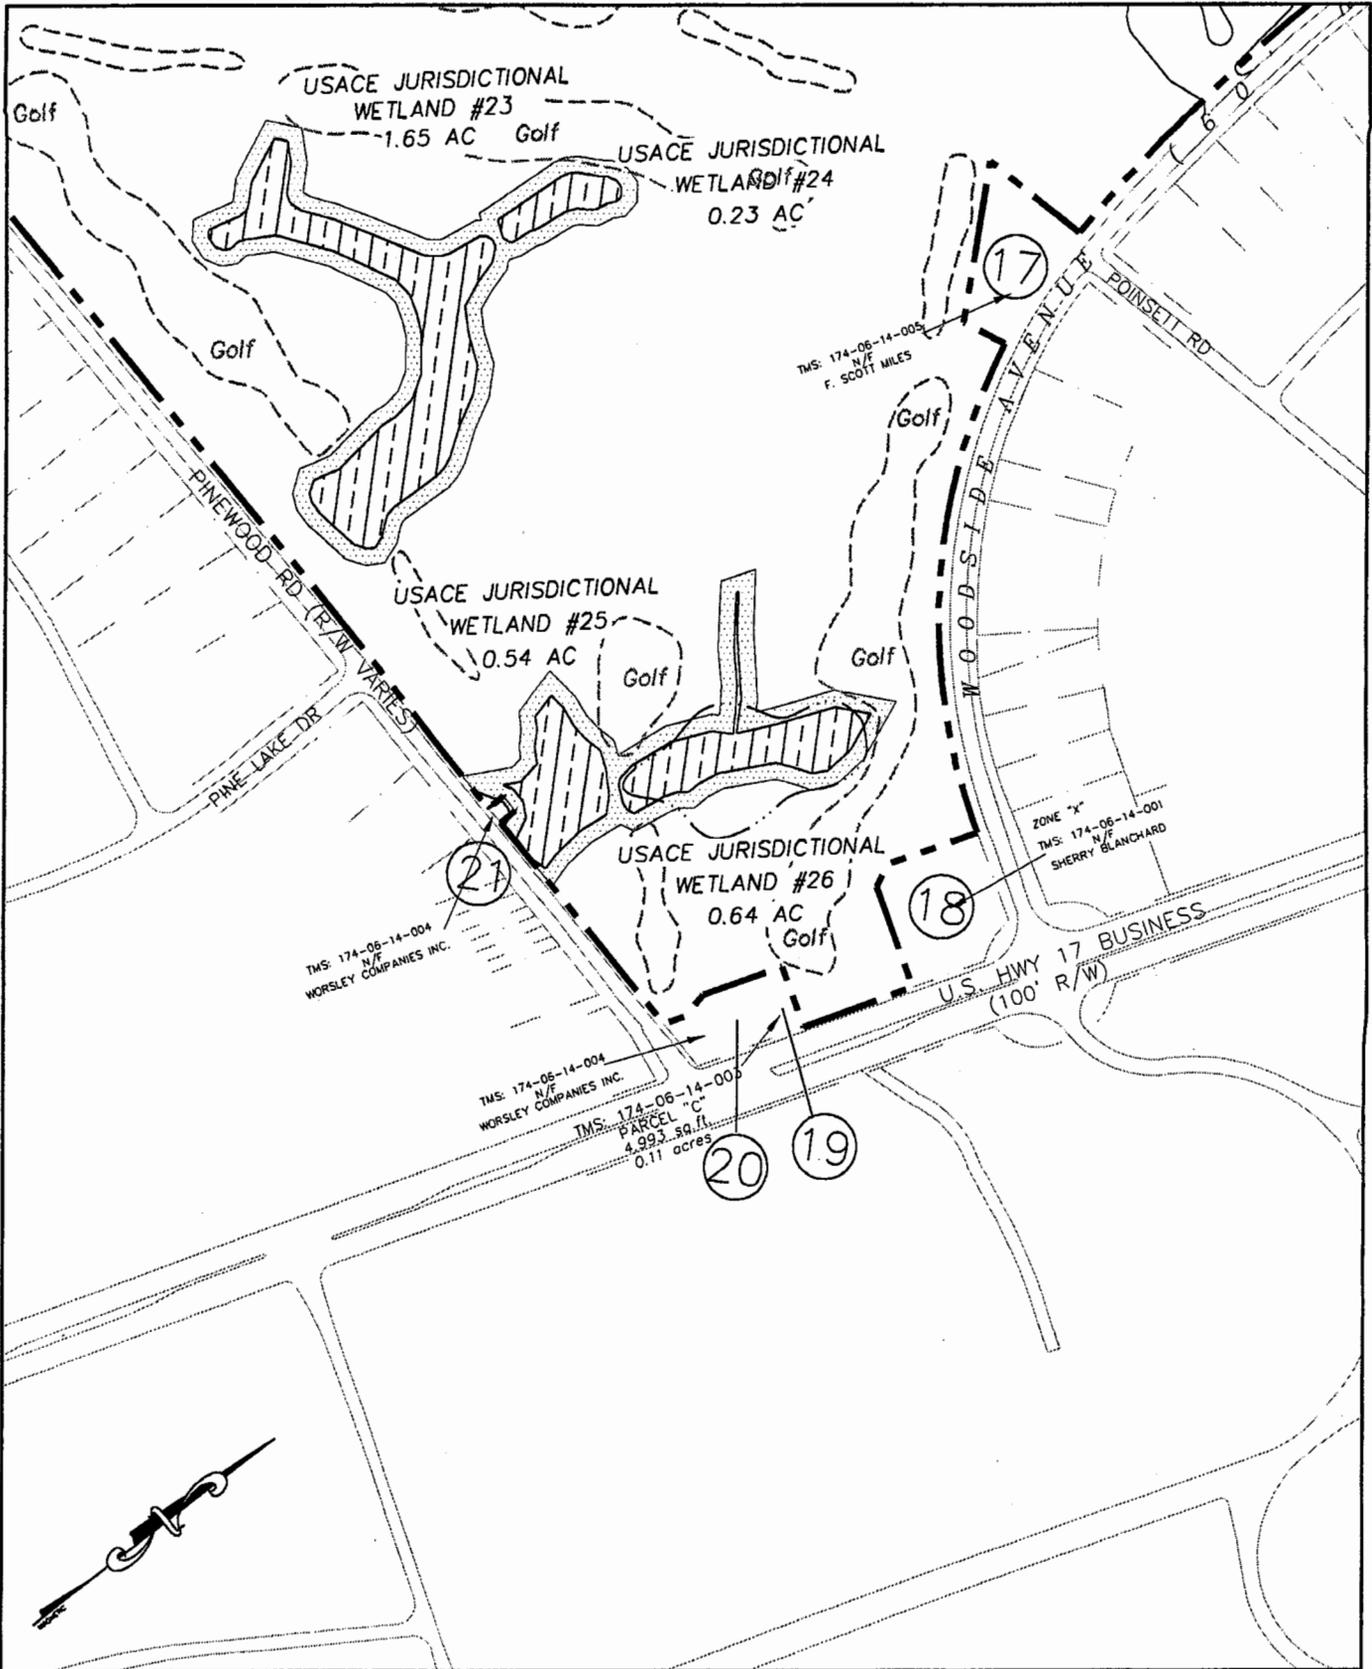


Sheet Title: Enlarged Site Plan	
Project Title: Pine Lakes Permit Application	
Project Location: Myrtle Beach, South Carolina	
Applicant: Burroughs & Chapin Company, Inc.	
Authorized Agent: Amanda L. Carrel, WESI Consulting, Inc.	
Scale: 1"=300'	Date: 01/20/04
Application #: 2003-19-183	Page: 15 of 19


Wetland #1

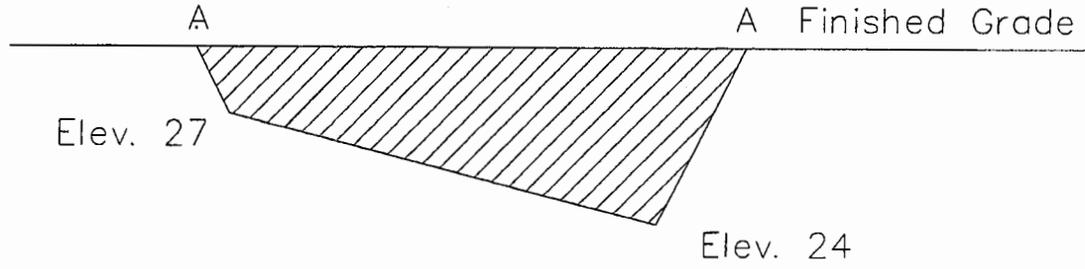


Wetland #2

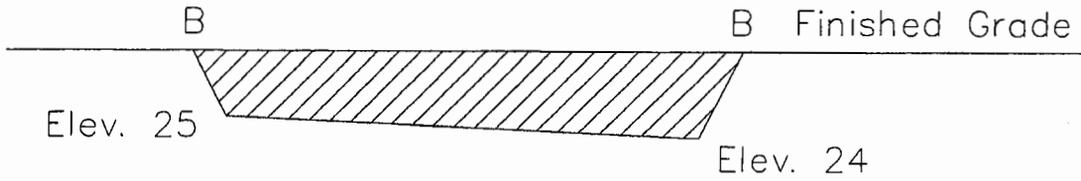

Wetland #3

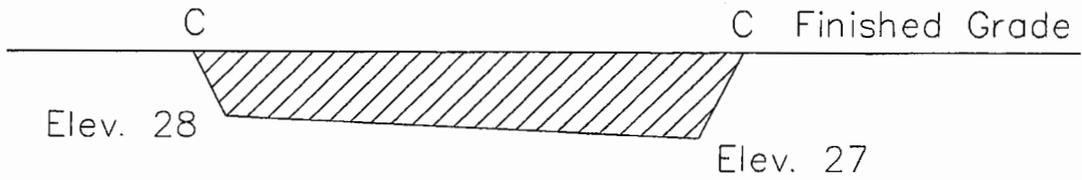


Wetland #4

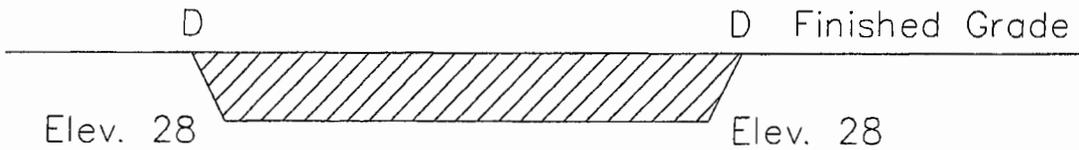


Sheet Title: Wetland Fill Cross Sections	
Project Title: Pine Lakes Permit Application	
Project Location: Myrtle Beach, South Carolina	
Applicant: Burroughs & Chapin Company, Inc.	
Authorized Agent: Amanda L. Carrel, WESI Consulting, Inc.	
Scale: Not To Scale	Date: 01/20/04
Application #: 2003-16-183	Page: 16 of 19


Wetland #5

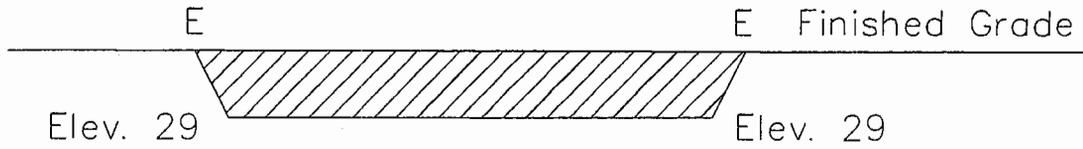


Wetland #6

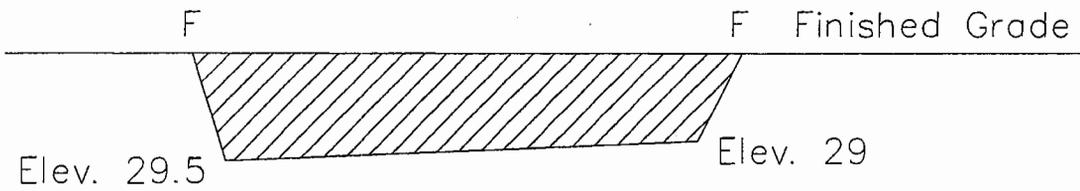

Wetland #7

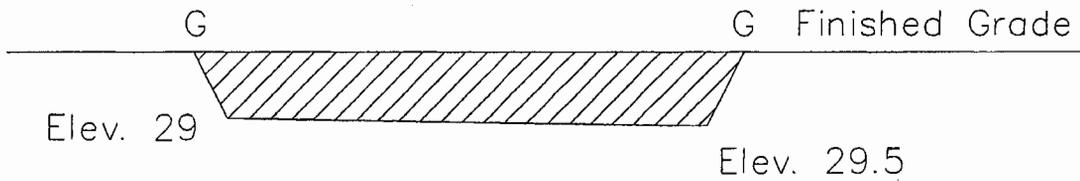

Wetland #9

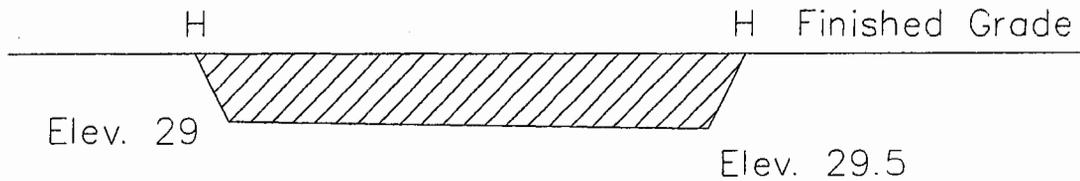

Sheet Title: Wetland Fill Cross Sections

Project Title: Pine Lakes Permit Application

Project Location: Myrtle Beach, South Carolina

Applicant: Burroughs & Chapin Company, Inc.

Authorized Agent: Amanda L. Carrel, WESI Consulting, Inc.


Scale: Not To Scale

Date: 01/20/04


Application #: 2003-16-183

Page: 17 of 19


Wetland #13

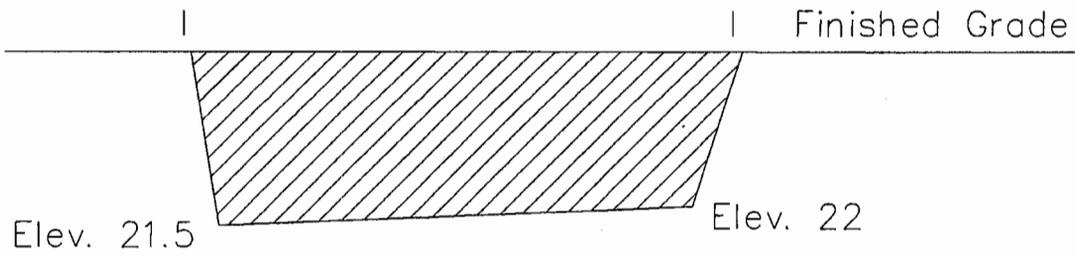


Wetland #14

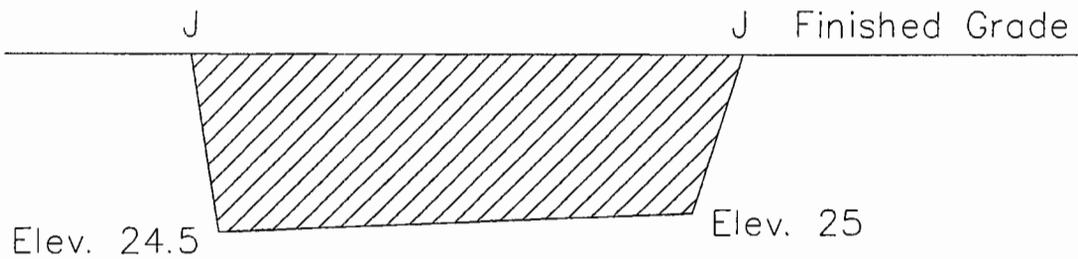

Wetland #15

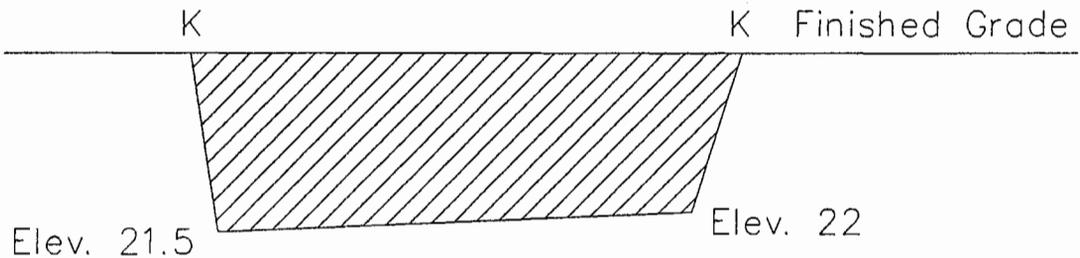

Wetland #16

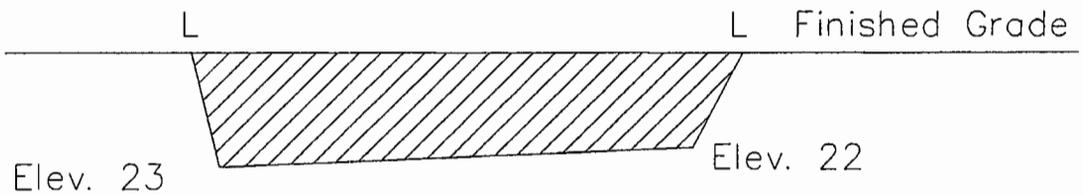

Sheet Title: Wetland Fill Cross Sections

Project Title: Pine Lakes Permit Application

Project Location: Myrtle Beach, South Carolina

Applicant: Burroughs & Chapin Company, Inc.

Authorized Agent: Amanda L. Carrel, WESI Consulting, Inc.


Scale: Not To Scale

Date: 01/20/04

Application #: 2003-16-183


Page: 18 of 19

Wetland #17

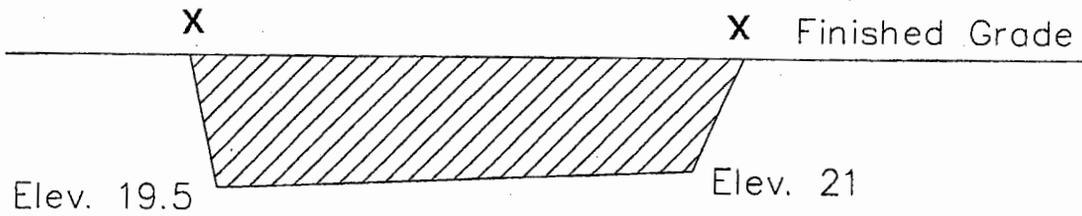


Sheet Title: Wetland Fill Cross Sections	
Project Title: Pine Lakes Permit Application	
Project Location: Myrtle Beach, South Carolina	
Applicant: Burroughs & Chapin Company, Inc.	
Authorized Agent: Amanda L. Carrel, WESI Consulting, Inc.	
Scale: not to scale	Date: 1/20/04
Application # 2003-1G-183	Page: 19a of 19


### Wetland #18

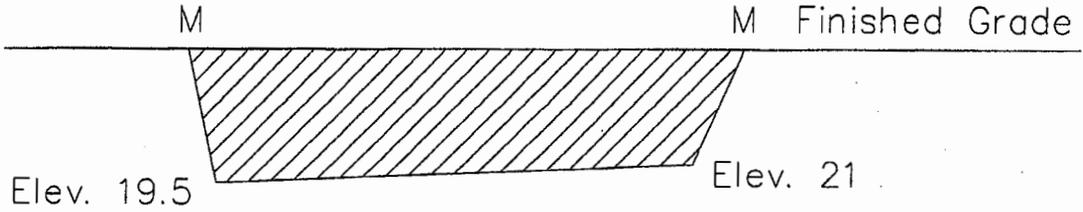


### Wetland #19

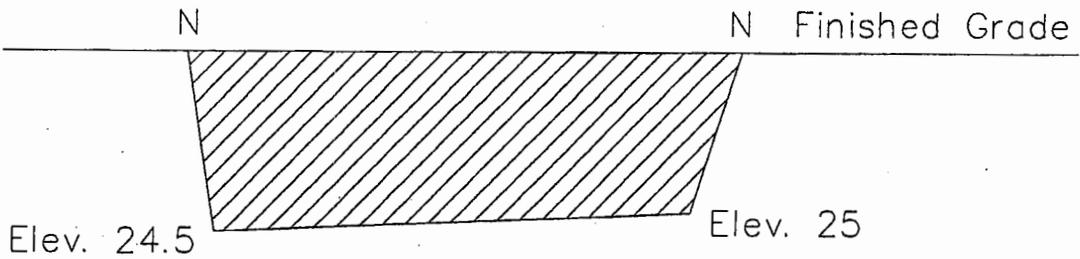

### Wetland #20

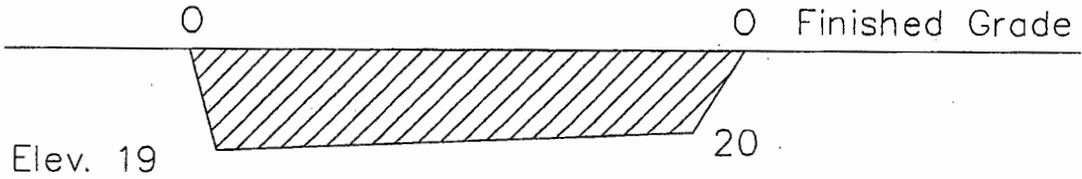

### Wetland #21

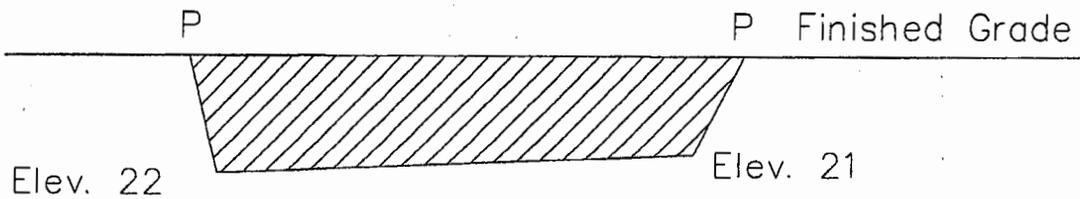

Sheet Title: Wetland Fill Cross Sections

Project Title: Pine Lakes Permit Application

Project Location: Myrtle Beach, South Carolina

Applicant: Burroughs & Chapin Company, Inc.

Authorized Agent: Amanda L. Carrel, WESI Consulting, Inc.

Scale: Not To Scale

Date: 01/20/04

Application #: 2003-1G-183

Page: 19b of 19