

**JOINT**  
**PUBLIC NOTICE**

**CHARLESTON DISTRICT, CORPS OF ENGINEERS**

**69A Hagood Avenue**

**Charleston, South Carolina 29403-5107**

**and**

**THE S.C. DEPARTMENT OF HEALTH AND ENVIRONMENTAL CONTROL**

**Water Quality Certification and Wetlands Section**

**2600 Bull Street**

**Columbia, South Carolina 29201**

REGULATORY DIVISION

Refer to: P/N SAC-2019-01861

March 4, 2022

Pursuant to Section 10 of the Rivers and Harbors Act of 1899 (33 U.S.C. 403), Sections 401 and 404 of the Clean Water Act (33 U.S.C. 1344), and the South Carolina Coastal Zone Management Act (48-39-10 et seq.), an application has been submitted to the Department of the Army and the S.C. Department of Health and Environmental Control by

**South Carolina Department of Transportation (SCDOT)**

**c/o Mr. Jeff Sicheloff**

**955 Park Street**

**Columbia, South Carolina 29210**

for a permit to place fill material in wetlands and other waters of the United States to facilitate shoulder improvements for US-17 Alternate in

**waters that drain to the Edisto River and Ashley River**

along US-17A from the Edisto River to the Ashley River in Ridgeville, Dorchester County, South Carolina (Start Latitude: 32.9269 °, Start Longitude: -80.3976 °; End Latitude: 32.9685 °, End Longitude: -80.2530 °), Quad Sheets – Jacksonboro, SC (2020), Osborn, SC (2020) Ravenel, SC (2020) and Johns Island, SC (2020).

In order to give all interested parties an opportunity to express their views

**NOTICE**

is hereby given that written statements regarding the proposed work will be received by the **Corps** until

**15 Days from the Date of this Notice,**

and **SCDHEC** will receive written statements regarding the proposed work until

### 30 Days from the Date of this Notice

from those interested in the activity and whose interests may be affected by the proposed work.

The proposed work consists of 9 miles of safety improvement to the existing US-17A roadway in Dorchester County. In detail, 13,860 cubic yards of fill material would be discharged into a total of 69 linear feet (0.01 acre) of two tributaries and 4.283 acres of 23 freshwater wetlands to facilitate shoulder widening, pipe extensions, and rip-rap scour protection. Additionally, a total of 2.323 acres of 24 freshwater wetlands would be mechanically cleared to accommodate construction and to maintain sediment and erosion control best management practices. The applicant has proposed to mitigate for impacts to wetlands and/or waters of the United States by purchasing 77.9 wetland mitigation credits from the Caton Creek Mitigation Bank and 194.9 stream mitigation credits from a Corps approved mitigation bank. The project purpose is to improve safety of the roadway for the traveling public.

**NOTE: This public notice and associated plans are available on the Corps' website at: <http://www.sac.usace.army.mil/Missions/Regulatory/PublicNotices>.**

The District Engineer has concluded that the discharges associated with this project, both direct and indirect, should be reviewed by the South Carolina Department of Health and Environmental Control in accordance with provisions of Section 401 of the Clean Water Act. As such, this notice constitutes a request, on behalf of the applicant, for certification that this project will comply with applicable effluent limitations and water quality standards. The work shown on this application must also be certified as consistent with applicable provisions of the Coastal Zone Management Program (15 CFR 930). This activity may also require evaluation for compliance with the S. C. Construction in Navigable Waters Permit Program. State review, permitting and certification is conducted by the S. C. Department of Health and Environmental Control. The District Engineer will not process this application to a conclusion until such certifications are received. The applicant is hereby advised that supplemental information may be required by the State to facilitate the review. This Public Notice will serve as the notification to the Administrator of the Environmental Protection Agency (EPA) pursuant to section 401(a)(2) of the Clean Water Act.

This notice initiates the Essential Fish Habitat (EFH) consultation requirements of the Magnuson-Stevens Fishery Conservation and Management Act. Implementation of the proposed project would not impact estuarine substrates and emergent wetlands utilized by various life stages of species comprising the shrimp, and snapper-grouper management complexes. The District Engineer's initial determination is that the proposed action would not have a substantial individual or cumulative adverse impact on EFH or fisheries managed by the South Atlantic Fishery Management Council and the National Marine Fisheries Service (NMFS). The District Engineer's final determination relative to project impacts and the need for mitigation measures is subject to review by and coordination with the NMFS.

Pursuant to the Section 7 of the Endangered Species Act of 1973 (as amended), the Corps has reviewed the project area, examined all information provided by the applicant, and the District Engineer has determined, based on the most recently available information that the project will have no effect on any Federally endangered, threatened, or proposed species and will not result in the destruction or adverse modification of designated or proposed critical habitat. This public notice serves as a request to the U.S. Fish and Wildlife Service and the National Marine Fisheries Service for any additional information they may have on whether any listed or proposed endangered or threatened species or designated or proposed critical habitat may be present in the area which would be affected by the activity.

Pursuant to the Section 7 of the Endangered Species Act of 1973 (as amended), the Corps has reviewed the project area, examined all information provided by the applicant, and the District Engineer has determined that the project is not likely to adversely affect any Federally endangered, threatened, or proposed species or result in the destruction or adverse modification of designated or proposed critical habitat. This public notice serves as a request for written concurrence from the U.S. Fish and Wildlife Service and/or the National Marine Fisheries Service on this determination.

Pursuant to Section 106 of the National Historic Preservation Act (NHPA), this public notice also constitutes a request to Indian Tribes to notify the District Engineer of any historic properties of religious and cultural significance to them that may be affected by the proposed undertaking.

In accordance with Section 106 of the NHPA, the District Engineer has consulted South Carolina ArchSite (GIS), for the presence or absence of historic properties (as defined in 36 C.F.R. 800.16)(1)(1)), and has initially determined that historic properties, are present; moreover, these historic properties may be affected by the undertaking. This public notice serves to notify the State Historic Preservation Office that the Corps plans to initiate Section 106 consultation on these historic properties. Individuals or groups who would like to be consulting parties for the purposes of the NHPA should make such a request to the Corps in writing within 30 days of this public notice. To ensure that other historic properties that the District Engineer is not aware of are not overlooked, this public notice also serves as a request to the State Historic Preservation Office and other interested parties to provide any information they may have with regard to historic properties.

The District Engineer's final eligibility and effect determination will be based upon coordination with the SHPO and/or THPO, as appropriate and required and with full consideration given to the proposed undertaking's potential direct and indirect effects on historic properties within the Corps-identified permit area.


Any person may request, in writing, within the comment period specified in this notice, that a public hearing be held to consider this application. Requests for a public hearing shall state, with particularity, the reasons for holding a public hearing.


The decision whether to issue a permit will be based on an evaluation of the probable impact including cumulative impacts of the proposed activity on the public interest and will include application of the guidelines promulgated by the Administrator, Environmental Protection Agency (EPA), under authority of Section 404(b) of the Clean Water Act and, as appropriate, the criteria established under authority of Section 102 of the Marine Protection, Research and Sanctuaries Act of 1972, as amended. That decision will reflect the national concern for both protection and utilization of important resources. The benefit which reasonably may be expected to accrue from the project must be balanced against its reasonably foreseeable detriments. All factors which may be relevant to the project will be considered including the cumulative effects thereof; among those are conservation, economics, aesthetics, general environmental concerns, wetlands, historic properties, fish and wildlife values, flood hazards, flood plain values, land use, navigation, shoreline erosion and accretion, recreation, water supply and conservation, water quality, energy needs, safety, food and fiber production and, in general, the needs and welfare of the people. A permit will be granted unless the District Engineer determines that it would be contrary to the public interest. In cases of conflicting property rights, the Corps cannot undertake to adjudicate rival claims.


The Corps is soliciting comments from the public; Federal, state, and local agencies and officials; Indian Tribes; and other interested parties in order to consider and evaluate the impacts of this activity. Any comments received will be considered by the Corps to determine whether to issue, modify, condition or deny a permit for this project. To make this decision, comments are used to assess impacts on endangered species, historic properties, water quality, general environmental effects, and the other public interest factors listed above. Comments are used in the preparation of an Environmental Assessment and/or an Environmental Impact Statement pursuant to the National Environmental Policy Act. Comments are also used to determine the need for a public hearing and to determine the overall public interest of the activity. **Please submit comments in writing, identifying the project of interest by public notice number, to the following address:**

**U.S. Army Corps of Engineers  
ATTN: REGULATORY DIVISION  
69A Hagood Avenue  
Charleston, South Carolina 29403-5107**

If there are any questions concerning this public notice, please contact Jeremy M. Kinney, Project Manager, at (843) 329-8033, toll free at 1-866-329-8187, or by email at [Jeremy.M.Kinney@usace.army.mil](mailto:Jeremy.M.Kinney@usace.army.mil).

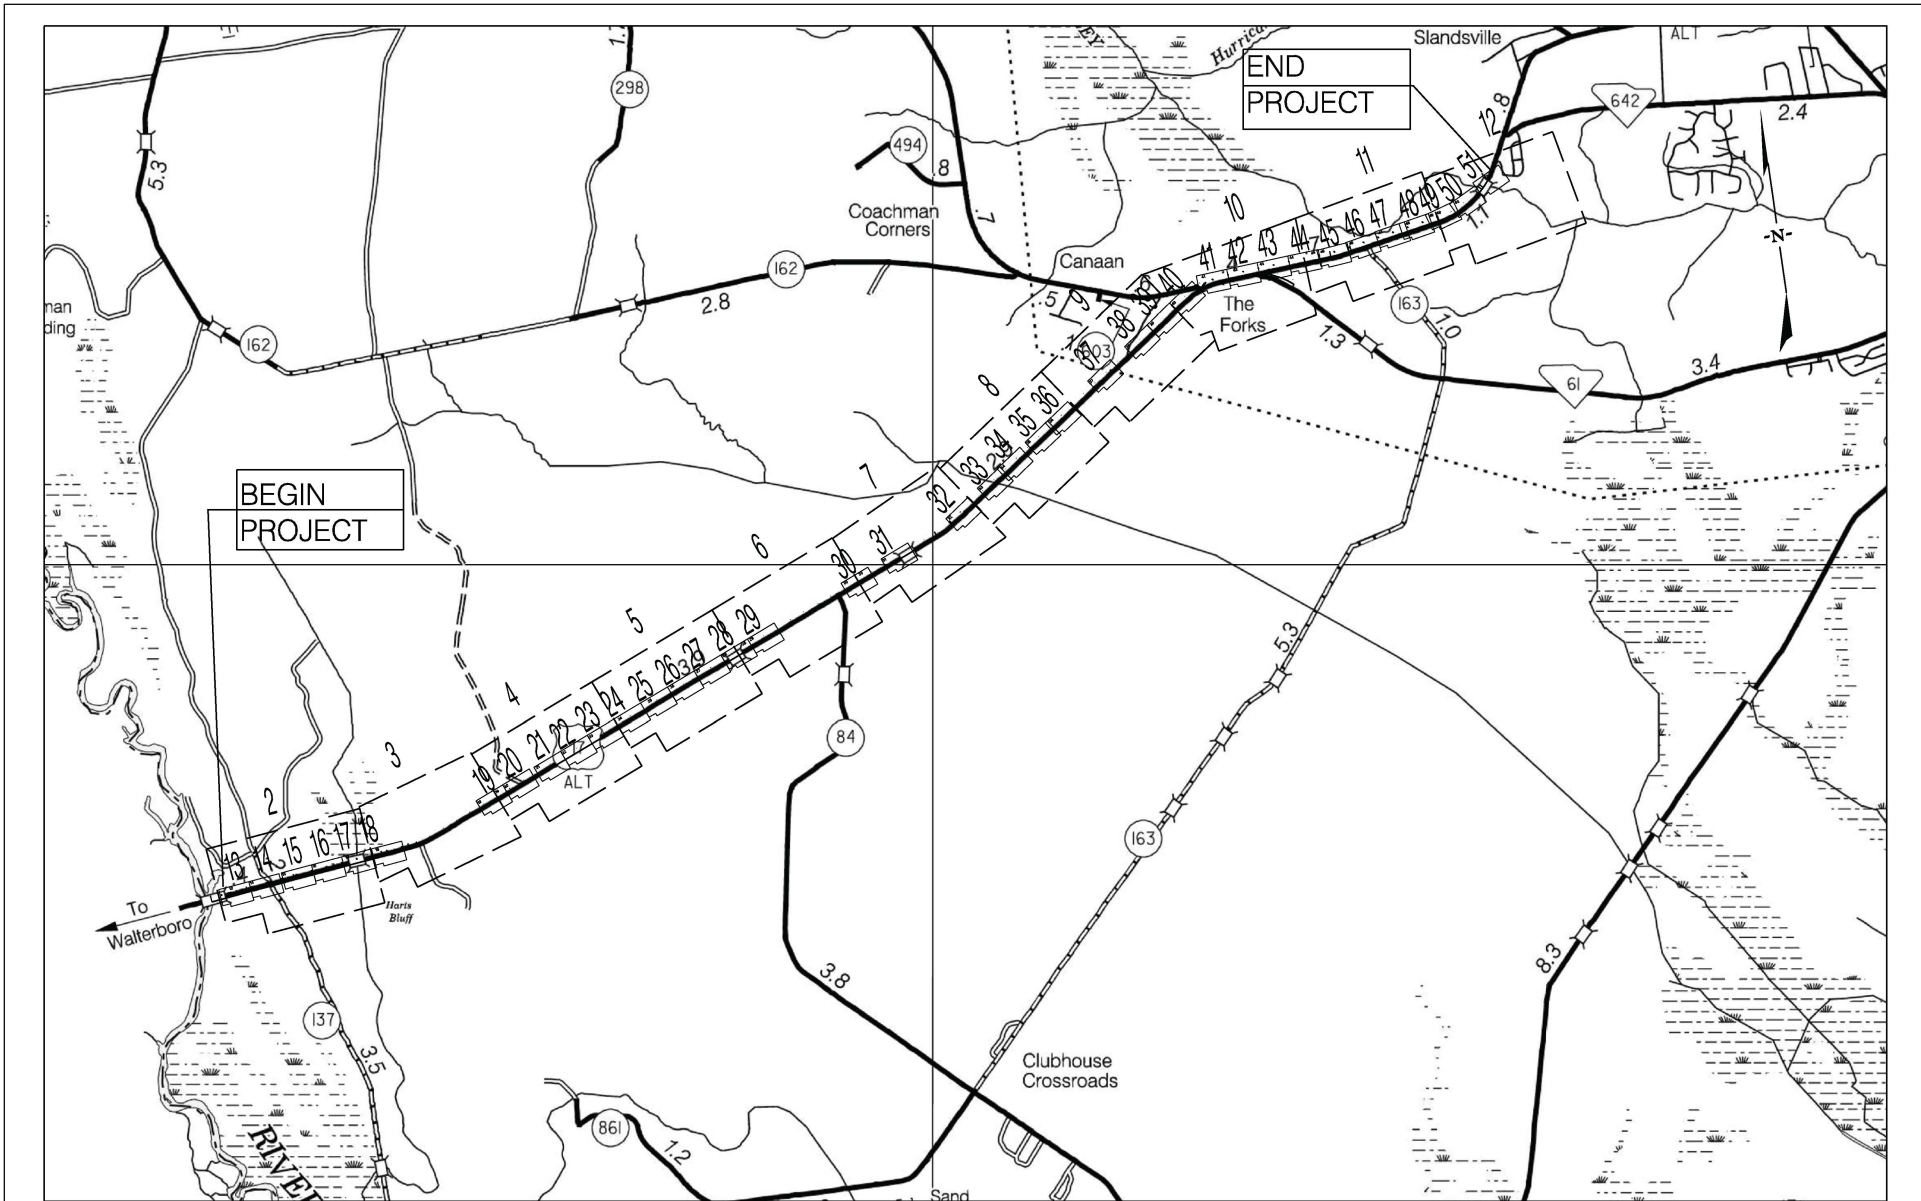

<p>APPROXIMATE LOCATION OF ROADWAY IS</p> <p>BEGIN          LATITUDE <u>32° 55' 37.67"N</u>          LONGITUDE <u>80° 23' 51.83"W</u></p> <p>END          LATITUDE <u>32° 58' 06.35"N</u>          LONGITUDE <u>80° 15' 11.78"W</u></p>	<p>APPLICANT</p>  <p>South Carolina Department of Transportation</p>	<p>Project Totals:</p> <table border="1"> <tr> <td>Wetland Fill:</td> <td>4.283 acres</td> </tr> <tr> <td>Wetland Clearing:</td> <td>2.323 acres</td> </tr> <tr> <td>NWW Pipe Impact:</td> <td>9 L.F.</td> </tr> <tr> <td>NWW Armor Impact:</td> <td>60 L.F.</td> </tr> </table>	Wetland Fill:	4.283 acres	Wetland Clearing:	2.323 acres	NWW Pipe Impact:	9 L.F.	NWW Armor Impact:	60 L.F.	<p>SHEET TITLE</p> <p><b>LOCATION MAP PLAN VIEW</b></p> <p>N.T.S.</p>	<p>PROJECT TITLE</p> <p><b>US 17A SHOULDER IMPROVEMENT - SAFETY PROJECT SCDOT #P037073 DORCHESTER COUNTY</b></p> <p>SHEET No. 1 OF 67</p>
Wetland Fill:	4.283 acres											
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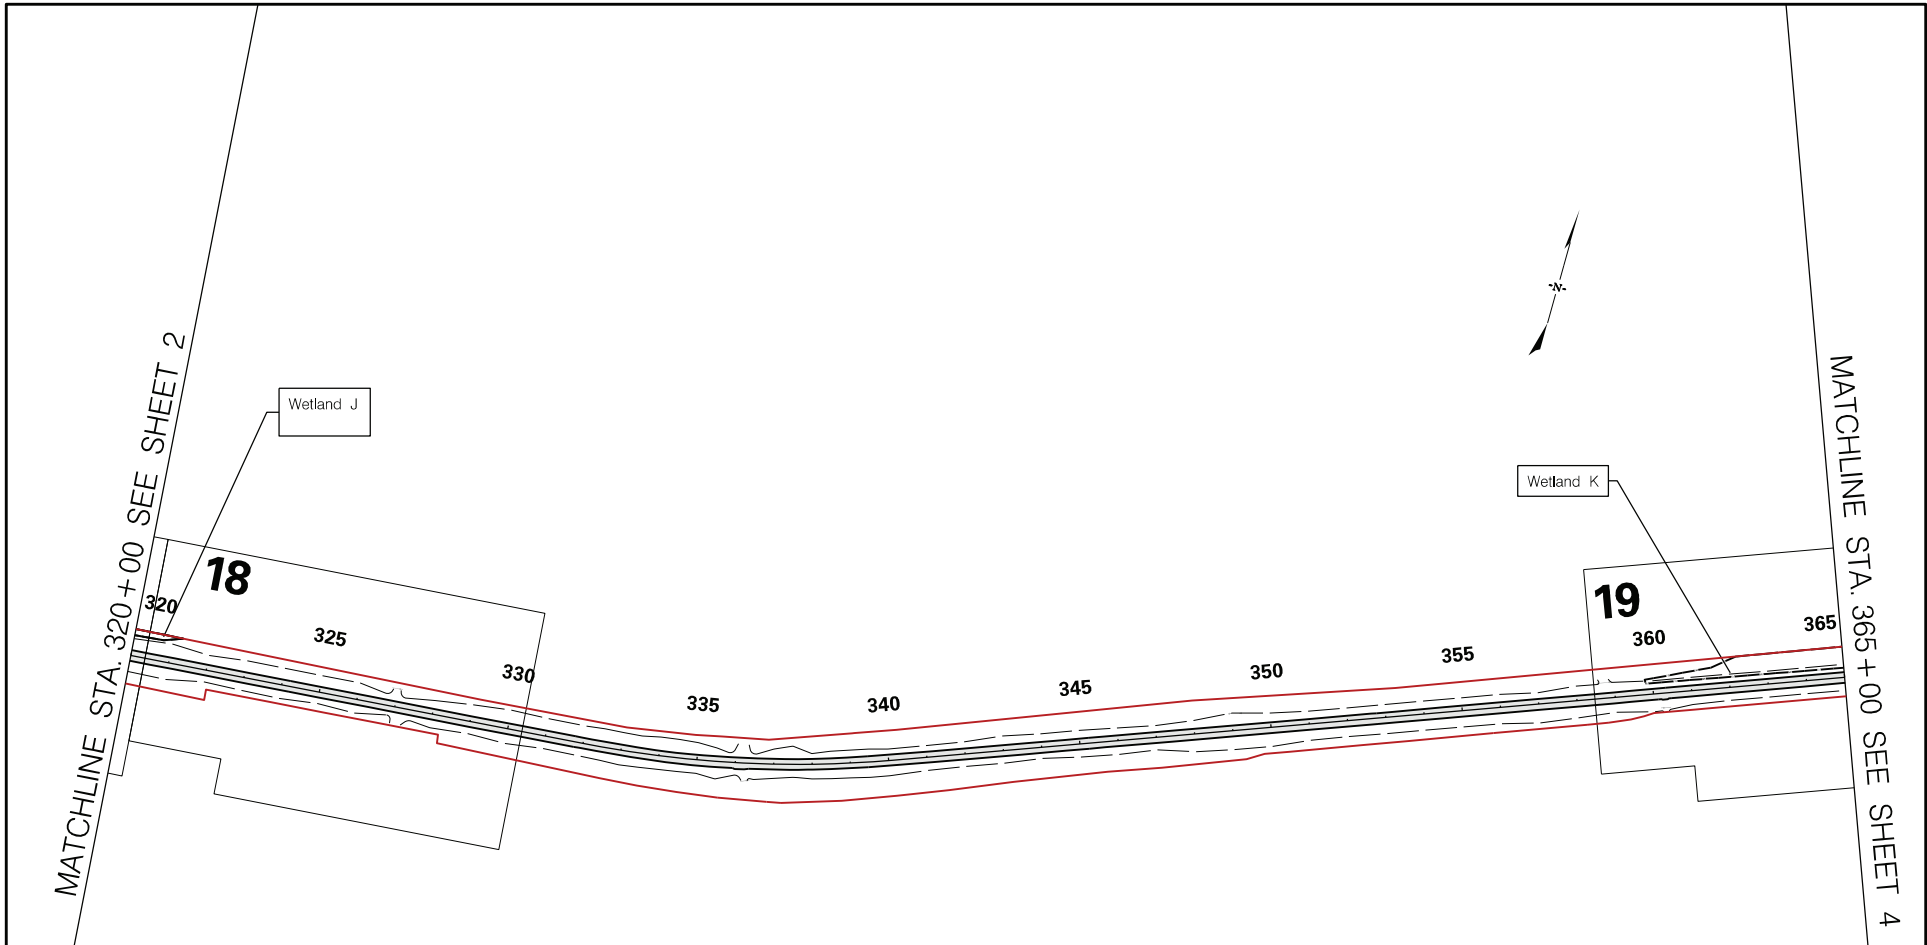


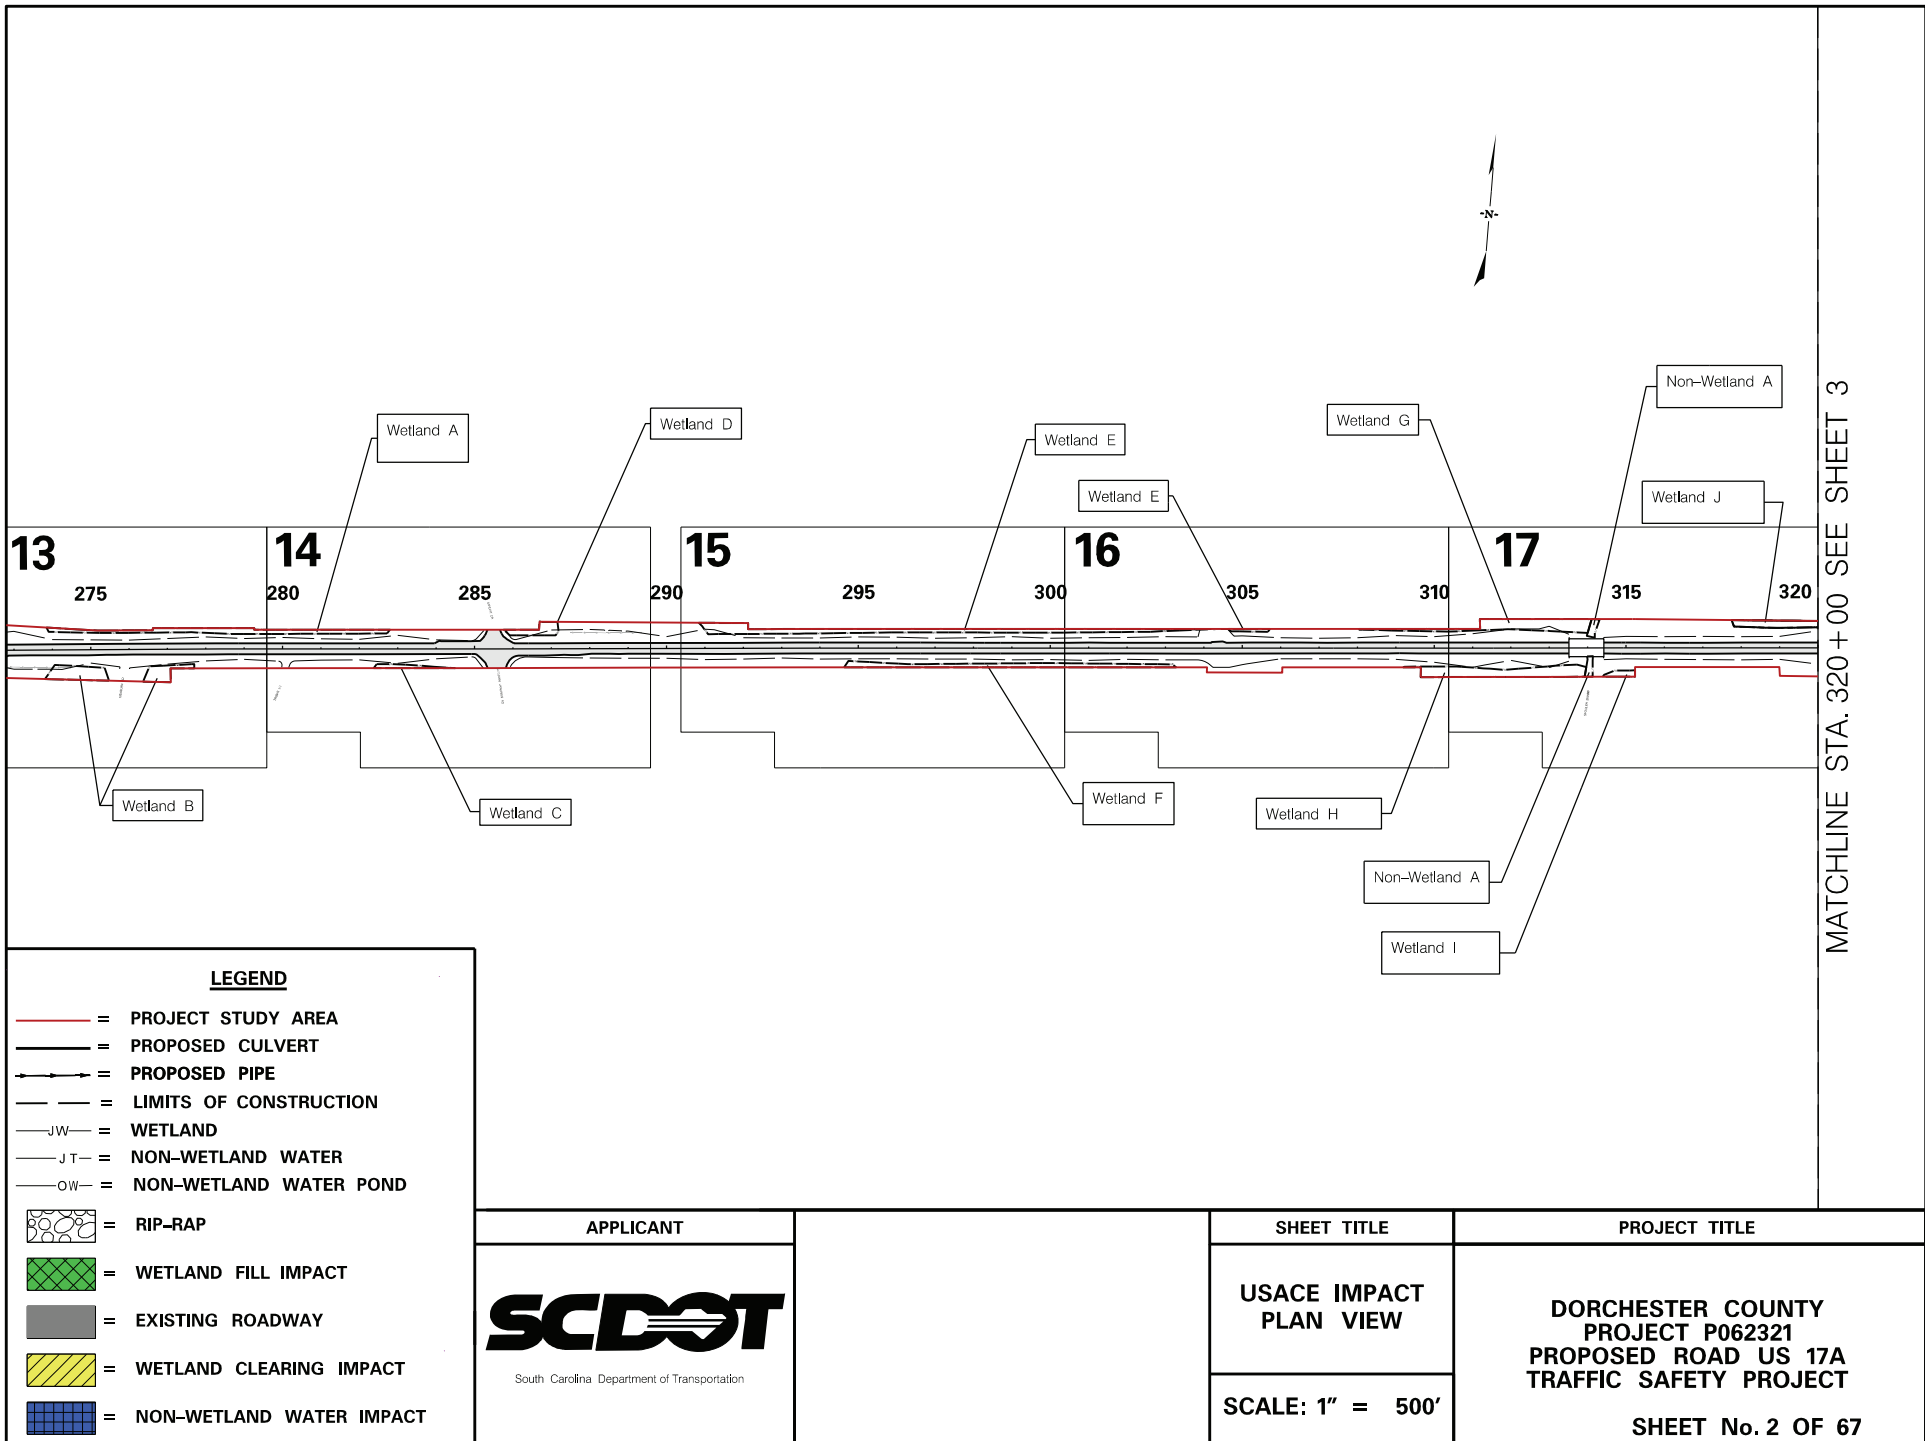MATCHLINE STA. 320+00 SEE SHEET 3













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
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- = LIMITS OF CONSTRUCTION
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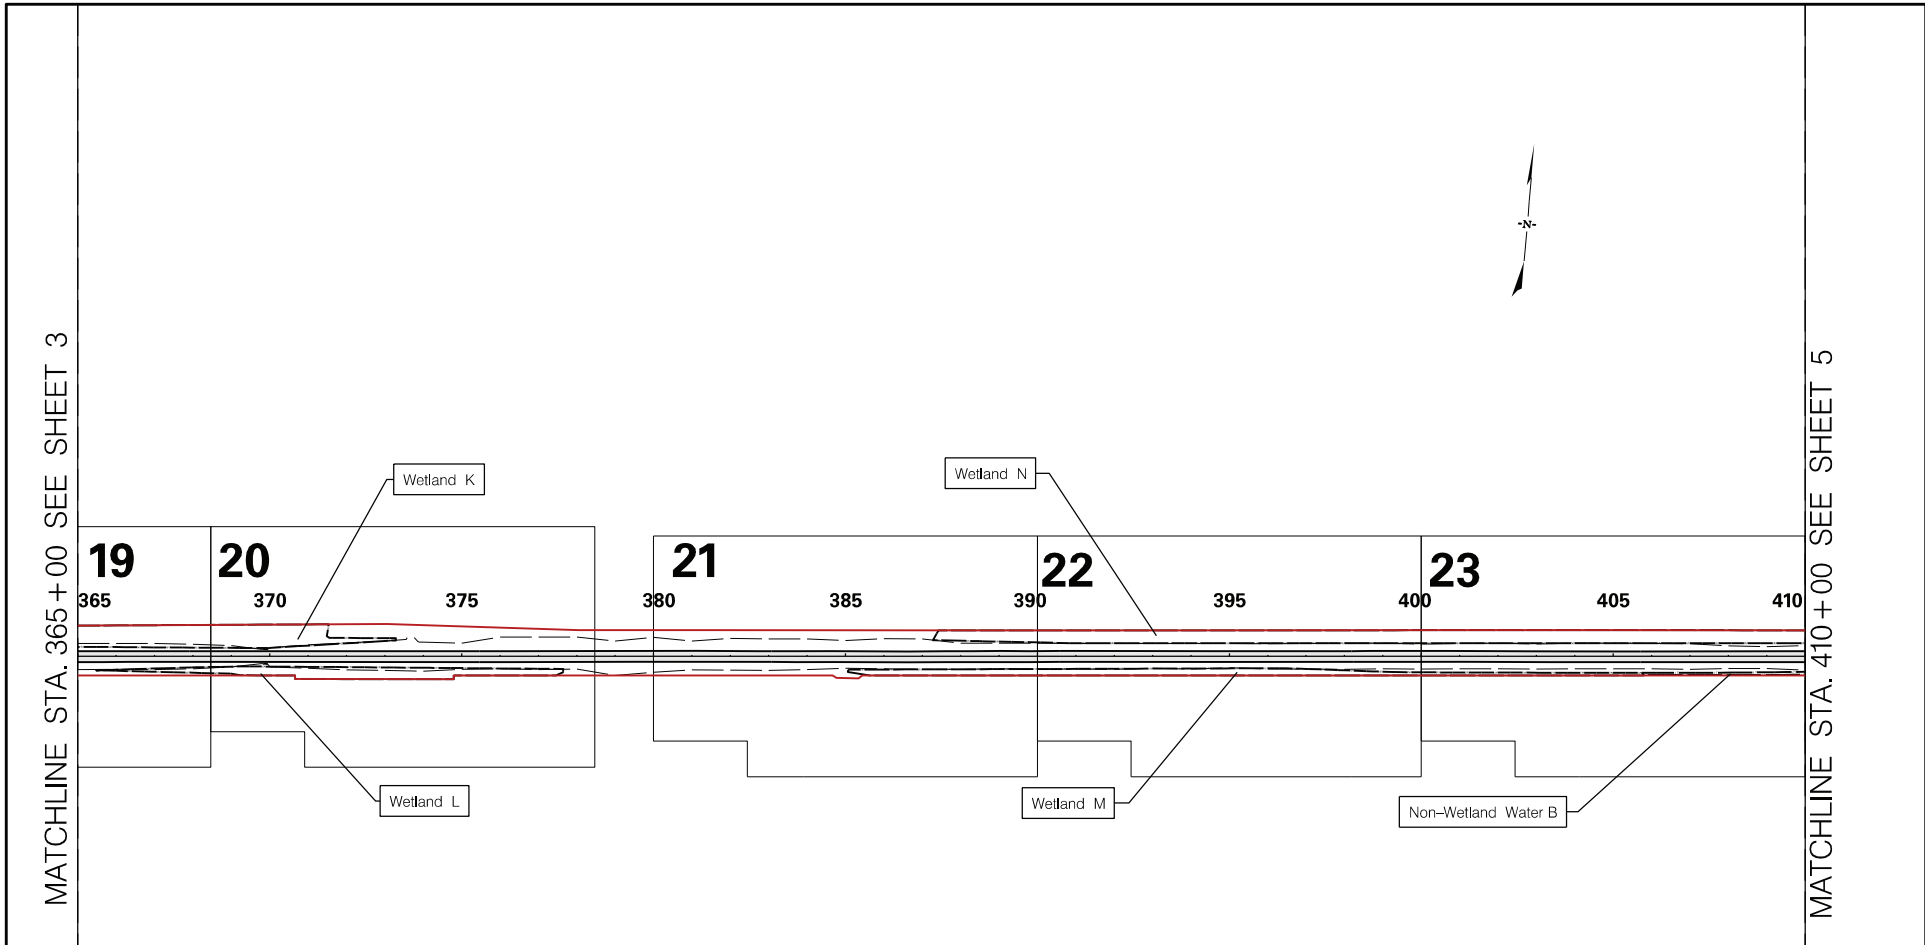
<p>APPLICANT</p> <p style="font-size: small;">South Carolina Department of Transportation</p>		<p>SHEET TITLE</p> <p><b>USACE IMPACT PLAN VIEW</b></p> <p>SCALE: 1" = 500'</p>	<p>PROJECT TITLE</p> <p><b>DORCHESTER COUNTY PROJECT P062321 PROPOSED ROAD US 17A TRAFFIC SAFETY PROJECT</b></p> <p>SHEET No. 2 OF 67</p>
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



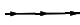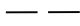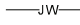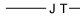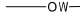


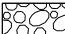

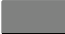


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
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-  = LIMITS OF CONSTRUCTION
-  = WETLAND
-  = NON-WETLAND WATER
-  = NON-WETLAND WATER POND
-  = RIP-RAP
-  = WETLAND FILL IMPACT
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<p>APPLICANT</p>  <p>South Carolina Department of Transportation</p>		<p>SHEET TITLE</p> <p><b>USACE IMPACT PLAN VIEW</b></p>	<p>PROJECT TITLE</p> <p><b>DORCHESTER COUNTY PROJECT P062321 PROPOSED ROAD US 17A TRAFFIC SAFETY PROJECT</b></p>
		<p>SCALE: 1" = 500'</p>	<p>SHEET No. 3 OF 67</p>



**LEGEND**


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












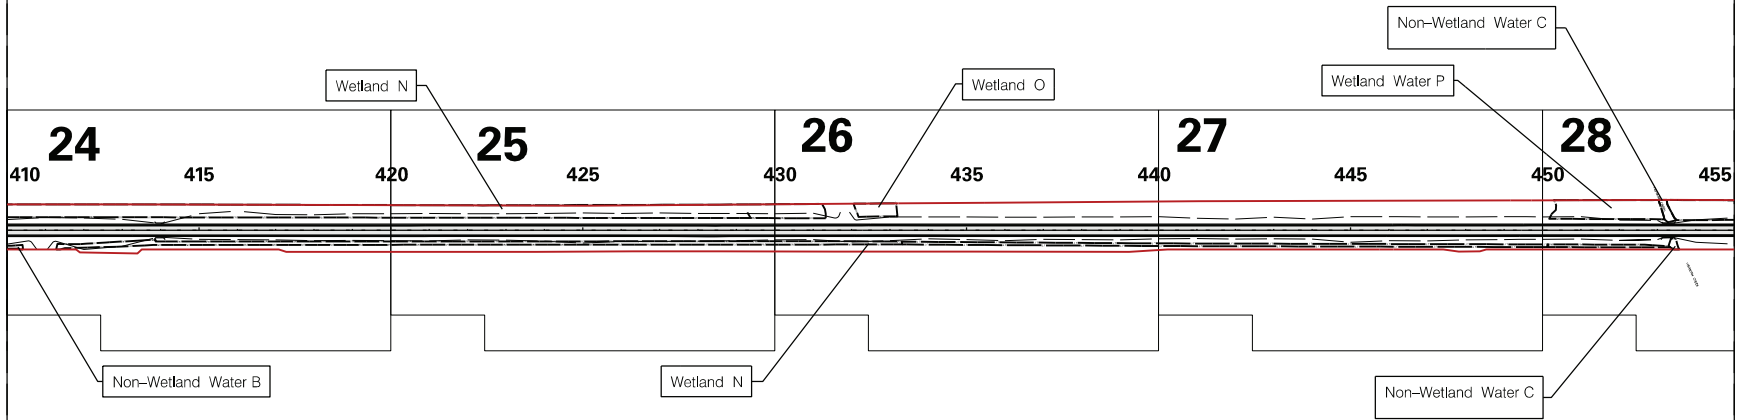

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MATCHLINE STA. 455 + 00 SEE SHEET 6

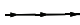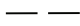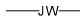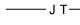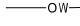


**LEGEND**

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











<p>APPLICANT</p>  <p>South Carolina Department of Transportation</p>		<p>SHEET TITLE</p> <p><b>USACE IMPACT PLAN VIEW</b></p> <p>SCALE: 1" = 500'</p>	<p>PROJECT TITLE</p> <p><b>DORCHESTER COUNTY PROJECT P062321 PROPOSED ROAD US 17A TRAFFIC SAFETY PROJECT</b></p> <p>SHEET No. 5 OF 67</p>
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
MATCHLINE STA. 455 + 00 SEE SHEET 5

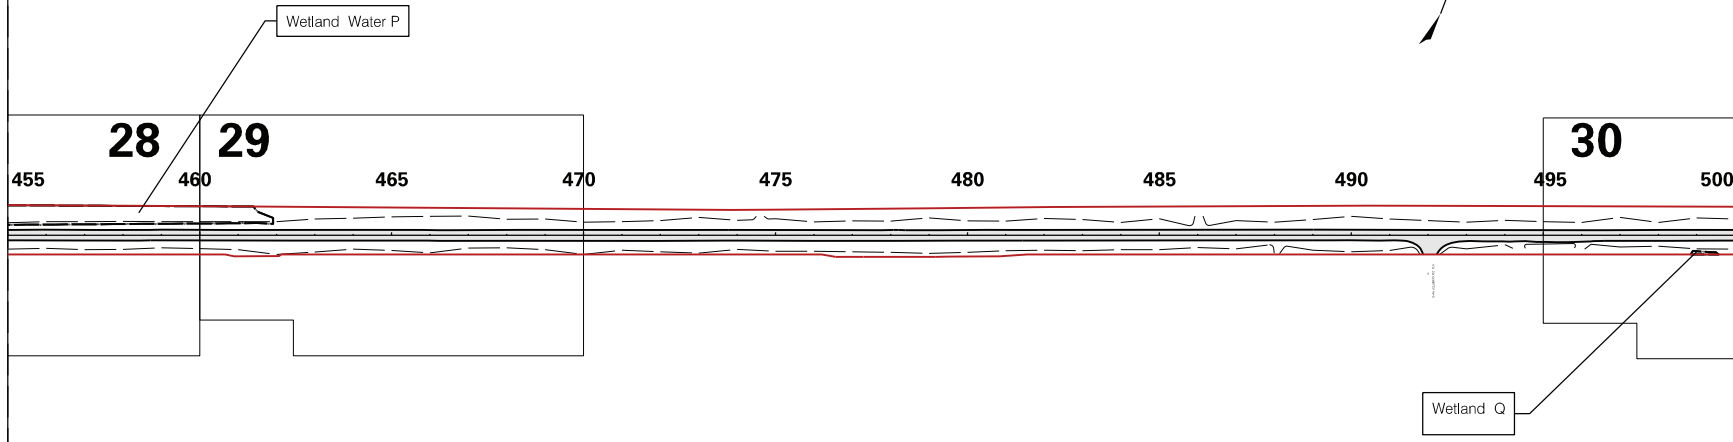
MATCHLINE STA. 500 + 00 SEE SHEET 7



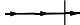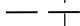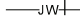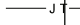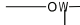



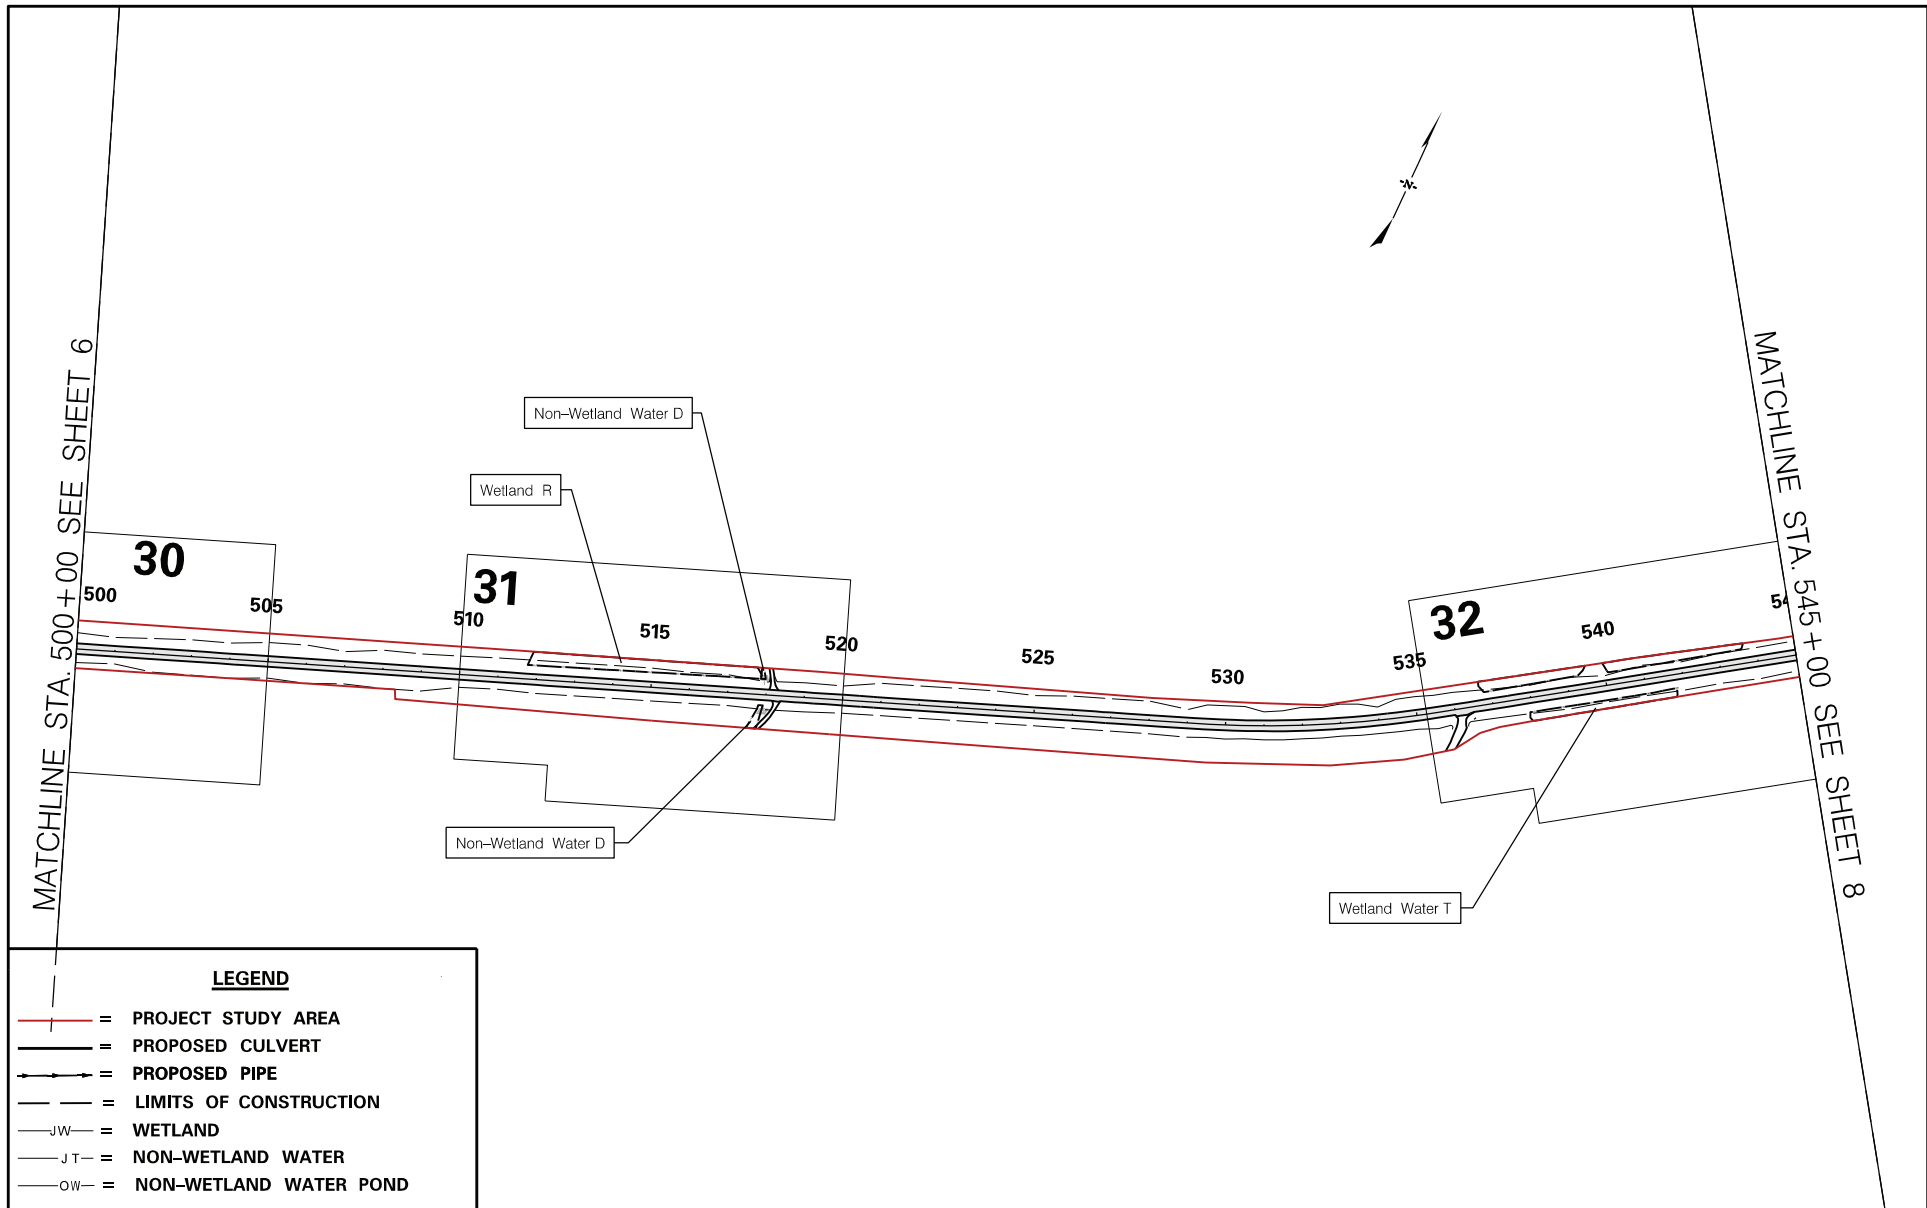


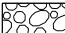




**LEGEND**


-  = PROJECT STUDY AREA
-  = PROPOSED CULVERT
-  = PROPOSED PIPE
-  = LIMITS OF CONSTRUCTION
-  = WETLAND
-  = NON-WETLAND WATER
-  = NON-WETLAND WATER POND
-  = RIP-RAP
-  = WETLAND FILL IMPACT
-  = EXISTING ROADWAY
-  = WETLAND CLEARING IMPACT
-  = NON-WETLAND WATER IMPACT

<p>APPLICANT</p>		<p>SHEET TITLE</p>	<p>PROJECT TITLE</p>
 <p>South Carolina Department of Transportation</p>		<p>USACE IMPACT PLAN VIEW</p> <p>SCALE: 1" = 500'</p>	<p>DORCHESTER COUNTY PROJECT P062321 PROPOSED ROAD US 17A TRAFFIC SAFETY PROJECT</p> <p>SHEET No. 6 OF 67</p>



**LEGEND**

-  = PROJECT STUDY AREA
-  = PROPOSED CULVERT
-  = PROPOSED PIPE
-  = LIMITS OF CONSTRUCTION
-  = WETLAND
-  = NON-WETLAND WATER
-  = NON-WETLAND WATER POND
-  = RIP-RAP
-  = WETLAND FILL IMPACT
-  = EXISTING ROADWAY
-  = WETLAND CLEARING IMPACT
-  = NON-WETLAND WATER IMPACT

<p>APPLICANT</p>  <p>South Carolina Department of Transportation</p>		<p>SHEET TITLE</p> <p><b>USACE IMPACT PLAN VIEW</b></p> <p>SCALE: 1" = 500'</p>	<p>PROJECT TITLE</p> <p><b>DORCHESTER COUNTY PROJECT P062321 PROPOSED ROAD US 17A TRAFFIC SAFETY PROJECT</b></p> <p>SHEET No. 7 OF 67</p>
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MATCHLINE STA. 545 + 00 SEE SHEET 7

MATCHLINE STA. 590 + 00 SEE SHEET 9

Non-Wetland Water E

**33**  
550

555

**34**  
560

565

570

**35**  
575

580

**36**  
585

590

Non-Wetland Water E













Non-Wetland Water F

Wetland U

Wetland V

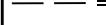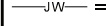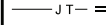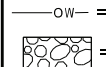

**LEGEND**

-  PROJECT STUDY AREA
-  PROPOSED CULVERT
-  PROPOSED PIPE
-  LIMITS OF CONSTRUCTION
-  WETLAND
-  NON-WETLAND WATER
-  NON-WETLAND WATER POND
-  RIP-RAP
-  WETLAND FILL IMPACT
-  EXISTING ROADWAY
-  WETLAND CLEARING IMPACT
-  NON-WETLAND WATER IMPACT

APPLICANT



South Carolina Department of Transportation

SHEET TITLE

USACE IMPACT  
PLAN VIEW

SCALE: 1" = 500'


PROJECT TITLE

DORCHESTER COUNTY  
PROJECT P062321  
PROPOSED ROAD US 17A  
TRAFFIC SAFETY PROJECT







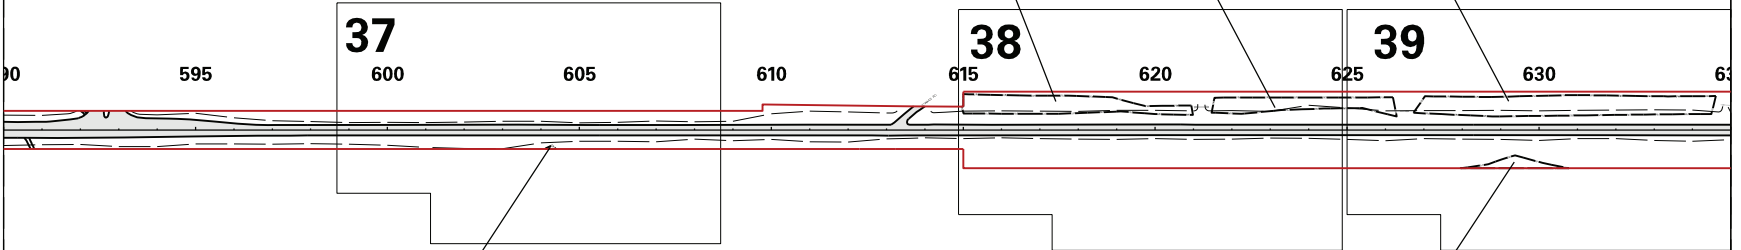





SHEET No. 8 OF 67

MATCHLINE STA. 590 + 00 SEE SHEET 8

MATCHLINE STA. 635 + 00 SEE SHEET 10

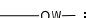

**LEGEND**

-  PROJECT STUDY AREA
-  PROPOSED CULVERT
-  PROPOSED PIPE
-  LIMITS OF CONSTRUCTION
-  WETLAND
-  NON-WETLAND WATER
-  NON-WETLAND WATER POND
-  RIP-RAP
-  WETLAND FILL IMPACT
-  EXISTING ROADWAY
-  WETLAND CLEARING IMPACT
-  NON-WETLAND WATER IMPACT

APPLICANT



South Carolina Department of Transportation

SHEET TITLE

**USACE IMPACT  
PLAN VIEW**


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SCALE: 1" = 500'








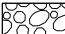

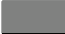


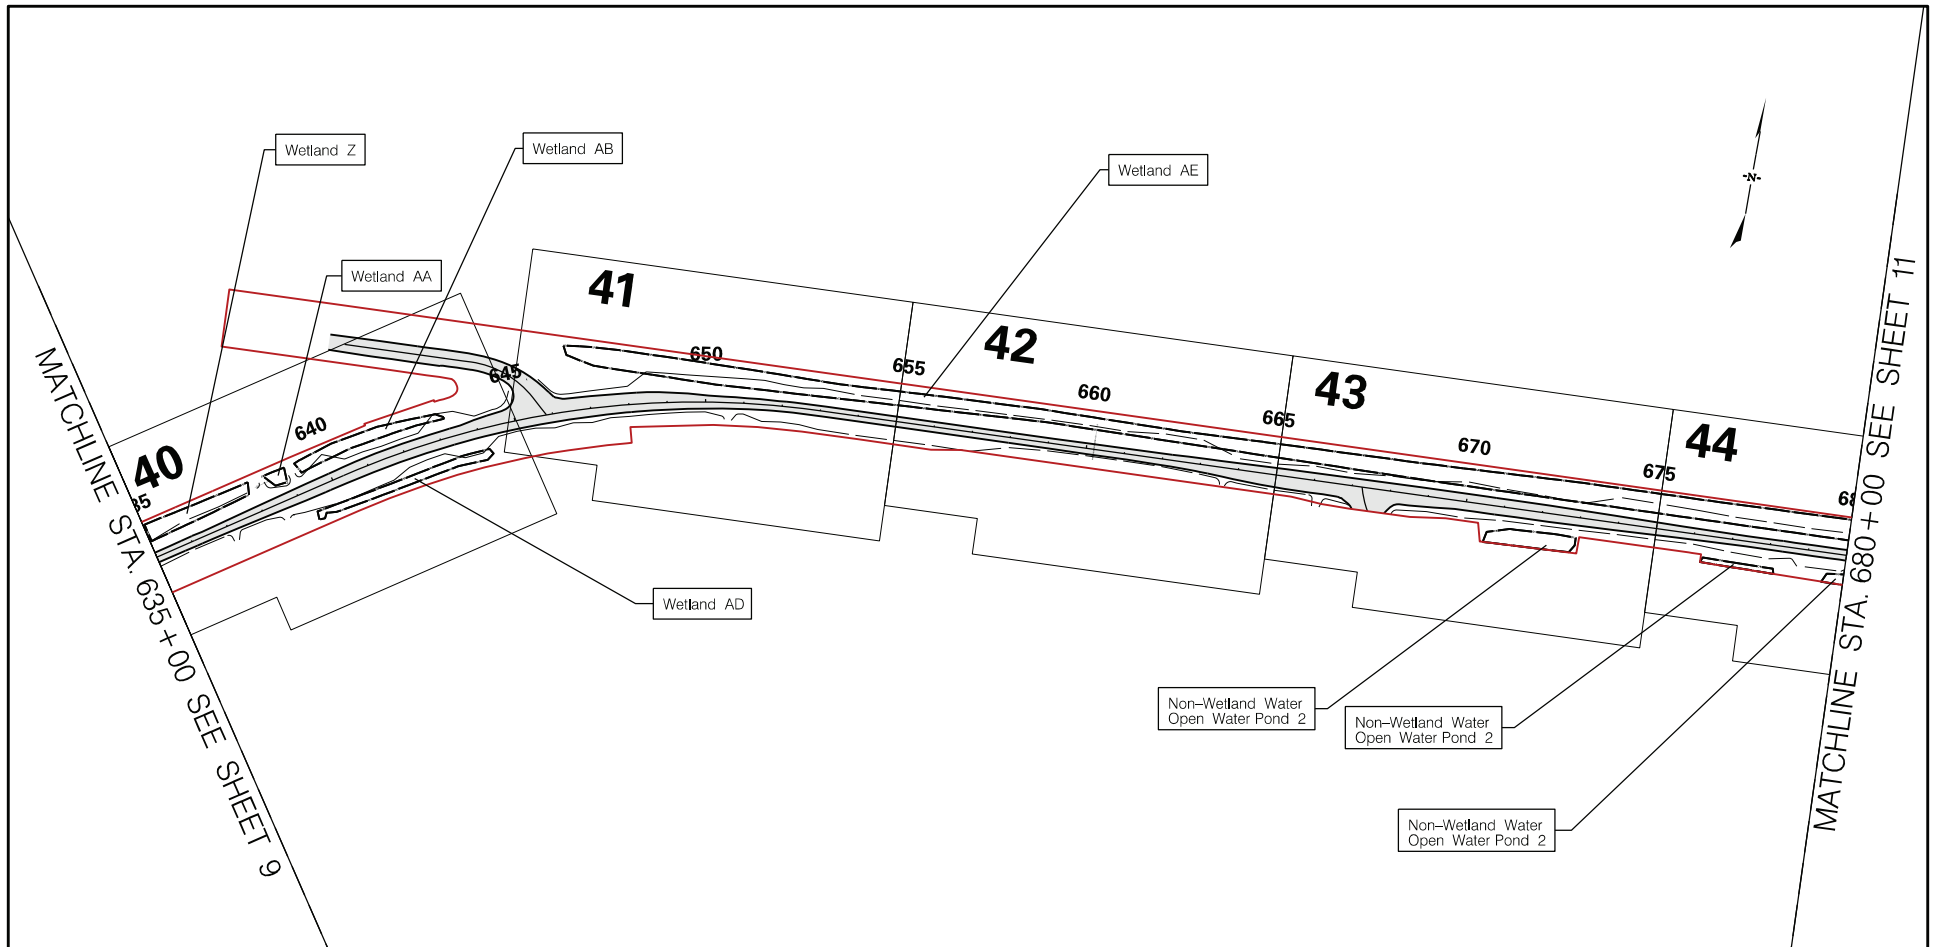PROJECT TITLE


**DORCHESTER COUNTY  
PROJECT P062321  
PROPOSED ROAD US 17A  
TRAFFIC SAFETY PROJECT**


SHEET No. 9 OF 67



**LEGEND**

-  = PROJECT STUDY AREA
-  = PROPOSED CULVERT
-  = PROPOSED PIPE
-  = LIMITS OF CONSTRUCTION
-  = WETLAND
-  = NON-WETLAND WATER
-  = NON-WETLAND WATER POND
-  = RIP-RAP
-  = WETLAND FILL IMPACT
-  = EXISTING ROADWAY
-  = WETLAND CLEARING IMPACT
-  = NON-WETLAND WATER IMPACT

<p>APPLICANT</p>  <p>South Carolina Department of Transportation</p>		<p>SHEET TITLE</p> <p><b>USACE IMPACT PLAN VIEW</b></p> <p>SCALE: 1" = 500'</p>	<p>PROJECT TITLE</p> <p><b>DORCHESTER COUNTY PROJECT P062321 PROPOSED ROAD US 17A TRAFFIC SAFETY PROJECT</b></p> <p>SHEET No. 10 OF 67</p>
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**LEGEND**

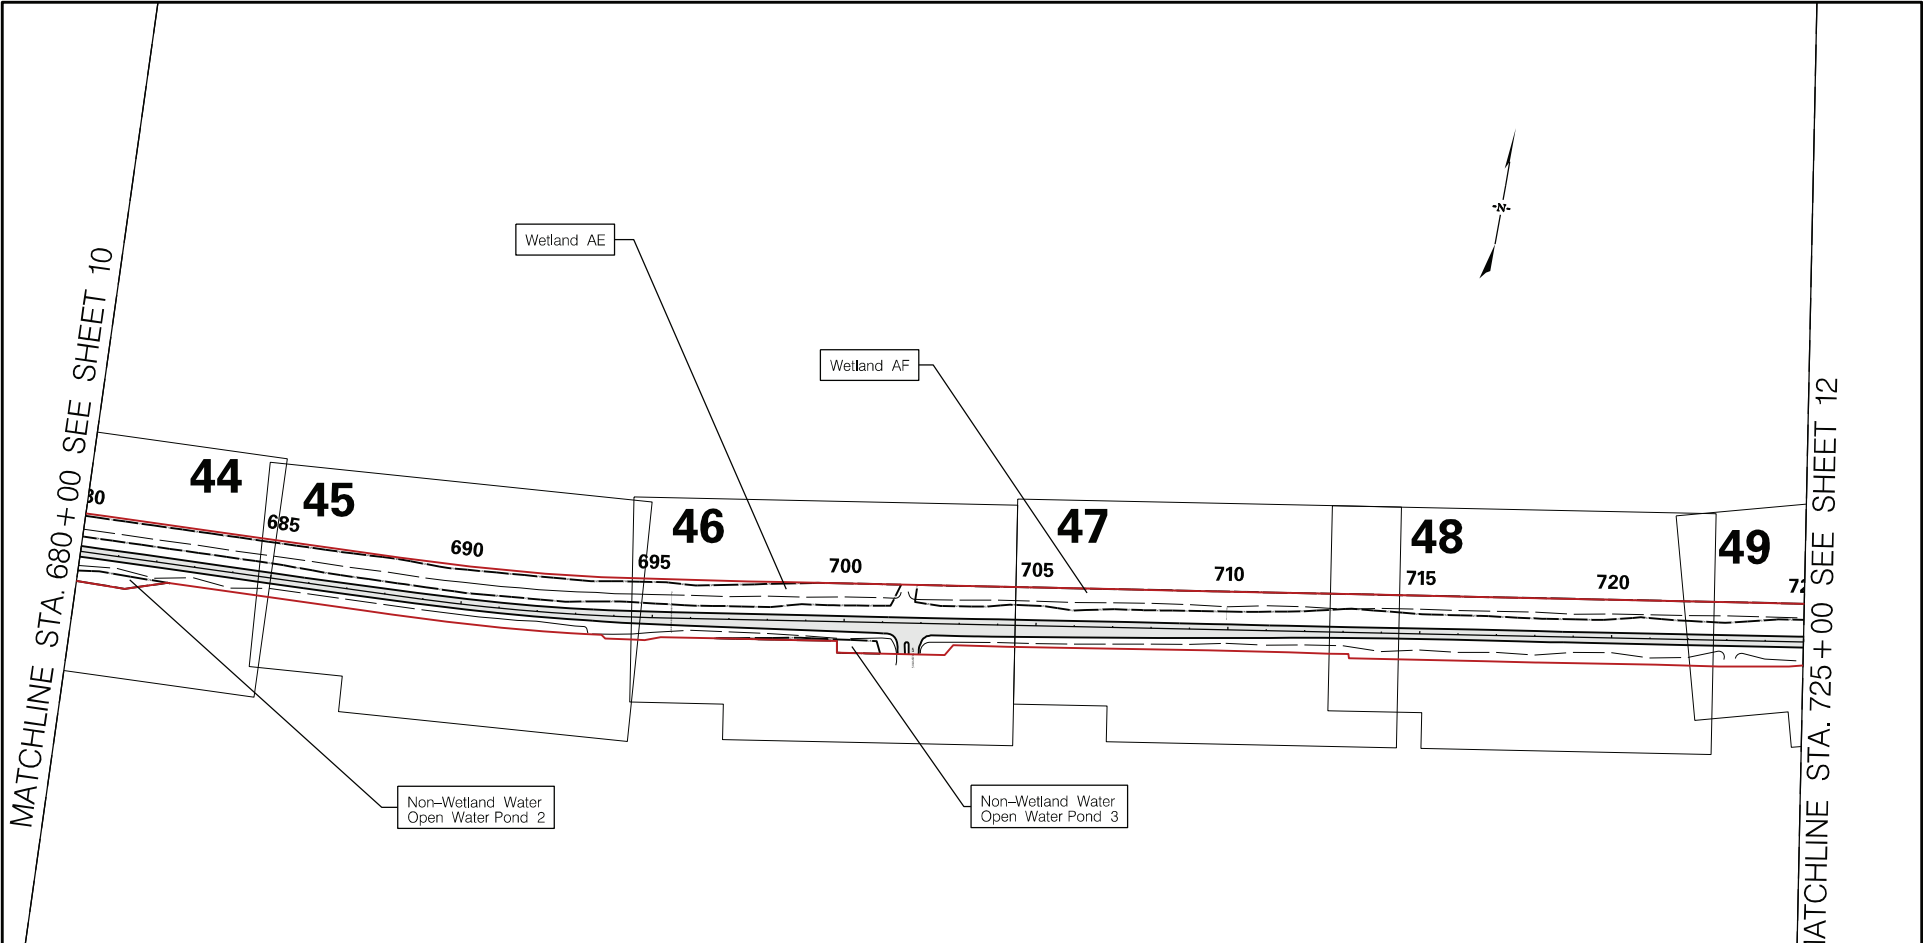- = PROJECT STUDY AREA
- = PROPOSED CULVERT
- = PROPOSED PIPE
- = LIMITS OF CONSTRUCTION
- = WETLAND
- = NON-WETLAND WATER
- = NON-WETLAND WATER POND
- = RIP-RAP
- = WETLAND FILL IMPACT
- = EXISTING ROADWAY
- = WETLAND CLEARING IMPACT
- = NON-WETLAND WATER IMPACT

APPLICANT



South Carolina Department of Transportation

APPLICANT

SHEET TITLE


**USACE IMPACT  
PLAN VIEW**

SCALE: 1" = 500'










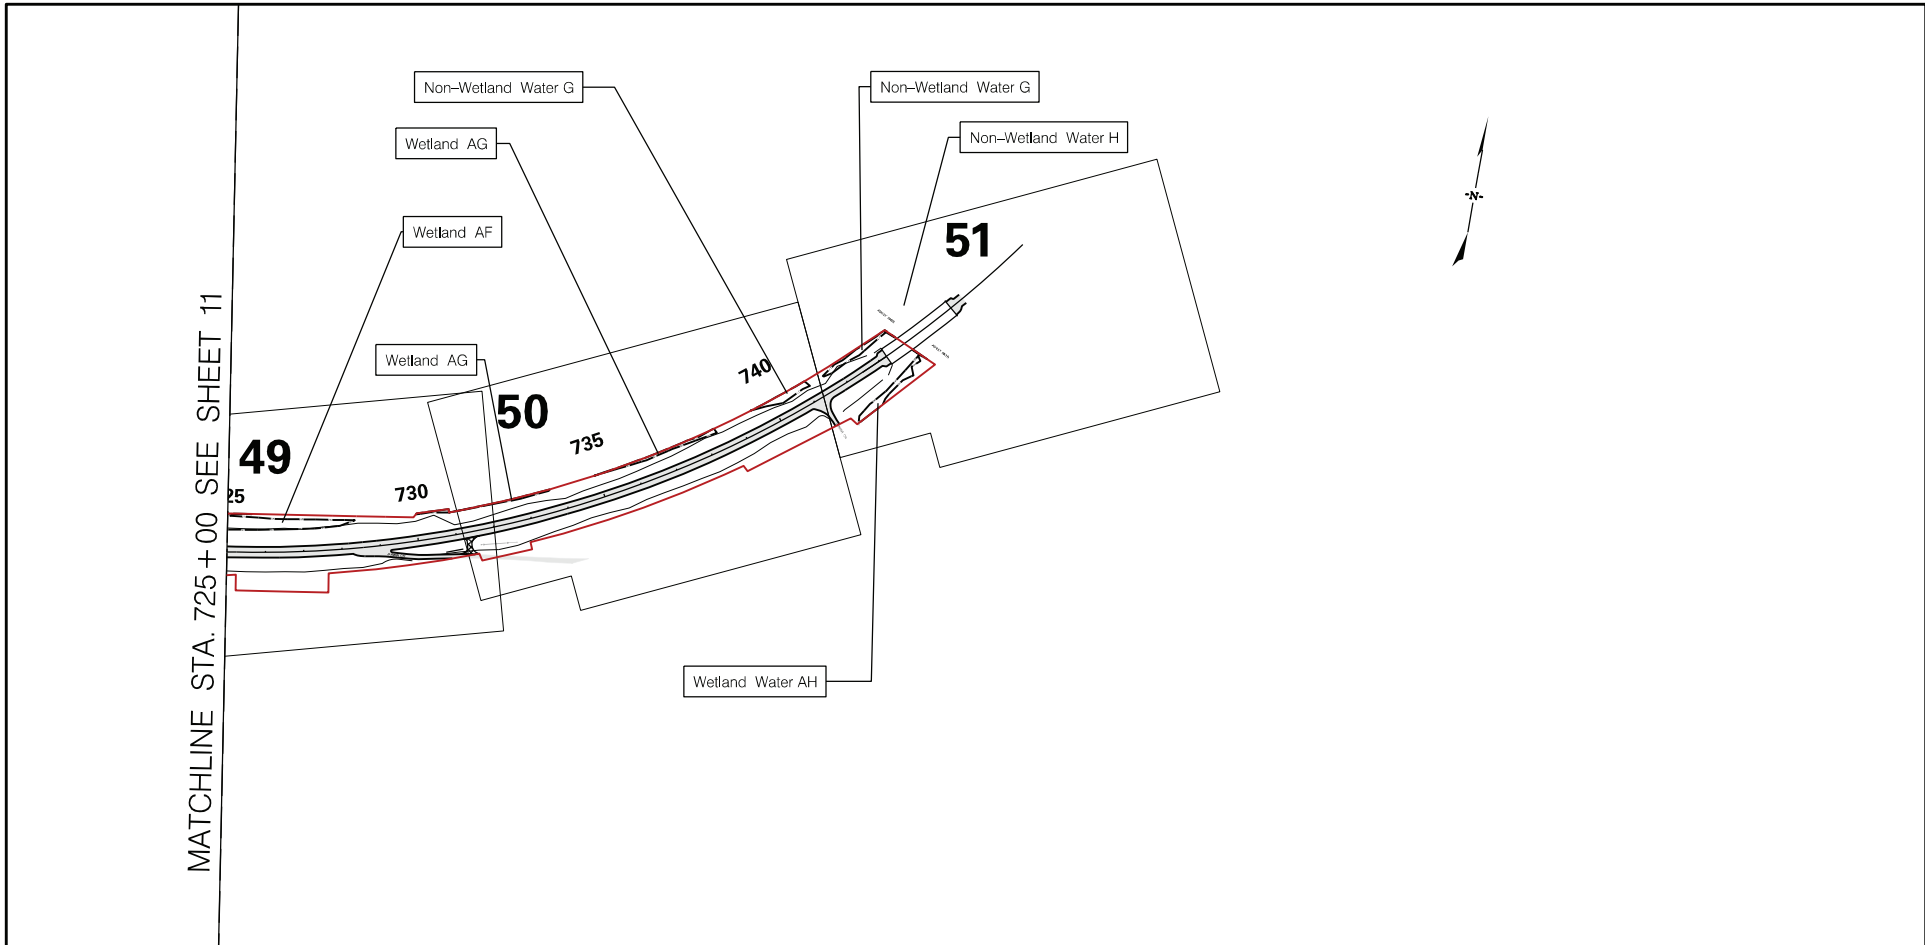


PROJECT TITLE


**DORCHESTER COUNTY  
PROJECT P062321  
PROPOSED ROAD US 17A  
TRAFFIC SAFETY PROJECT**

SHEET No. 11 OF 67

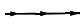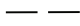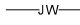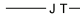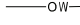


**LEGEND**

-  = PROJECT STUDY AREA
-  = PROPOSED CULVERT
-  = PROPOSED PIPE
-  = LIMITS OF CONSTRUCTION
-  = WETLAND
-  = NON-WETLAND WATER
-  = NON-WETLAND WATER POND
-  = RIP-RAP
-  = WETLAND FILL IMPACT
-  = EXISTING ROADWAY
-  = WETLAND CLEARING IMPACT
-  = NON-WETLAND WATER IMPACT


<p>APPLICANT</p>  <p>South Carolina Department of Transportation</p>		<p>SHEET TITLE</p> <p><b>USACE IMPACT PLAN VIEW</b></p> <p>SCALE: 1" = 500'</p>	<p>PROJECT TITLE</p> <p><b>DORCHESTER COUNTY PROJECT P062321 PROPOSED ROAD US 17A TRAFFIC SAFETY PROJECT</b></p> <p>SHEET No. 12 OF 67</p>
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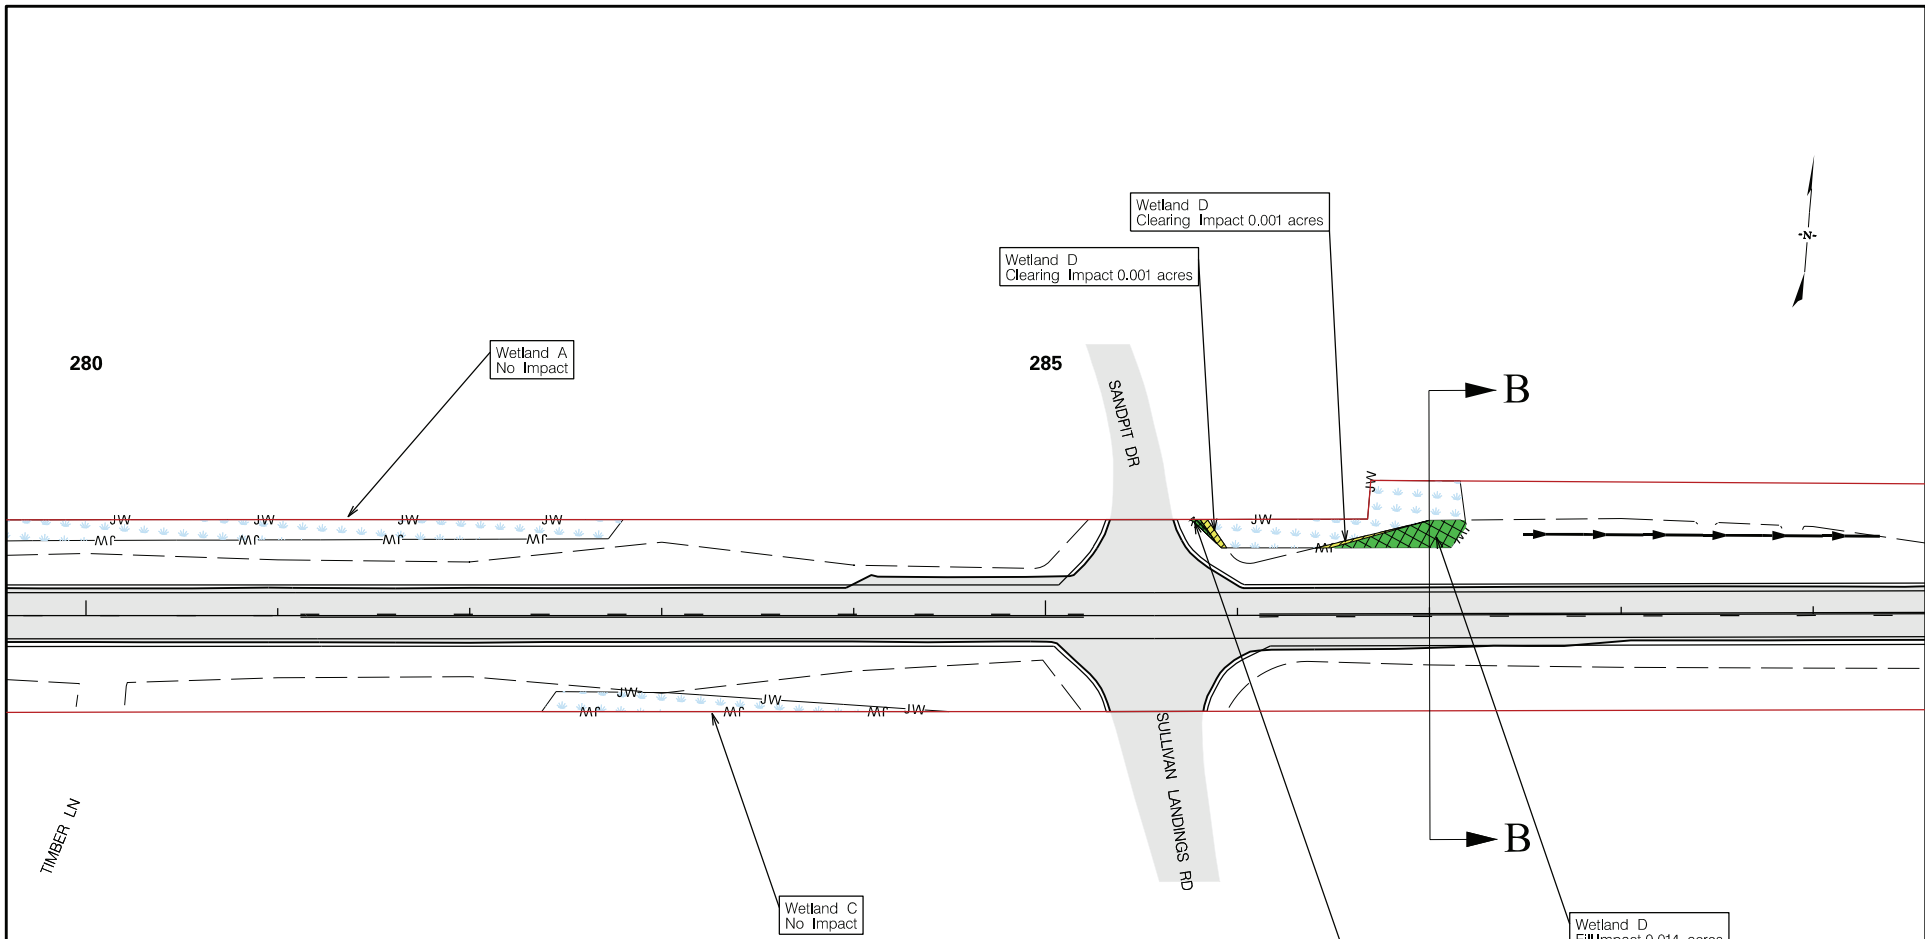


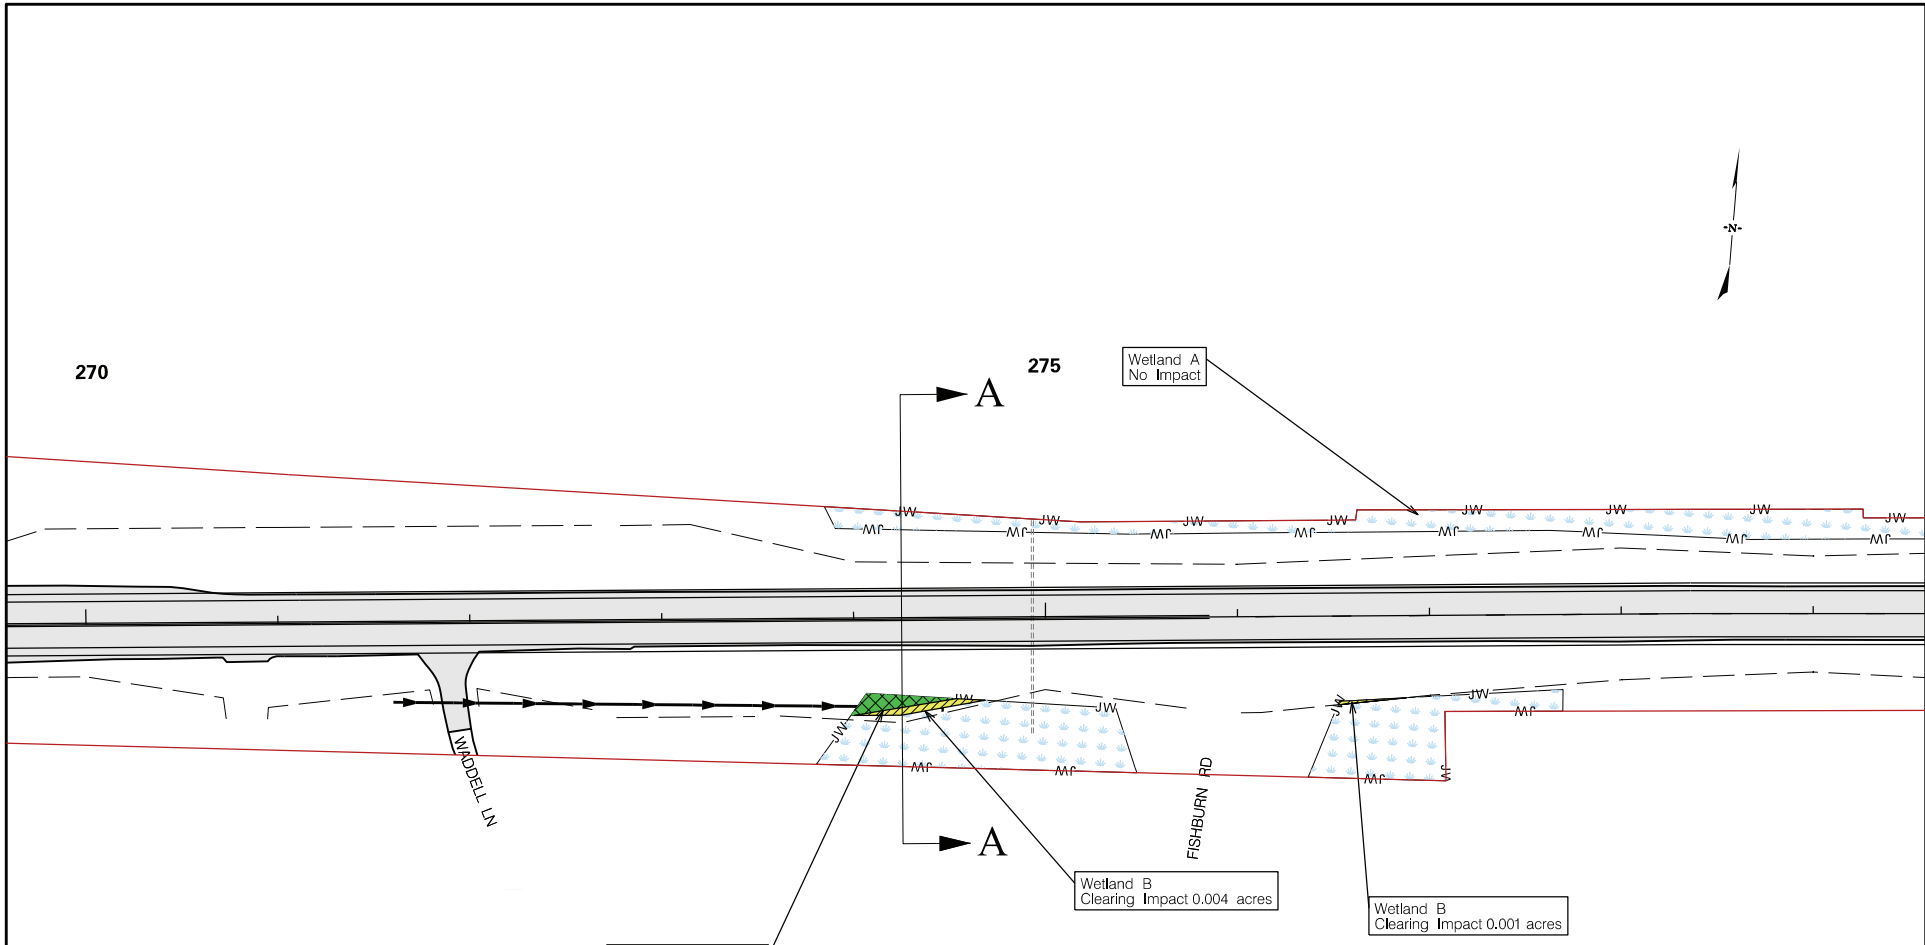

**LEGEND**

- = PROJECT STUDY AREA
- = PROPOSED CULVERT
- = PROPOSED PIPE
- = LIMITS OF CONSTRUCTION
- JW — = WETLAND
- JT — = NON-WETLAND WATER
- OW — = NON-WETLAND WATER POND
- [Pattern] = RIP-RAP
- [Green Grid] = WETLAND FILL IMPACT
- [Grey Box] = EXISTING ROADWAY
- [Yellow Grid] = WETLAND CLEARING IMPACT
- [Blue Grid] = NON-WETLAND WATER IMPACT

APPLICANT	SHEET TITLE	PROJECT TITLE
 South Carolina Department of Transportation	<b>USACE IMPACT PLAN VIEW</b>  <b>SCALE: 1" = 100'</b>	<b>DORCHESTER COUNTY PROJECT P062321 PROPOSED ROAD US 17A TRAFFIC SAFETY PROJECT</b>
<b>Sheet Totals:</b> Wetland Fill: 0.007 acres Wetland Clearing: 0.005 acres		<b>SHEET No. 13 OF 67</b>




LEGEND	
	= PROJECT STUDY AREA
	= PROPOSED CULVERT
	= PROPOSED PIPE
	= LIMITS OF CONSTRUCTION
	= WETLAND
	= NON-WETLAND WATER
	= NON-WETLAND WATER POND
	= RIP-RAP
	= WETLAND FILL IMPACT
	= EXISTING ROADWAY
	= WETLAND CLEARING IMPACT
	= NON-WETLAND WATER IMPACT

APPLICANT
 South Carolina Department of Transportation

<b>Sheet Totals:</b> Wetland Fill: 0.015 acres Wetland Clearing: 0.002 acres
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SHEET TITLE
USACE IMPACT PLAN VIEW
SCALE: 1" = 100'



PROJECT TITLE
DORCHESTER COUNTY PROJECT P062321 PROPOSED ROAD US 17A TRAFFIC SAFETY PROJECT
SHEET No. 14 OF 67



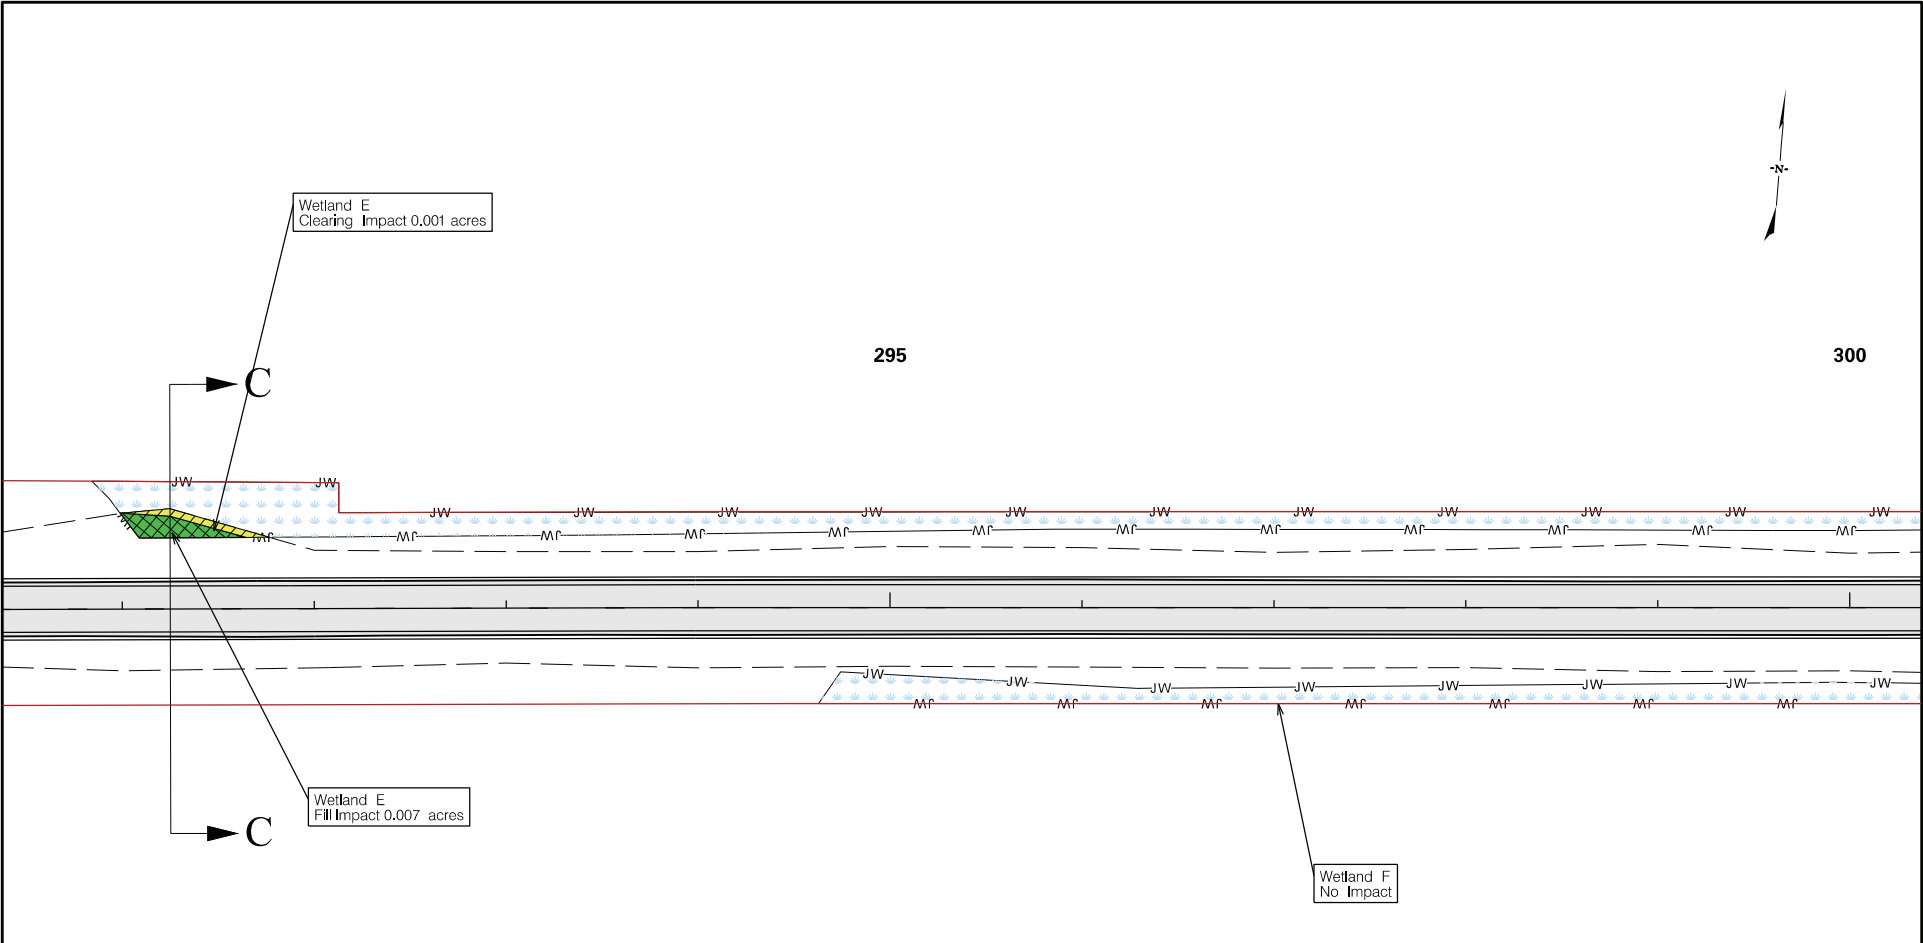




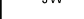


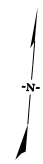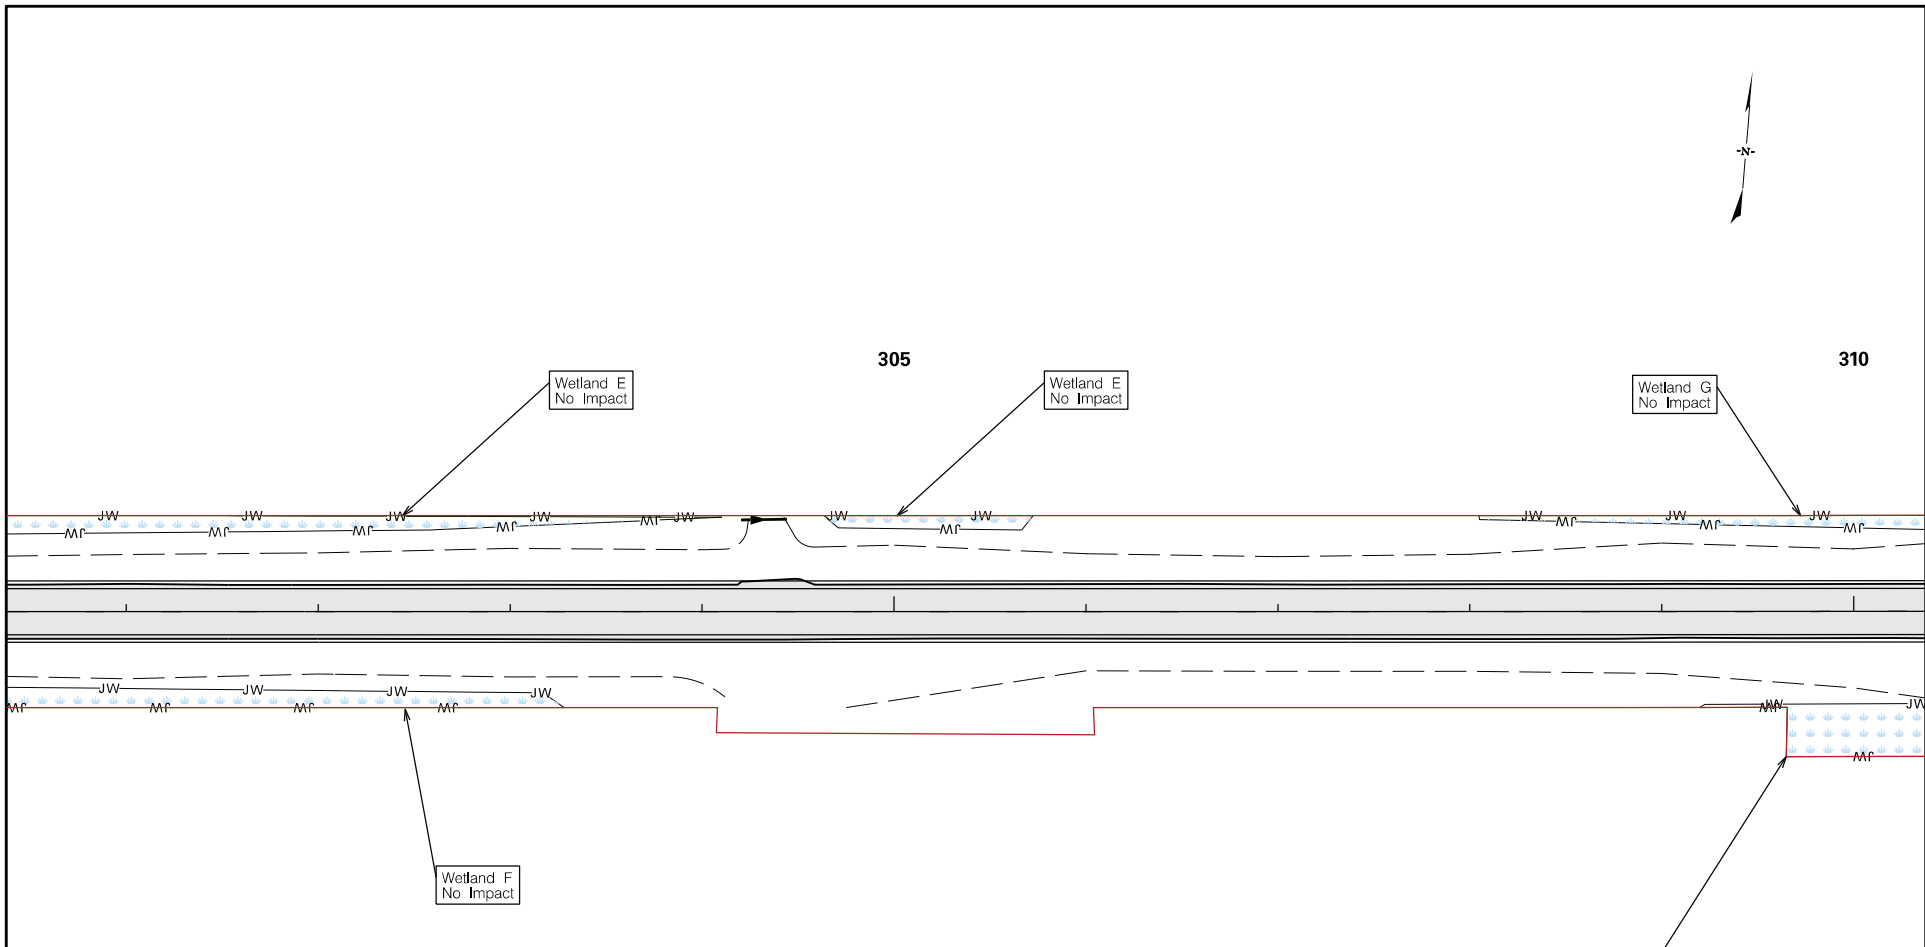



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
- = PROJECT STUDY AREA
- = PROPOSED CULVERT
- = PROPOSED PIPE
- = LIMITS OF CONSTRUCTION
- JW — = WETLAND
- JT — = NON-WETLAND WATER
- OW — = NON-WETLAND WATER POND
- = RIP-RAP
- = WETLAND FILL IMPACT
- = EXISTING ROADWAY
- = WETLAND CLEARING IMPACT
- = NON-WETLAND WATER IMPACT


APPLICANT	SHEET TITLE	PROJECT TITLE
 South Carolina Department of Transportation	<b>USACE IMPACT PLAN VIEW</b>  <b>SCALE: 1" = 100'</b>	<b>DORCHESTER COUNTY PROJECT P062321 PROPOSED ROAD US 17A TRAFFIC SAFETY PROJECT</b>
<b>Sheet Totals:</b> Wetland Fill: 0.007 acres Wetland Clearing: 0.001 acres		<b>SHEET No. 15 OF 67</b>



**LEGEND**


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-  = PROPOSED CULVERT
-  = PROPOSED PIPE
-  = LIMITS OF CONSTRUCTION
-  = WETLAND
-  = NON-WETLAND WATER
-  = NON-WETLAND WATER POND
-  = RIP-RAP
-  = WETLAND FILL IMPACT
-  = EXISTING ROADWAY
-  = WETLAND CLEARING IMPACT
-  = NON-WETLAND WATER IMPACT


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		<p>SCALE: 1" = 100'</p>	<p>SHEET No. 16 OF 67</p>

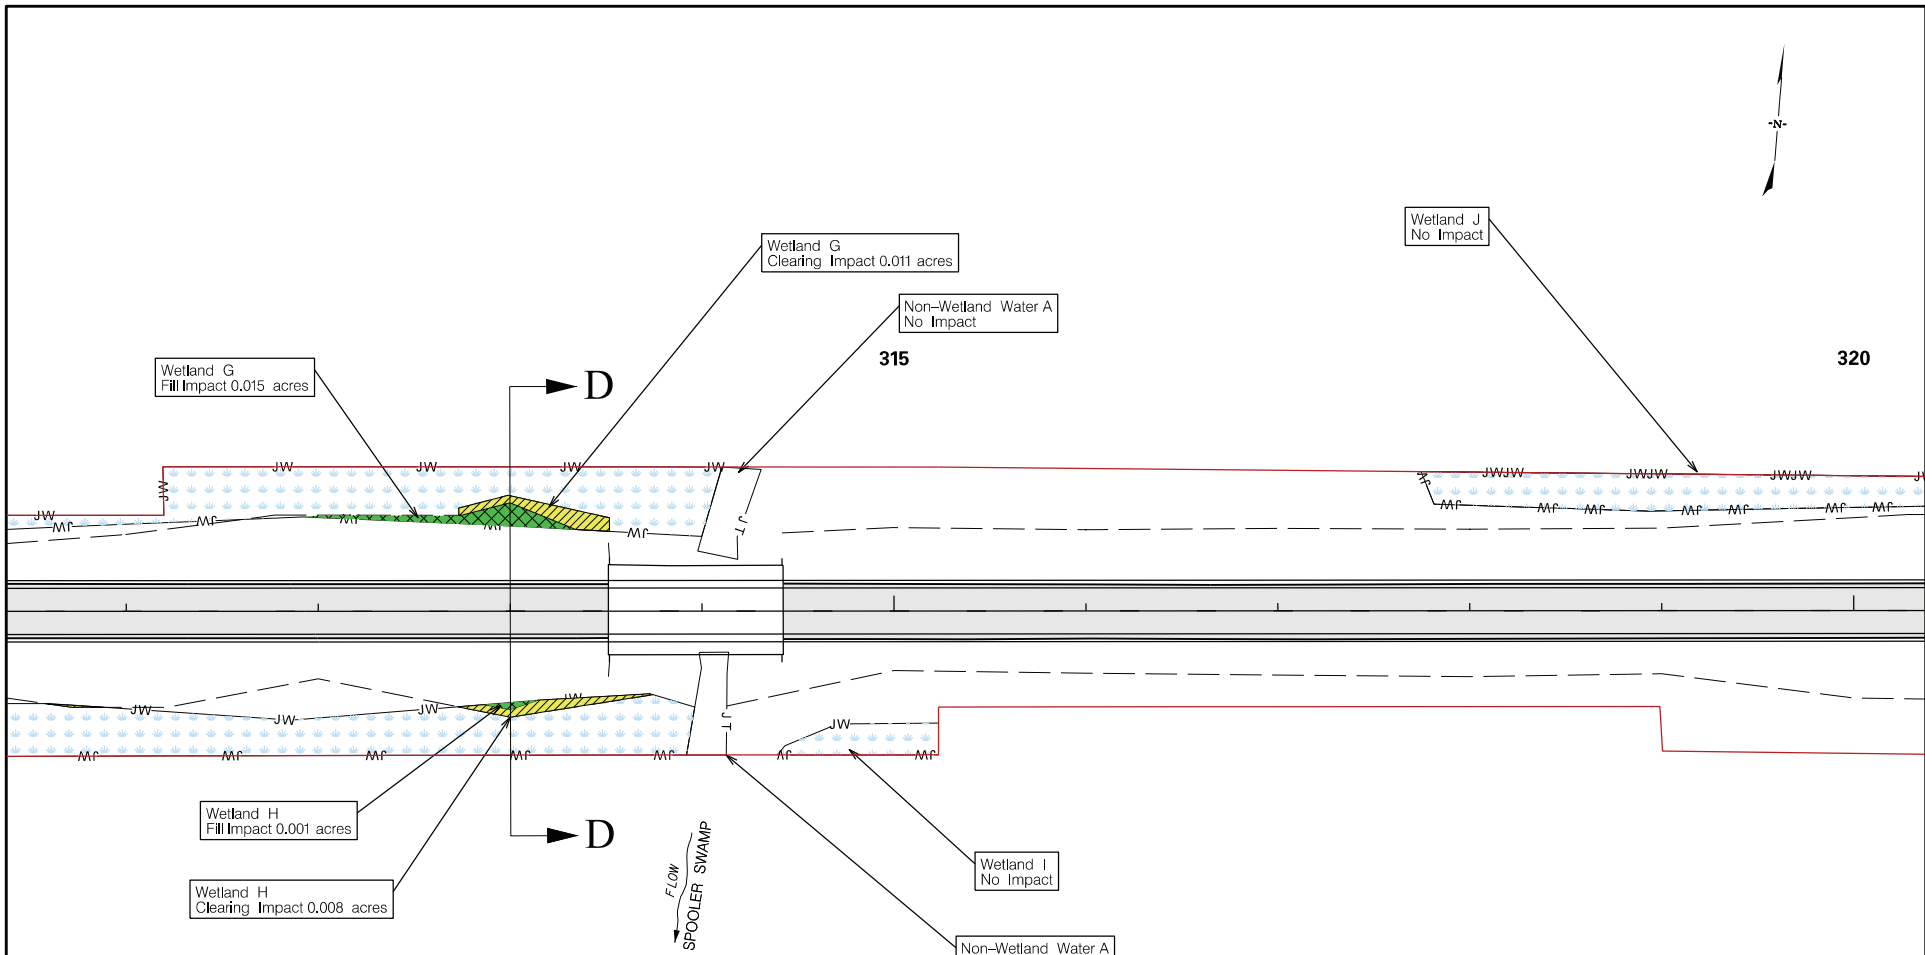





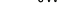




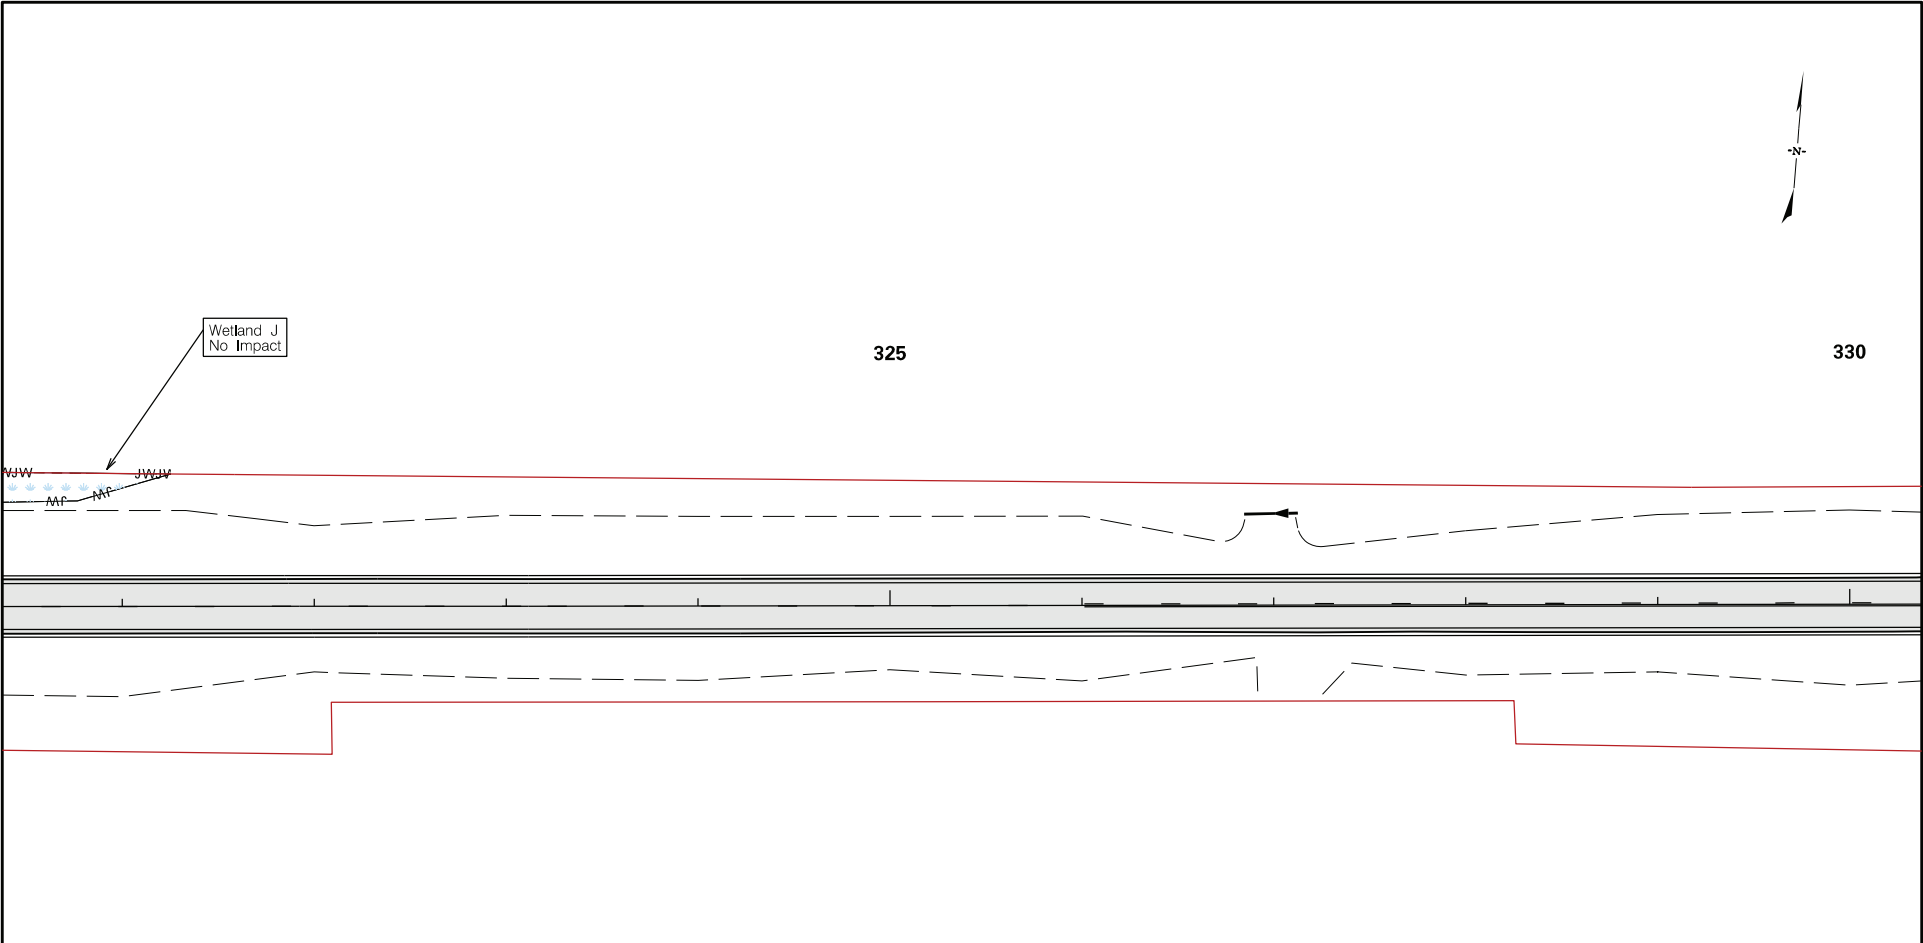


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
- = PROJECT STUDY AREA
- = PROPOSED CULVERT
- = PROPOSED PIPE
- = LIMITS OF CONSTRUCTION
- JW — = WETLAND
- JT — = NON-WETLAND WATER
- OW — = NON-WETLAND WATER POND
- [Pattern] = RIP-RAP
- [Green Grid] = WETLAND FILL IMPACT
- [Grey Box] = EXISTING ROADWAY
- [Yellow Grid] = WETLAND CLEARING IMPACT
- [Blue Grid] = NON-WETLAND WATER IMPACT


APPLICANT	SHEET TITLE	PROJECT TITLE
 South Carolina Department of Transportation	<b>USACE IMPACT PLAN VIEW</b>  <b>SCALE: 1" = 100'</b>	<b>DORCHESTER COUNTY PROJECT P062321 PROPOSED ROAD US 17A TRAFFIC SAFETY PROJECT</b>
<b>Sheet Totals:</b> Wetland Fill: 0.016 acres Wetland Clearing: 0.019 acres		<b>SHEET No. 17 OF 67</b>

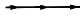

**LEGEND**

-  = PROJECT STUDY AREA
-  = PROPOSED CULVERT
-  = PROPOSED PIPE
-  = LIMITS OF CONSTRUCTION
-  = WETLAND
-  = NON-WETLAND WATER
-  = NON-WETLAND WATER POND
-  = RIP-RAP
-  = WETLAND FILL IMPACT
-  = EXISTING ROADWAY
-  = WETLAND CLEARING IMPACT
-  = NON-WETLAND WATER IMPACT


<p>APPLICANT</p>  <p>South Carolina Department of Transportation</p>		<p>SHEET TITLE</p> <p><b>USACE IMPACT PLAN VIEW</b></p> <p>SCALE: 1" = 100'</p>	<p>PROJECT TITLE</p> <p><b>DORCHESTER COUNTY PROJECT P062321 PROPOSED ROAD US 17A TRAFFIC SAFETY PROJECT</b></p> <p>SHEET No. 18 OF 67</p>
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**LEGEND**

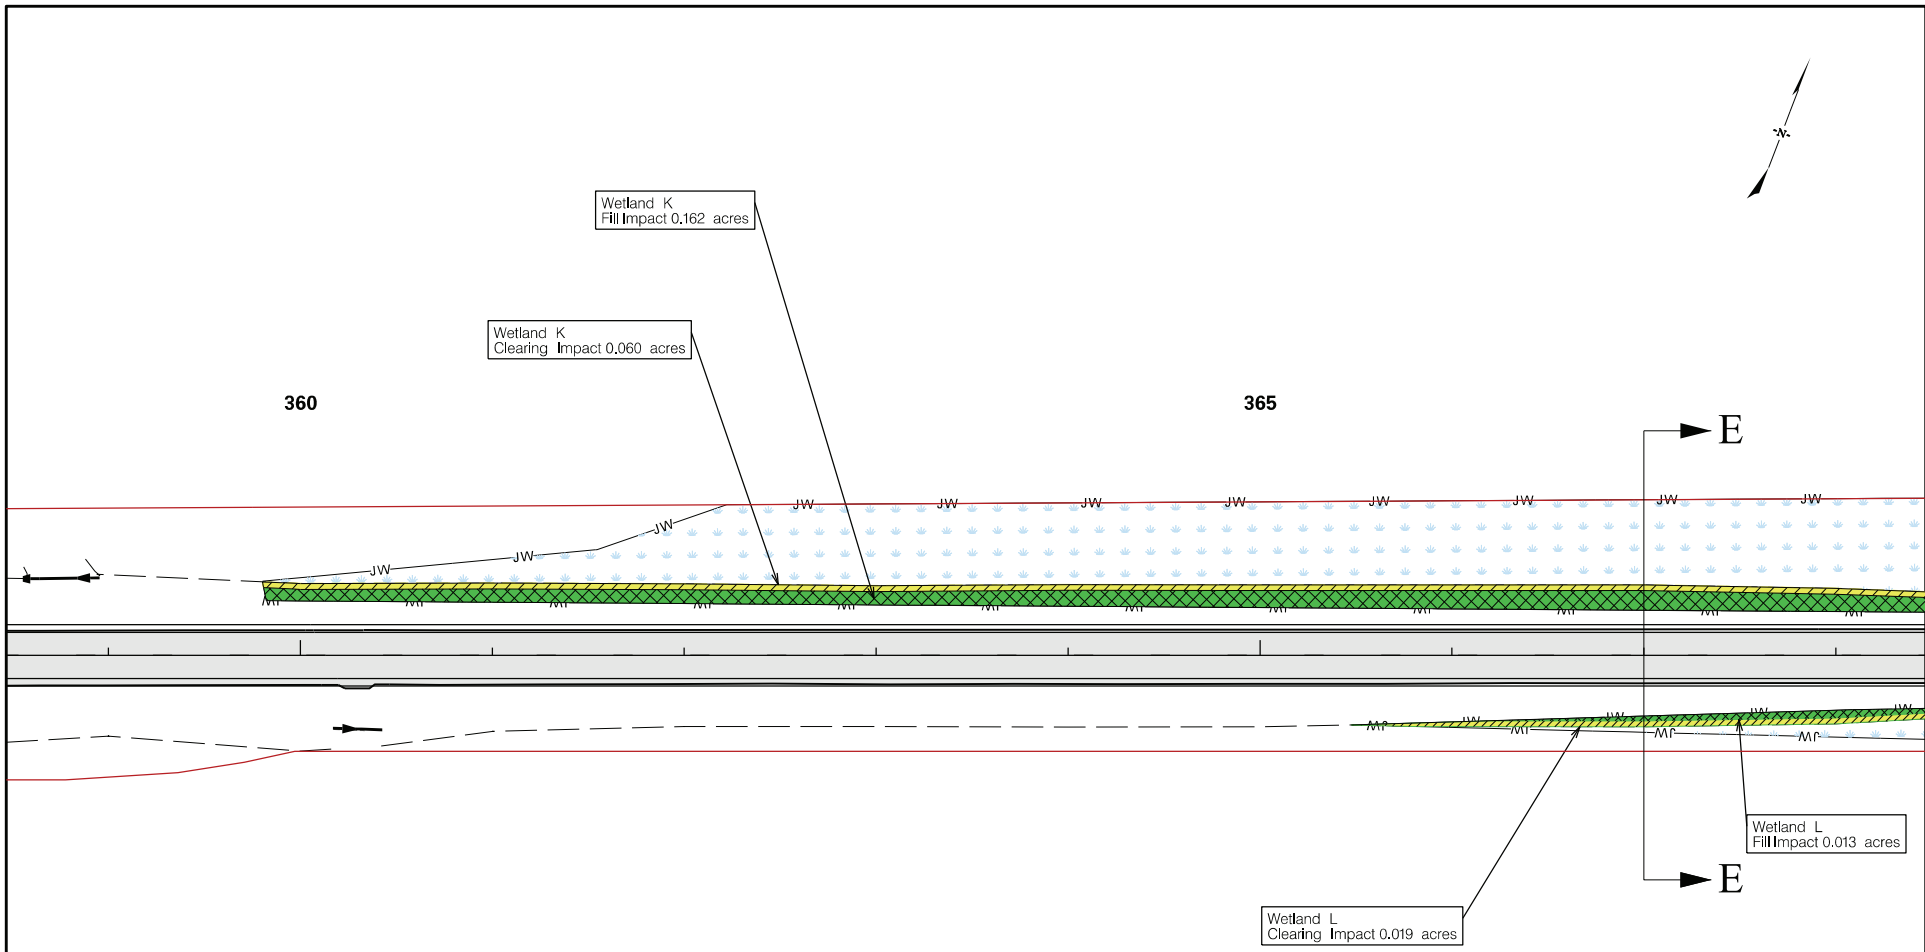- = PROJECT STUDY AREA
- = PROPOSED CULVERT
- = PROPOSED PIPE
- = LIMITS OF CONSTRUCTION
- JW = WETLAND
- JT = NON-WETLAND WATER
- OW = NON-WETLAND WATER POND
- = RIP-RAP
- = WETLAND FILL IMPACT
- = EXISTING ROADWAY
- = WETLAND CLEARING IMPACT
- = NON-WETLAND WATER IMPACT

APPLICANT		SHEET TITLE	PROJECT TITLE
 South Carolina Department of Transportation	Sheet Totals: Wetland Fill: 0.175 acres Wetland Clearing: 0.079 acres	<b>USACE IMPACT PLAN VIEW</b>  SCALE: 1" = 100'	<b>DORCHESTER COUNTY PROJECT P062321 PROPOSED ROAD US 17A TRAFFIC SAFETY PROJECT</b>
			SHEET No. 19 OF 67



**LEGEND**

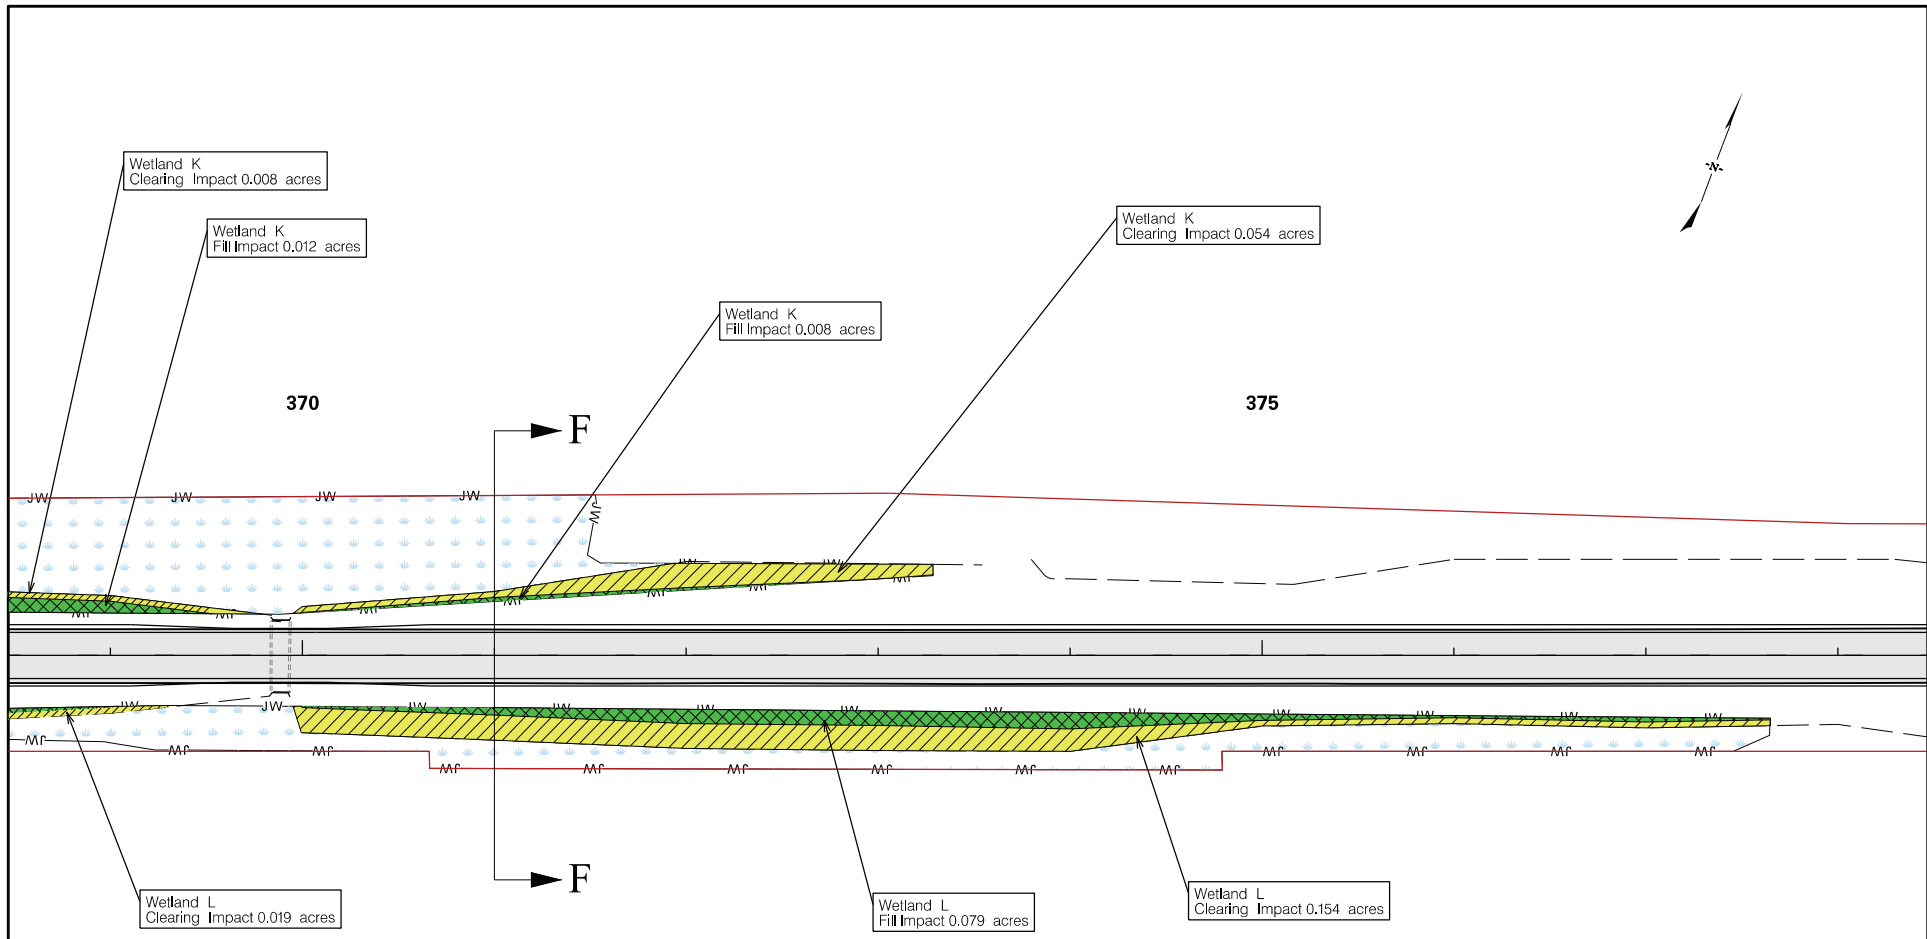- = PROJECT STUDY AREA
- = PROPOSED CULVERT
- = PROPOSED PIPE
- = LIMITS OF CONSTRUCTION
- JW — = WETLAND
- JT — = NON-WETLAND WATER
- OW — = NON-WETLAND WATER POND
- = RIP-RAP
- = WETLAND FILL IMPACT
- = EXISTING ROADWAY
- = WETLAND CLEARING IMPACT
- = NON-WETLAND WATER IMPACT


<b>APPLICANT</b>   South Carolina Department of Transportation
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<b>Sheet Totals:</b> Wetland Fill: 0.099 acres Wetland Clearing: 0.235 acres
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



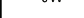







<b>SHEET TITLE</b>  USACE IMPACT PLAN VIEW  SCALE: 1" = 100'
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
<b>PROJECT TITLE</b>  DORCHESTER COUNTY PROJECT P062321 PROPOSED ROAD US 17A TRAFFIC SAFETY PROJECT  SHEET No. 20 OF 67
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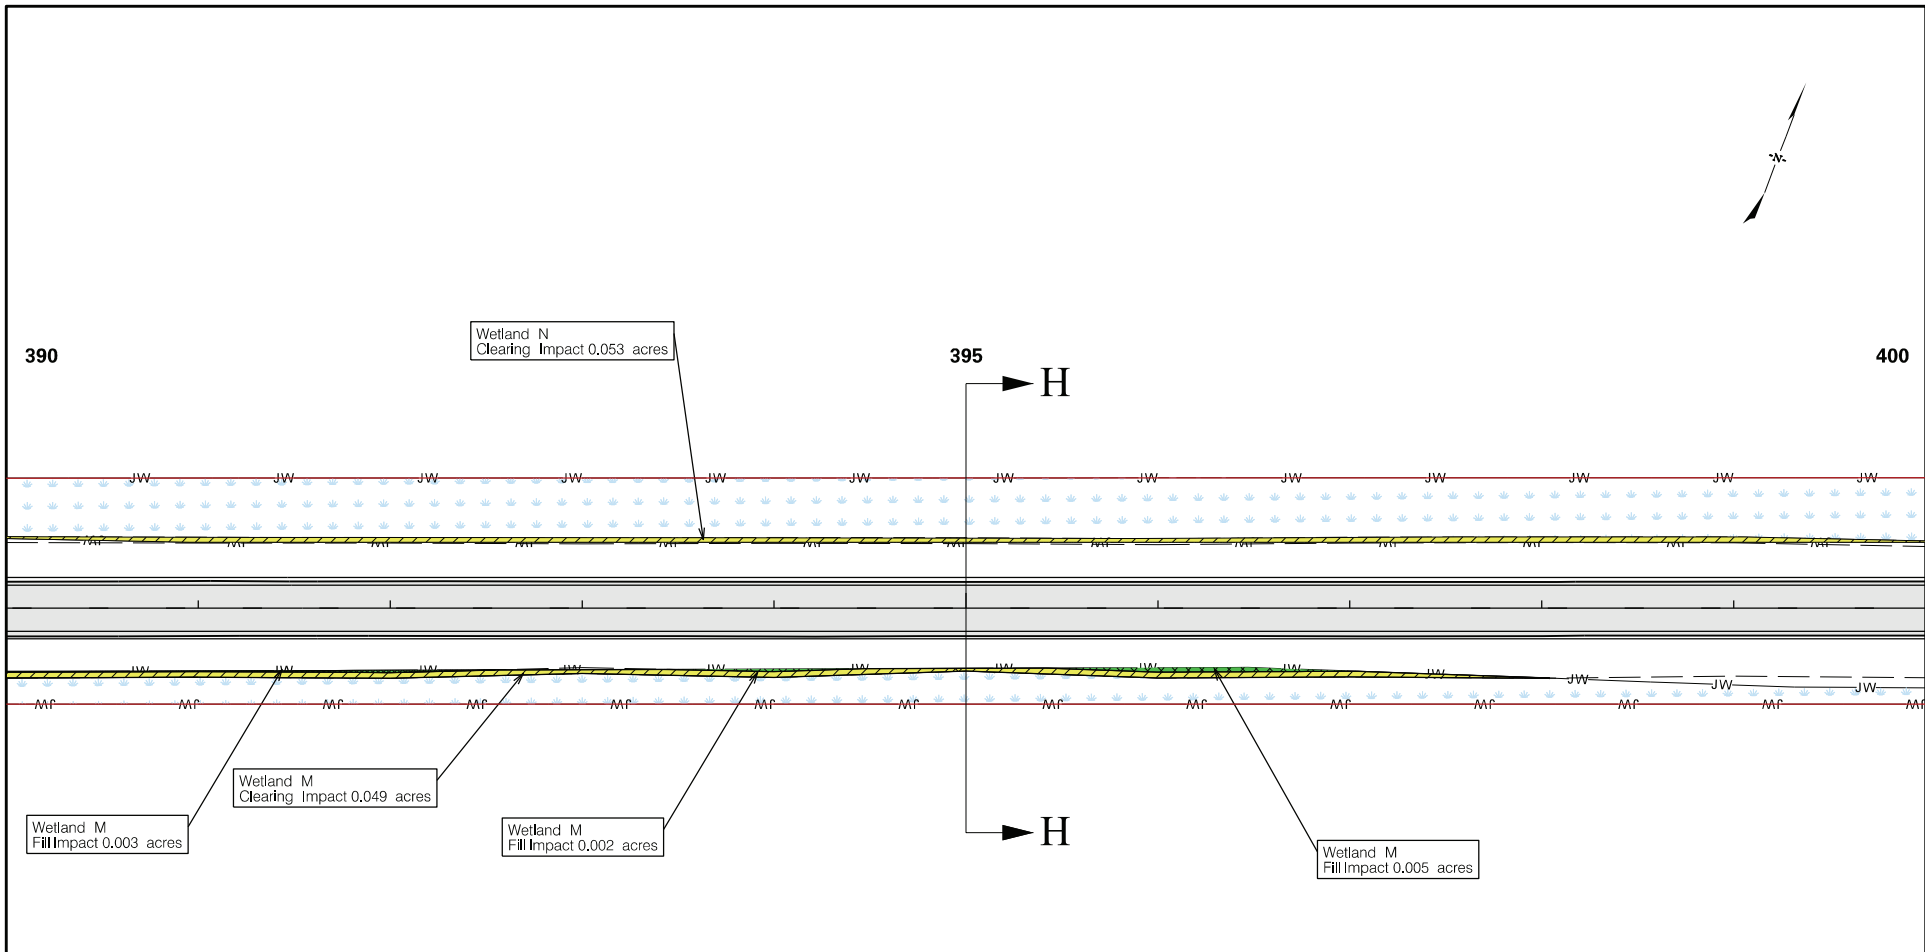


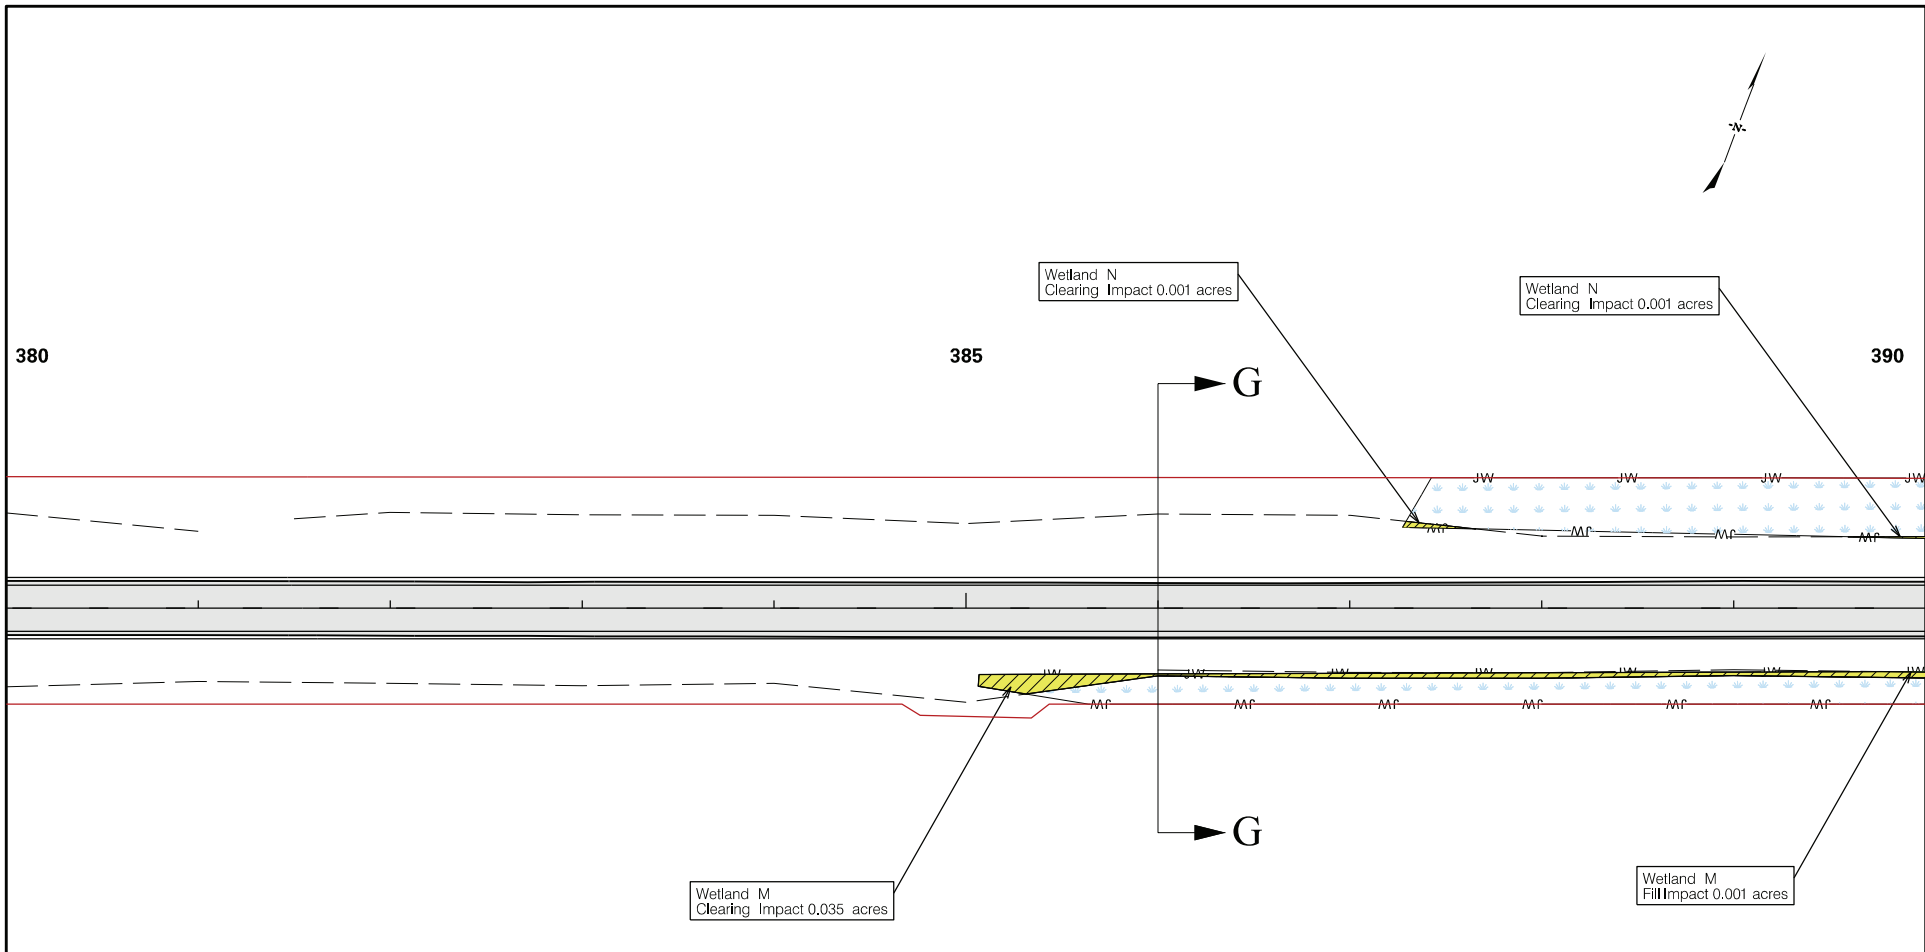

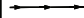**LEGEND**

-  = PROJECT STUDY AREA
-  = PROPOSED CULVERT
-  = PROPOSED PIPE
-  = LIMITS OF CONSTRUCTION
-  = WETLAND
-  = NON-WETLAND WATER
-  = NON-WETLAND WATER POND
-  = RIP-RAP
-  = WETLAND FILL IMPACT
-  = EXISTING ROADWAY
-  = WETLAND CLEARING IMPACT
-  = NON-WETLAND WATER IMPACT

APPLICANT	SHEET TITLE	PROJECT TITLE
 South Carolina Department of Transportation	<b>USACE IMPACT PLAN VIEW</b>  <b>SCALE: 1" = 100'</b>	<b>DORCHESTER COUNTY PROJECT P062321 PROPOSED ROAD US 17A TRAFFIC SAFETY PROJECT</b>
<b>Sheet Totals:</b> Wetland Fill: 0.001 acres Wetland Clearing: 0.037 acres		<b>SHEET No. 21 OF 67</b>




LEGEND	
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	= PROPOSED CULVERT
	= PROPOSED PIPE
	= LIMITS OF CONSTRUCTION
	= WETLAND
	= NON-WETLAND WATER
	= NON-WETLAND WATER POND
	= RIP-RAP
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	= EXISTING ROADWAY
	= WETLAND CLEARING IMPACT
	= NON-WETLAND WATER IMPACT

APPLICANT
 South Carolina Department of Transportation








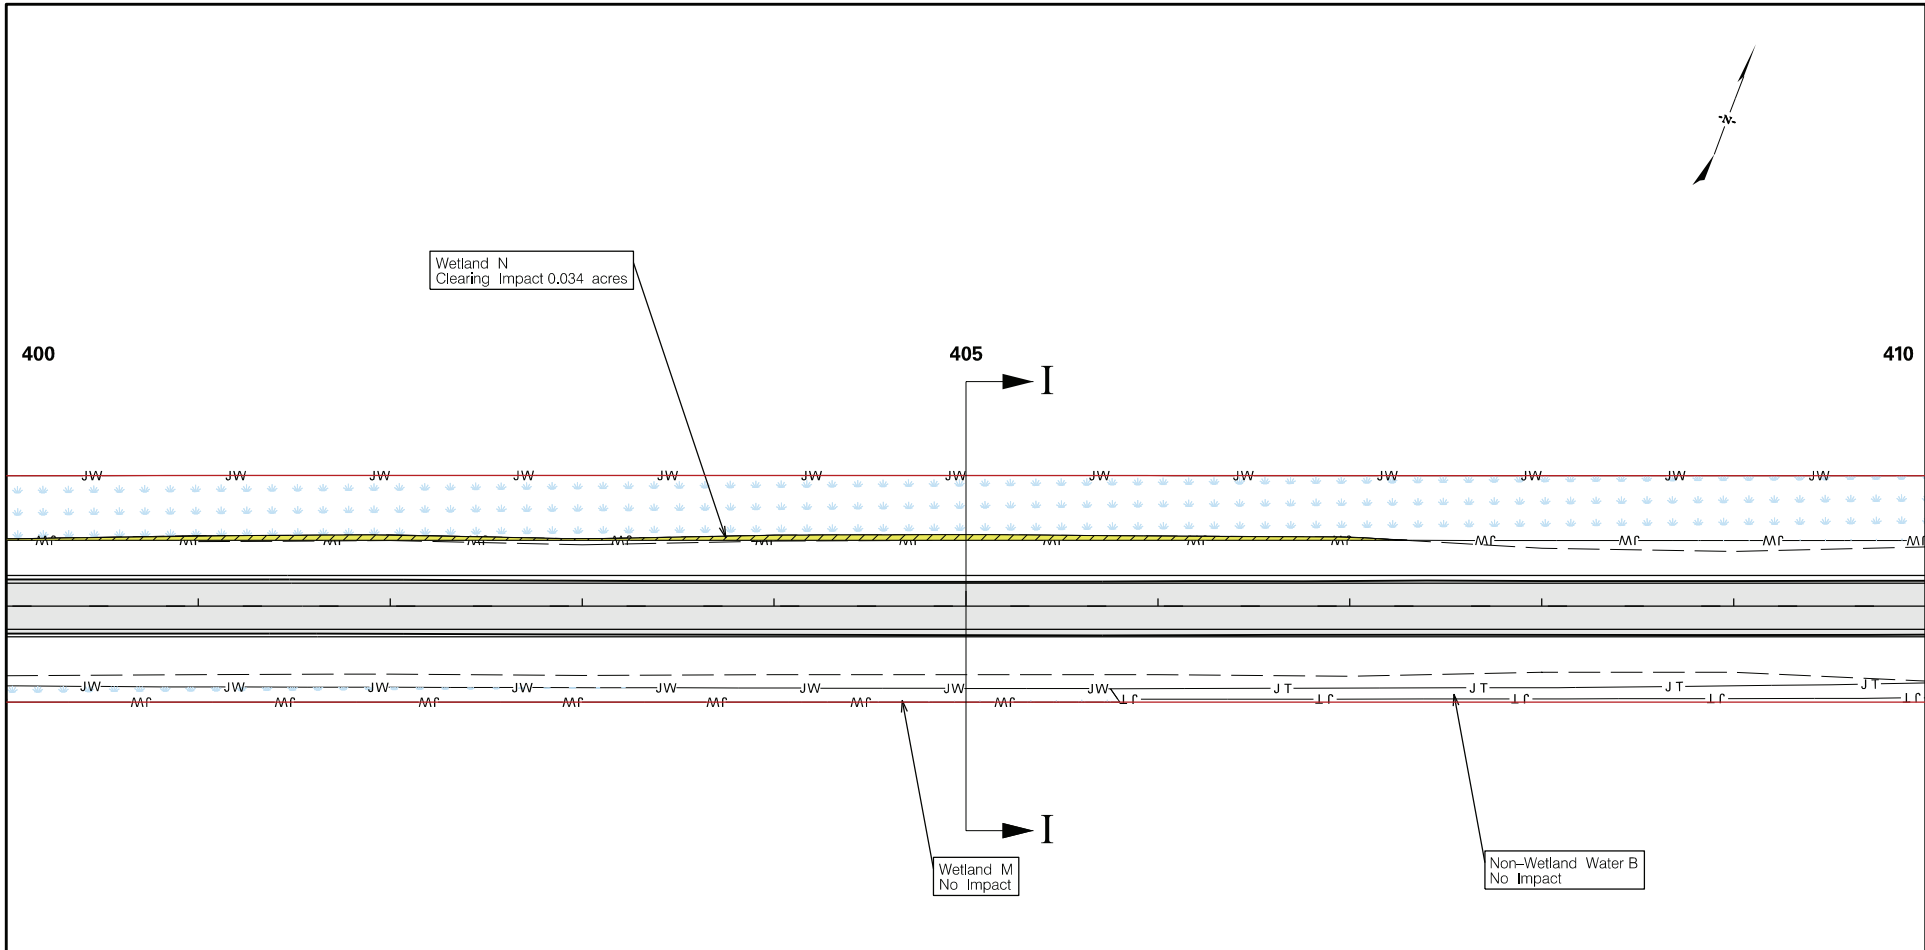




Sheet Totals: Wetland Fill: 0.010 acres Wetland Clearing: 0.102 acres
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SHEET TITLE
USACE IMPACT PLAN VIEW
SCALE: 1" = 100'

PROJECT TITLE
DORCHESTER COUNTY PROJECT P062321 PROPOSED ROAD US 17A TRAFFIC SAFETY PROJECT
SHEET No. 22 OF 67

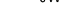

**LEGEND**

-  = PROJECT STUDY AREA
-  = PROPOSED CULVERT
-  = PROPOSED PIPE
-  = LIMITS OF CONSTRUCTION
-  = WETLAND
-  = NON-WETLAND WATER
-  = NON-WETLAND WATER POND
-  = RIP-RAP
-  = WETLAND FILL IMPACT
-  = EXISTING ROADWAY
-  = WETLAND CLEARING IMPACT
-  = NON-WETLAND WATER IMPACT


<b>APPLICANT</b>   <small>South Carolina Department of Transportation</small>
---

Sheet Totals:  
 Wetland Clearing: 0.034 acres

SHEET TITLE  
**USACE IMPACT  
 PLAN VIEW**

SCALE: 1" = 100'

PROJECT TITLE  
**DORCHESTER COUNTY  
 PROJECT P062321  
 PROPOSED ROAD US 17A  
 TRAFFIC SAFETY PROJECT**

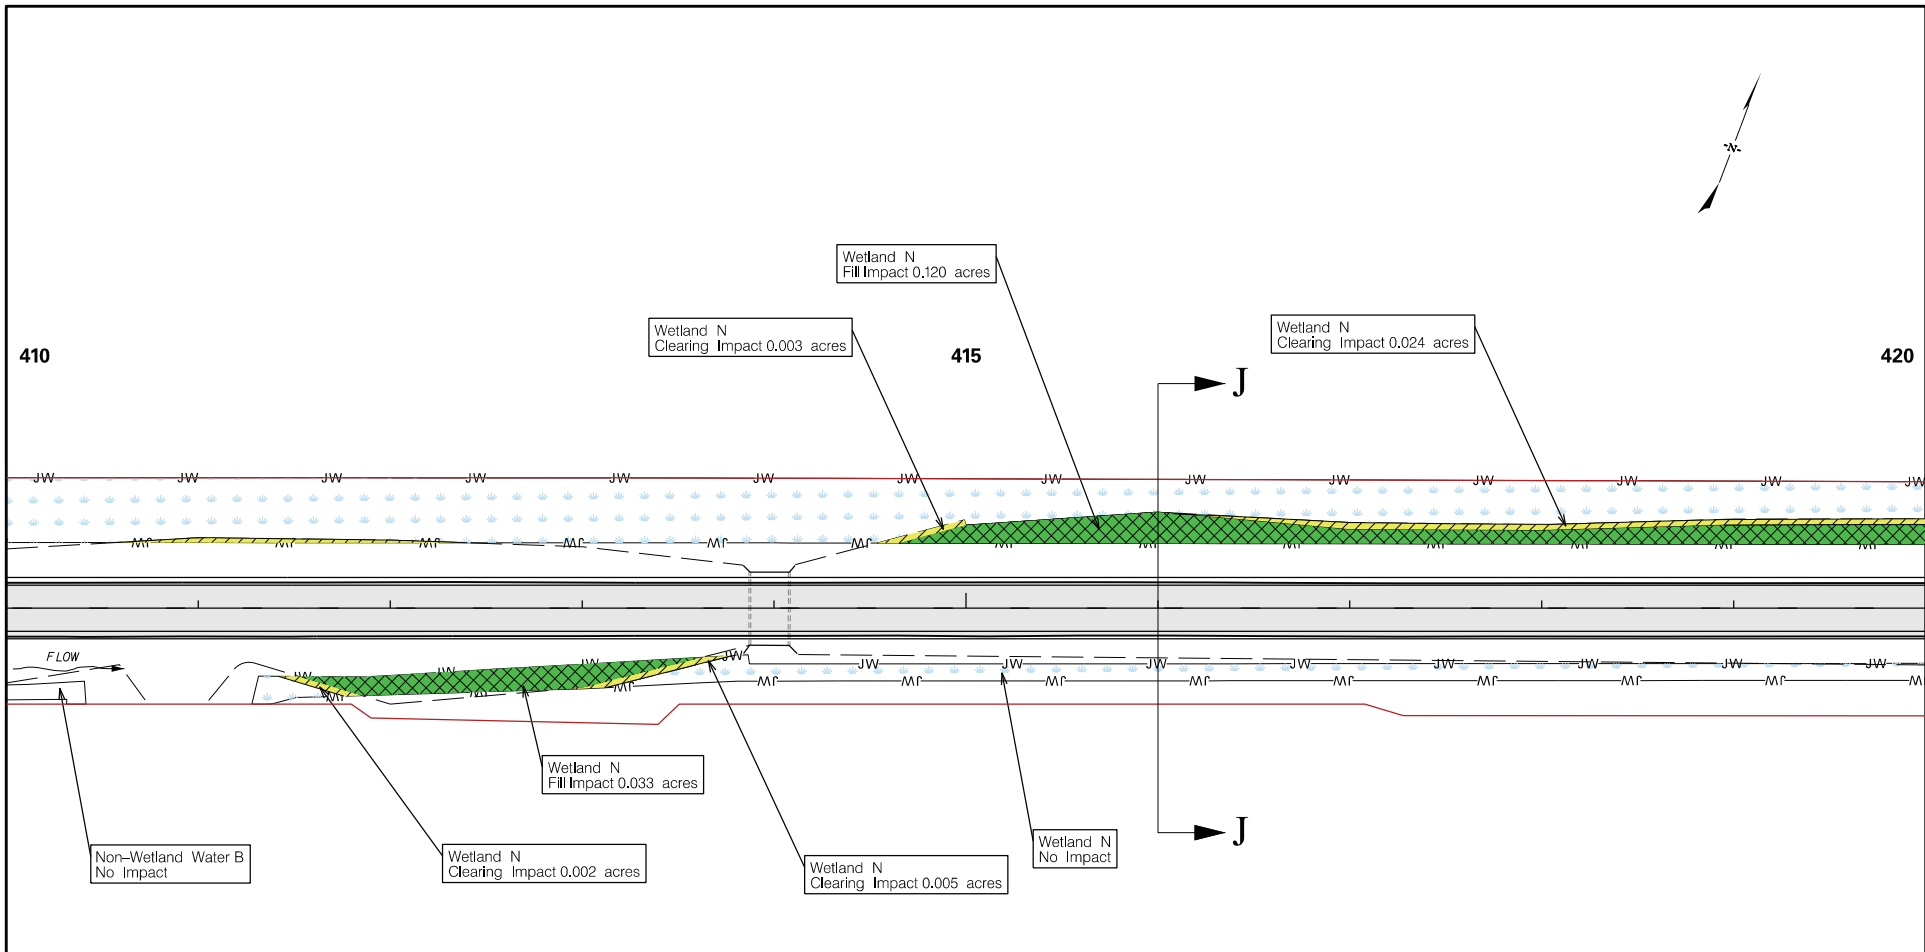

**LEGEND**

- = PROJECT STUDY AREA
- = PROPOSED CULVERT
- = PROPOSED PIPE
- = LIMITS OF CONSTRUCTION
- JW — = WETLAND
- JT — = NON-WETLAND WATER
- OW — = NON-WETLAND WATER POND
- [RIP-RAP] = RIP-RAP
- [Green Cross-hatch] = WETLAND FILL IMPACT
- [Grey] = EXISTING ROADWAY
- [Yellow Diagonal] = WETLAND CLEARING IMPACT
- [Blue Grid] = NON-WETLAND WATER IMPACT

**APPLICANT**




South Carolina Department of Transportation

<p>Sheet Totals:</p> <p>Wetland Fill: 0.153 acres</p> <p>Wetland Clearing: 0.034 acres</p>	
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<p>SHEET TITLE</p> <p><b>USACE IMPACT PLAN VIEW</b></p> <p>SCALE: 1" = 100'</p>
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<p>PROJECT TITLE</p> <p><b>DORCHESTER COUNTY PROJECT P062321 PROPOSED ROAD US 17A TRAFFIC SAFETY PROJECT</b></p>
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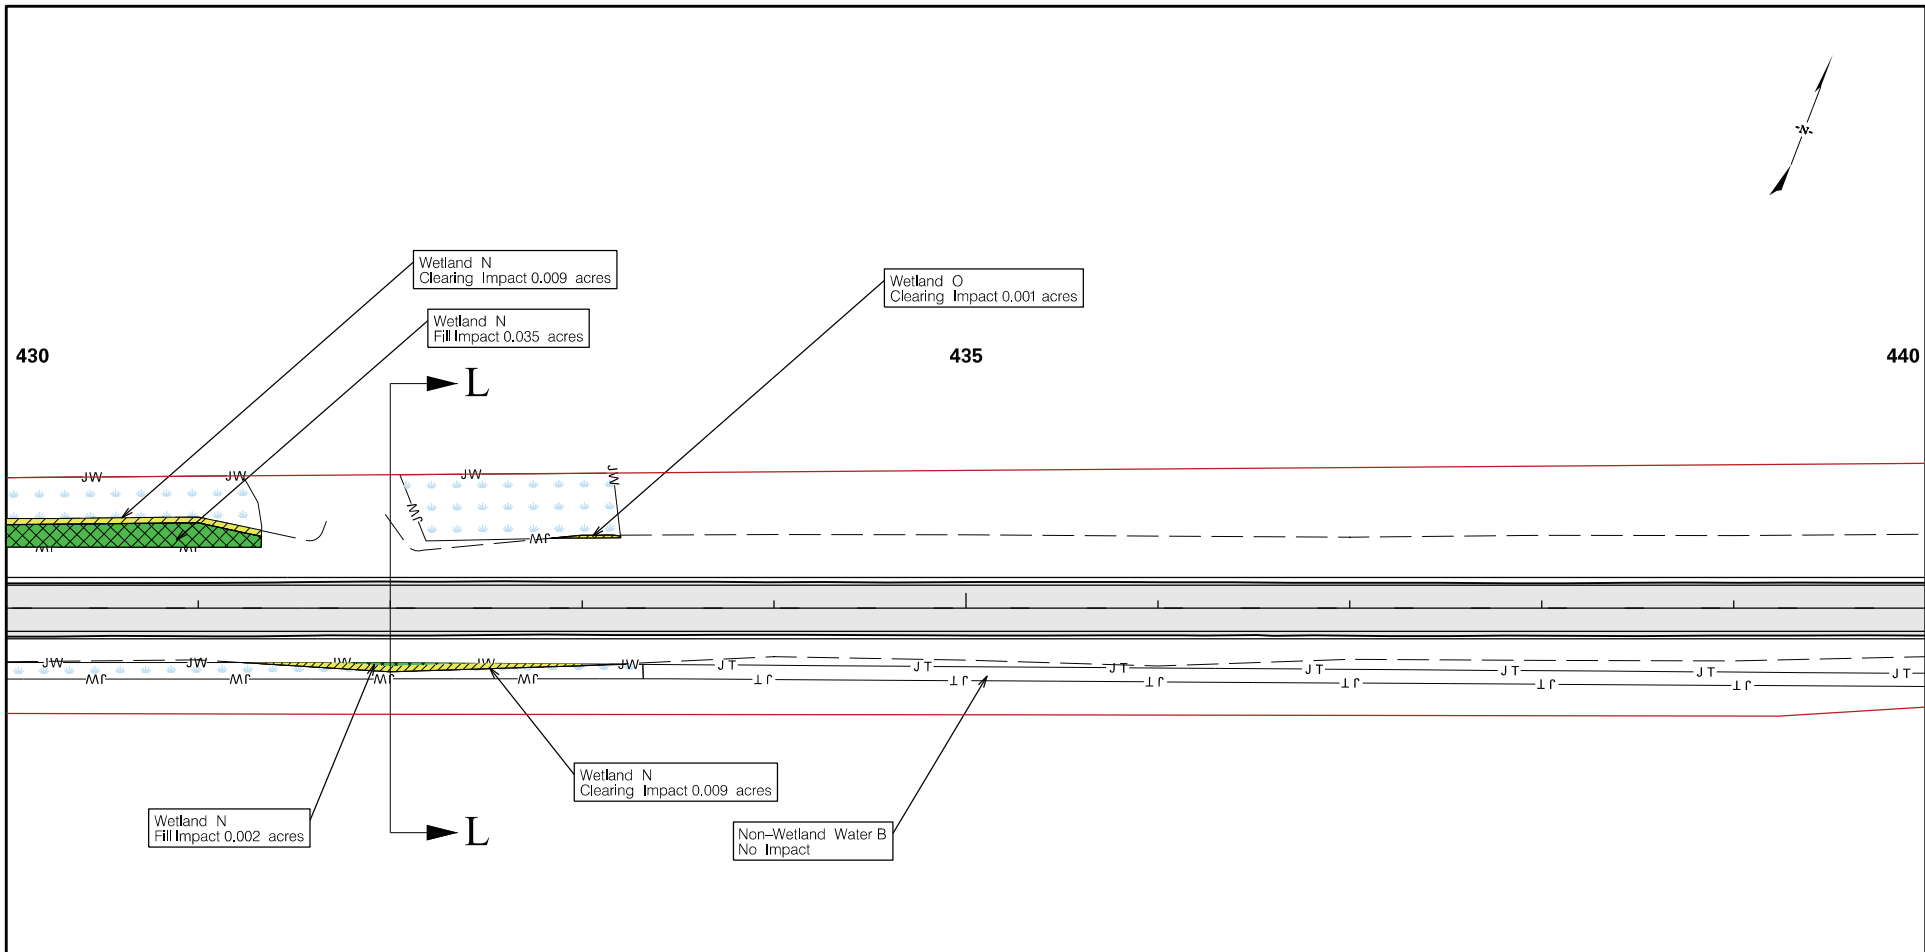
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	= PROJECT STUDY AREA
	= PROPOSED CULVERT
	= PROPOSED PIPE
	= LIMITS OF CONSTRUCTION
	= WETLAND
	= NON-WETLAND WATER
	= NON-WETLAND WATER POND
	= RIP-RAP
	= WETLAND FILL IMPACT
	= EXISTING ROADWAY
	= WETLAND CLEARING IMPACT
	= NON-WETLAND WATER IMPACT

APPLICANT
 South Carolina Department of Transportation

<b>Sheet Totals:</b> <b>Wetland Fill:</b> 0.276 acres <b>Wetland Clearing:</b> 0.104 acres
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SHEET TITLE
USACE IMPACT PLAN VIEW
SCALE: 1" = 100'

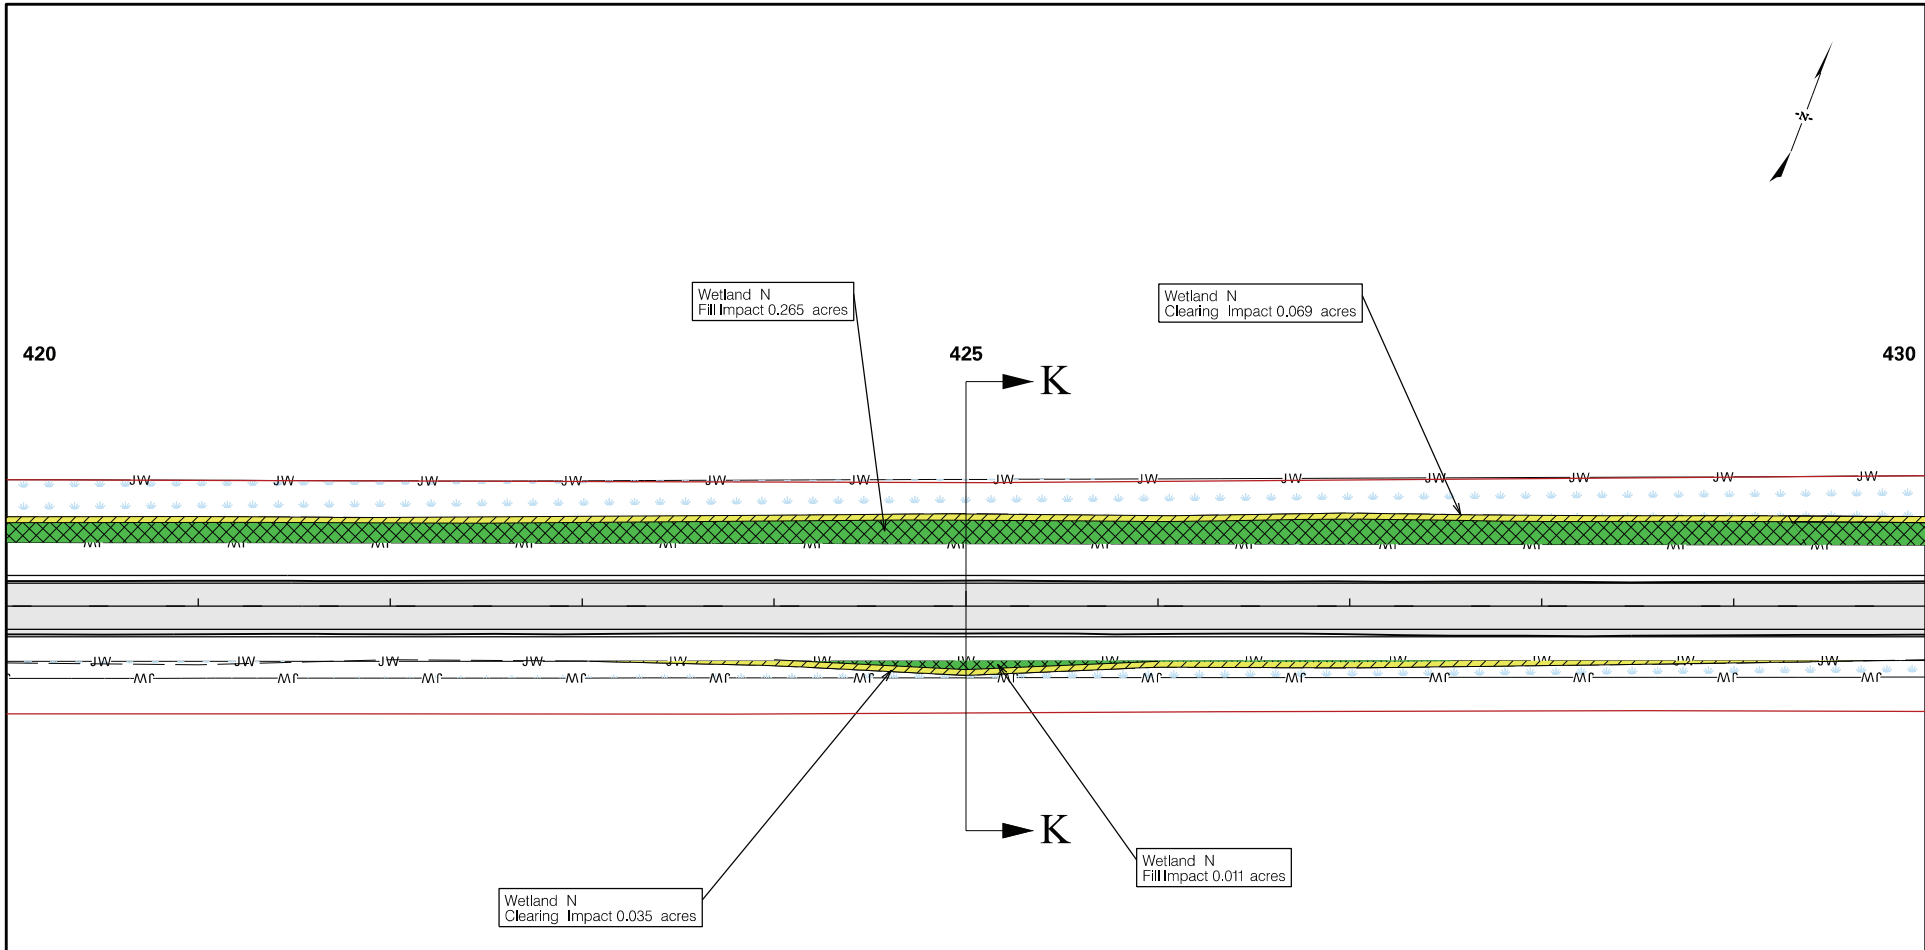
PROJECT TITLE
DORCHESTER COUNTY PROJECT P062321 PROPOSED ROAD US 17A TRAFFIC SAFETY PROJECT
SHEET No. 25 OF 67



**LEGEND**

- = PROJECT STUDY AREA
- = PROPOSED CULVERT
- = PROPOSED PIPE
- = LIMITS OF CONSTRUCTION
- JW — = WETLAND
- JT — = NON-WETLAND WATER
- OW — = NON-WETLAND WATER POND
- = RIP-RAP
- = WETLAND FILL IMPACT
- = EXISTING ROADWAY
- = WETLAND CLEARING IMPACT
- = NON-WETLAND WATER IMPACT


APPLICANT	SHEET TITLE	PROJECT TITLE
 South Carolina Department of Transportation	<b>USACE IMPACT PLAN VIEW</b>  <b>SCALE: 1" = 100'</b>	<b>DORCHESTER COUNTY PROJECT P062321 PROPOSED ROAD US 17A TRAFFIC SAFETY PROJECT</b>
<b>Sheet Totals:</b> Wetland Fill: 0.037 acres Wetland Clearing: 0.019 acres		<b>SHEET No. 26 OF 67</b>

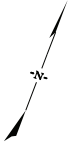










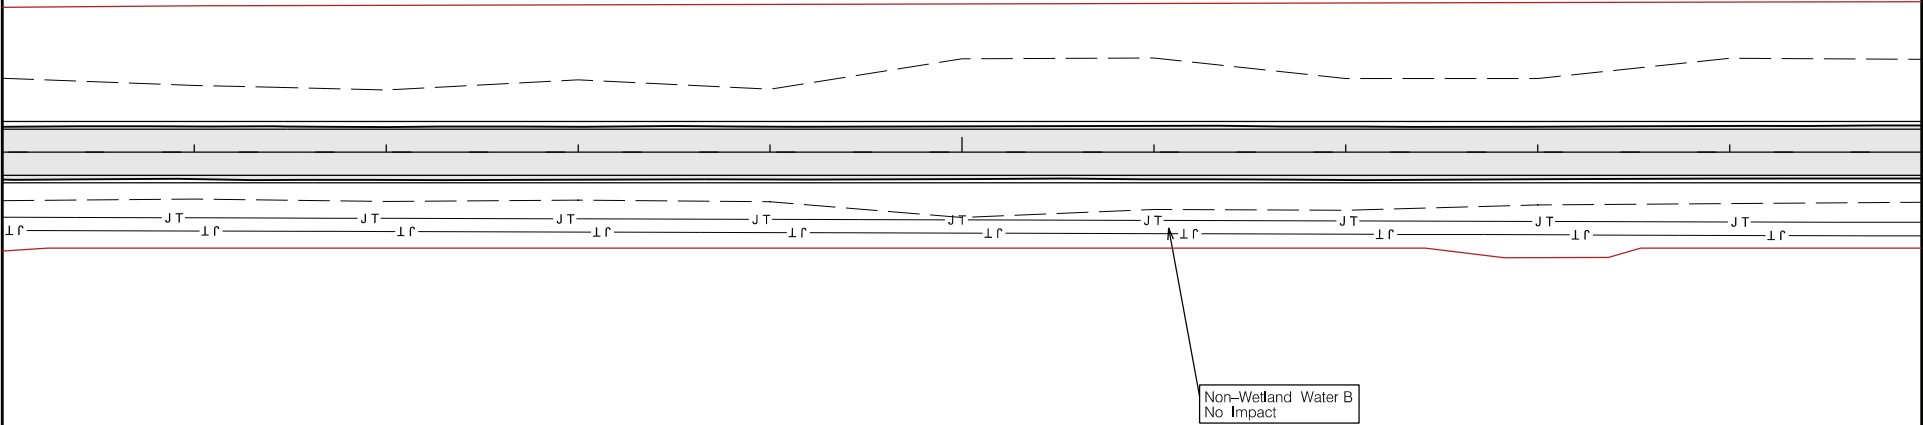


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
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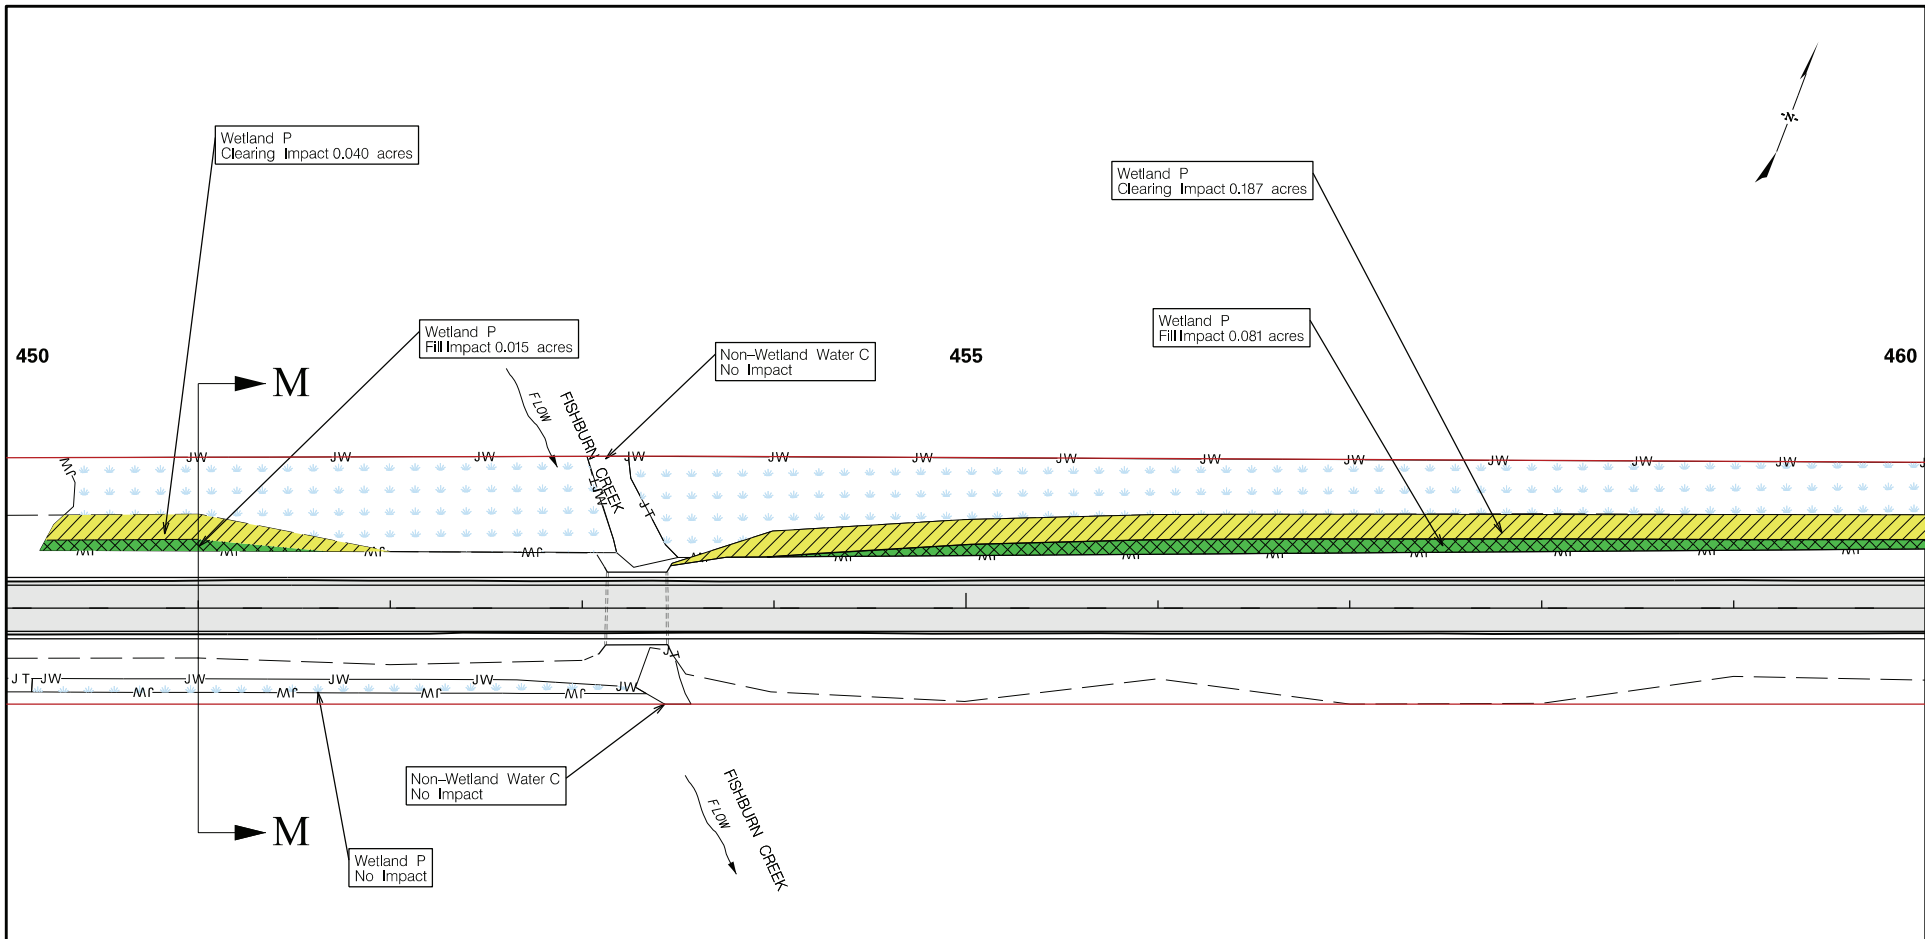
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**LEGEND**

-  = PROJECT STUDY AREA
-  = PROPOSED CULVERT
-  = PROPOSED PIPE
-  = LIMITS OF CONSTRUCTION
-  = WETLAND
-  = NON-WETLAND WATER
-  = NON-WETLAND WATER POND
-  = RIP-RAP
-  = WETLAND FILL IMPACT
-  = EXISTING ROADWAY
-  = WETLAND CLEARING IMPACT
-  = NON-WETLAND WATER IMPACT

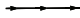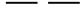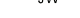APPLICANT		SHEET TITLE	PROJECT TITLE
 <small>South Carolina Department of Transportation</small>		<b>USACE IMPACT PLAN VIEW</b>	<b>DORCHESTER COUNTY PROJECT P062321 PROPOSED ROAD US 17A TRAFFIC SAFETY PROJECT</b>
		<b>SCALE: 1" = 100'</b>	<b>SHEET No. 27 OF 67</b>




**LEGEND**








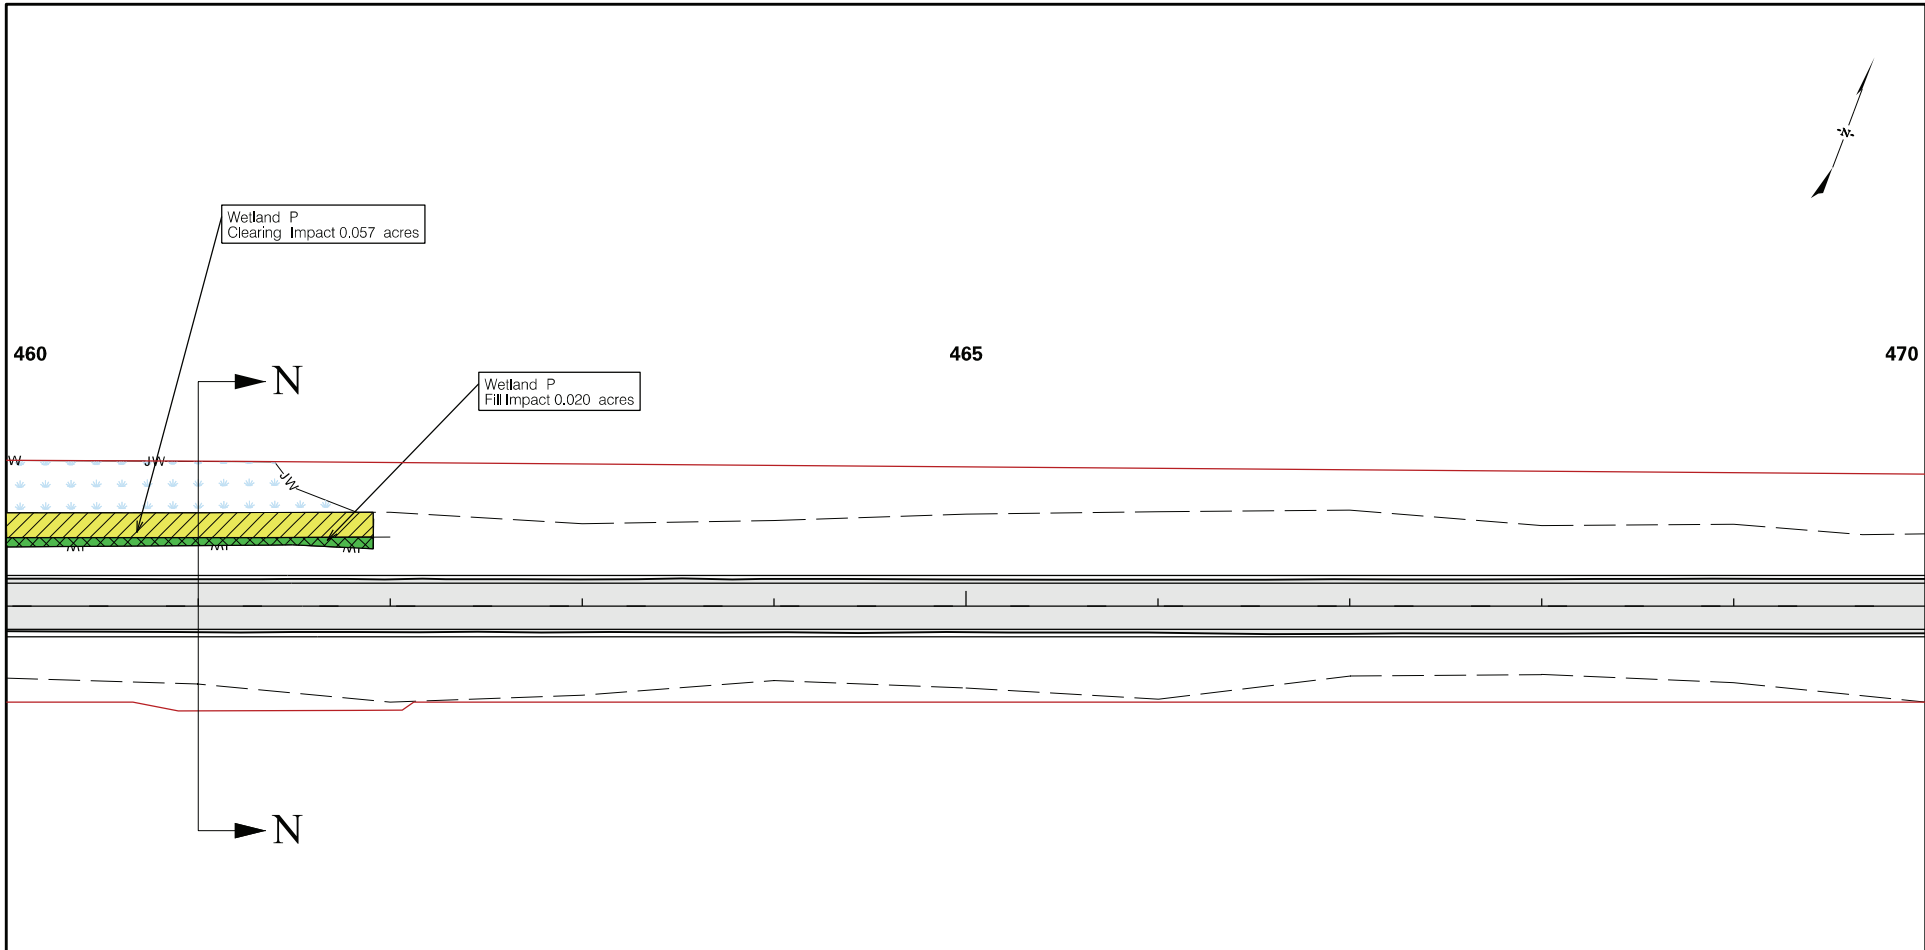




- = PROJECT STUDY AREA
- = PROPOSED CULVERT
- = PROPOSED PIPE
- = LIMITS OF CONSTRUCTION
- = WETLAND
- = NON-WETLAND WATER
- = NON-WETLAND WATER POND
- = RIP-RAP
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- = WETLAND CLEARING IMPACT
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
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 South Carolina Department of Transportation	Sheet Totals: Wetland Fill: 0.096 acres Wetland Clearing: 0.227 acres	<b>USACE IMPACT PLAN VIEW</b>  SCALE: 1" = 100'	<b>DORCHESTER COUNTY PROJECT P062321 PROPOSED ROAD US 17A TRAFFIC SAFETY PROJECT</b>
			SHEET No. 28 OF 67



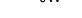

**LEGEND**

-  = PROJECT STUDY AREA
-  = PROPOSED CULVERT
-  = PROPOSED PIPE
-  = LIMITS OF CONSTRUCTION
-  = WETLAND
-  = NON-WETLAND WATER
-  = NON-WETLAND WATER POND
-  = RIP-RAP
-  = WETLAND FILL IMPACT
-  = EXISTING ROADWAY
-  = WETLAND CLEARING IMPACT
-  = NON-WETLAND WATER IMPACT


APPLICANT		SHEET TITLE	PROJECT TITLE
 South Carolina Department of Transportation	Sheet Totals: Wetland Fill: 0.020 acres Wetland Clearing: 0.057 acres	<b>USACE IMPACT PLAN VIEW</b>  SCALE: 1" = 100'	<b>DORCHESTER COUNTY PROJECT P062321 PROPOSED ROAD US 17A TRAFFIC SAFETY PROJECT</b>
			SHEET No. 29 OF 67



495





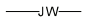

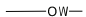


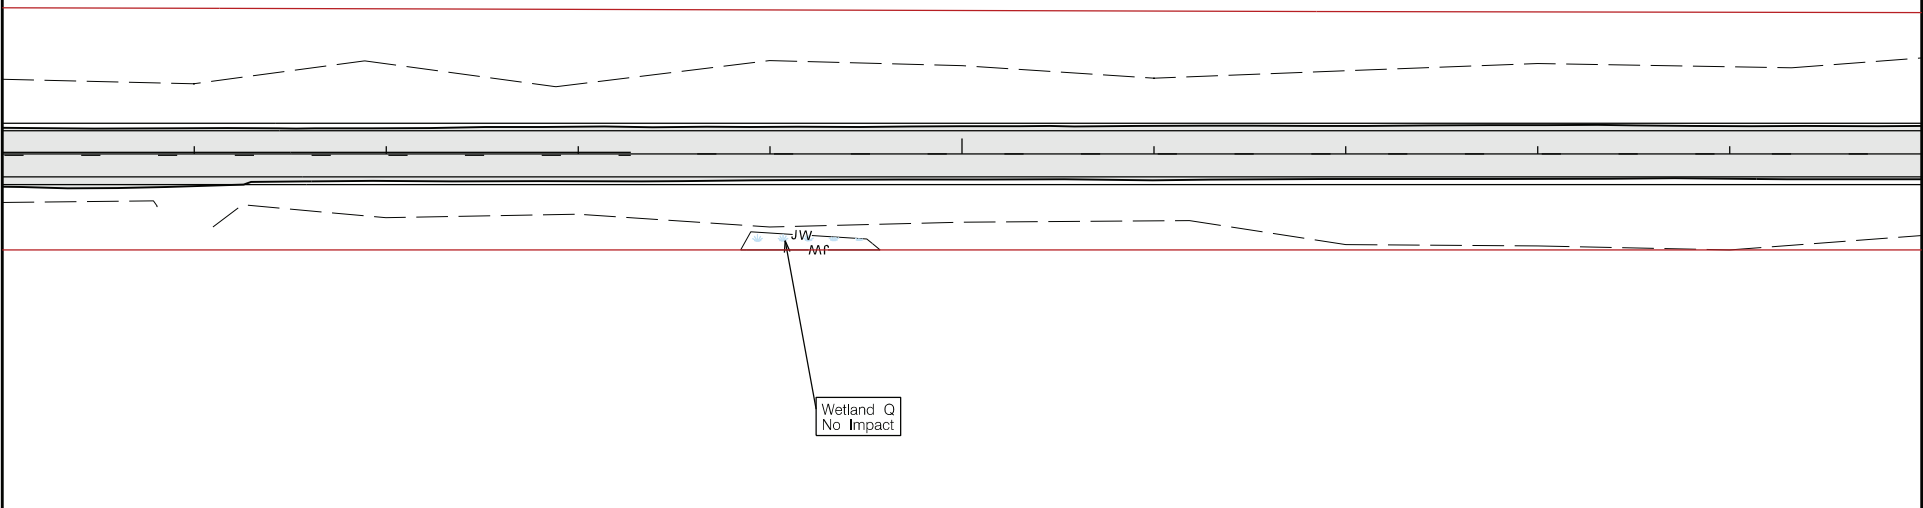


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
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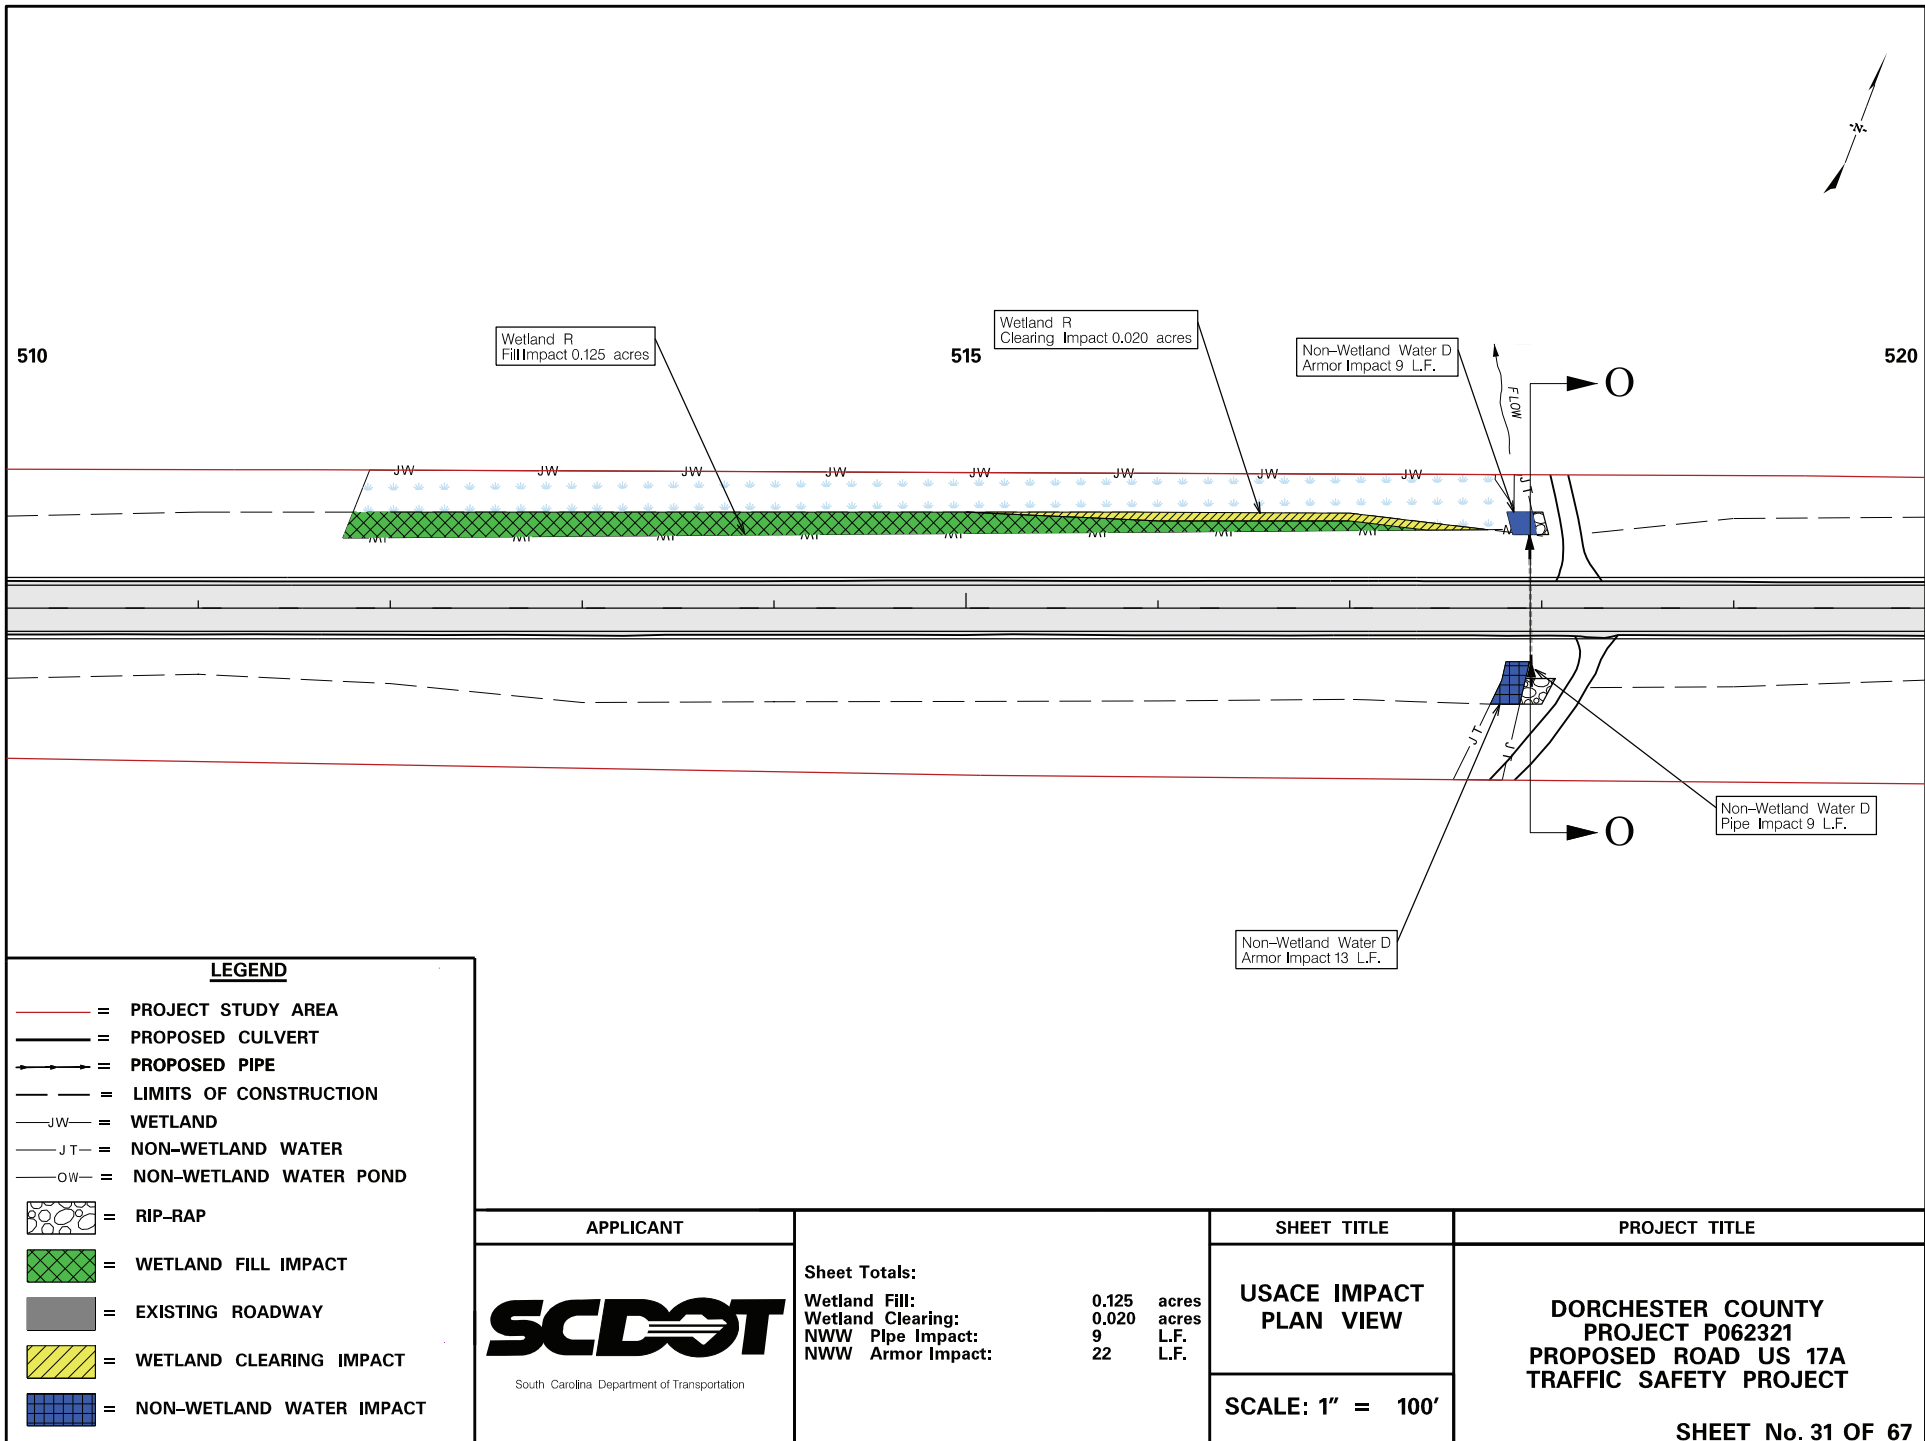



Wetland Q  
No Impact

**LEGEND**

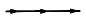-  = PROJECT STUDY AREA
-  = PROPOSED CULVERT
-  = PROPOSED PIPE
-  = LIMITS OF CONSTRUCTION
-  = WETLAND
-  = NON-WETLAND WATER
-  = NON-WETLAND WATER POND
-  = RIP-RAP
-  = WETLAND FILL IMPACT
-  = EXISTING ROADWAY
-  = WETLAND CLEARING IMPACT
-  = NON-WETLAND WATER IMPACT


APPLICANT		SHEET TITLE	PROJECT TITLE
 <small>South Carolina Department of Transportation</small>		<b>USACE IMPACT PLAN VIEW</b>	<b>DORCHESTER COUNTY PROJECT P062321 PROPOSED ROAD US 17A TRAFFIC SAFETY PROJECT</b>
		<b>SCALE: 1" = 100'</b>	<b>SHEET No. 30 OF 67</b>



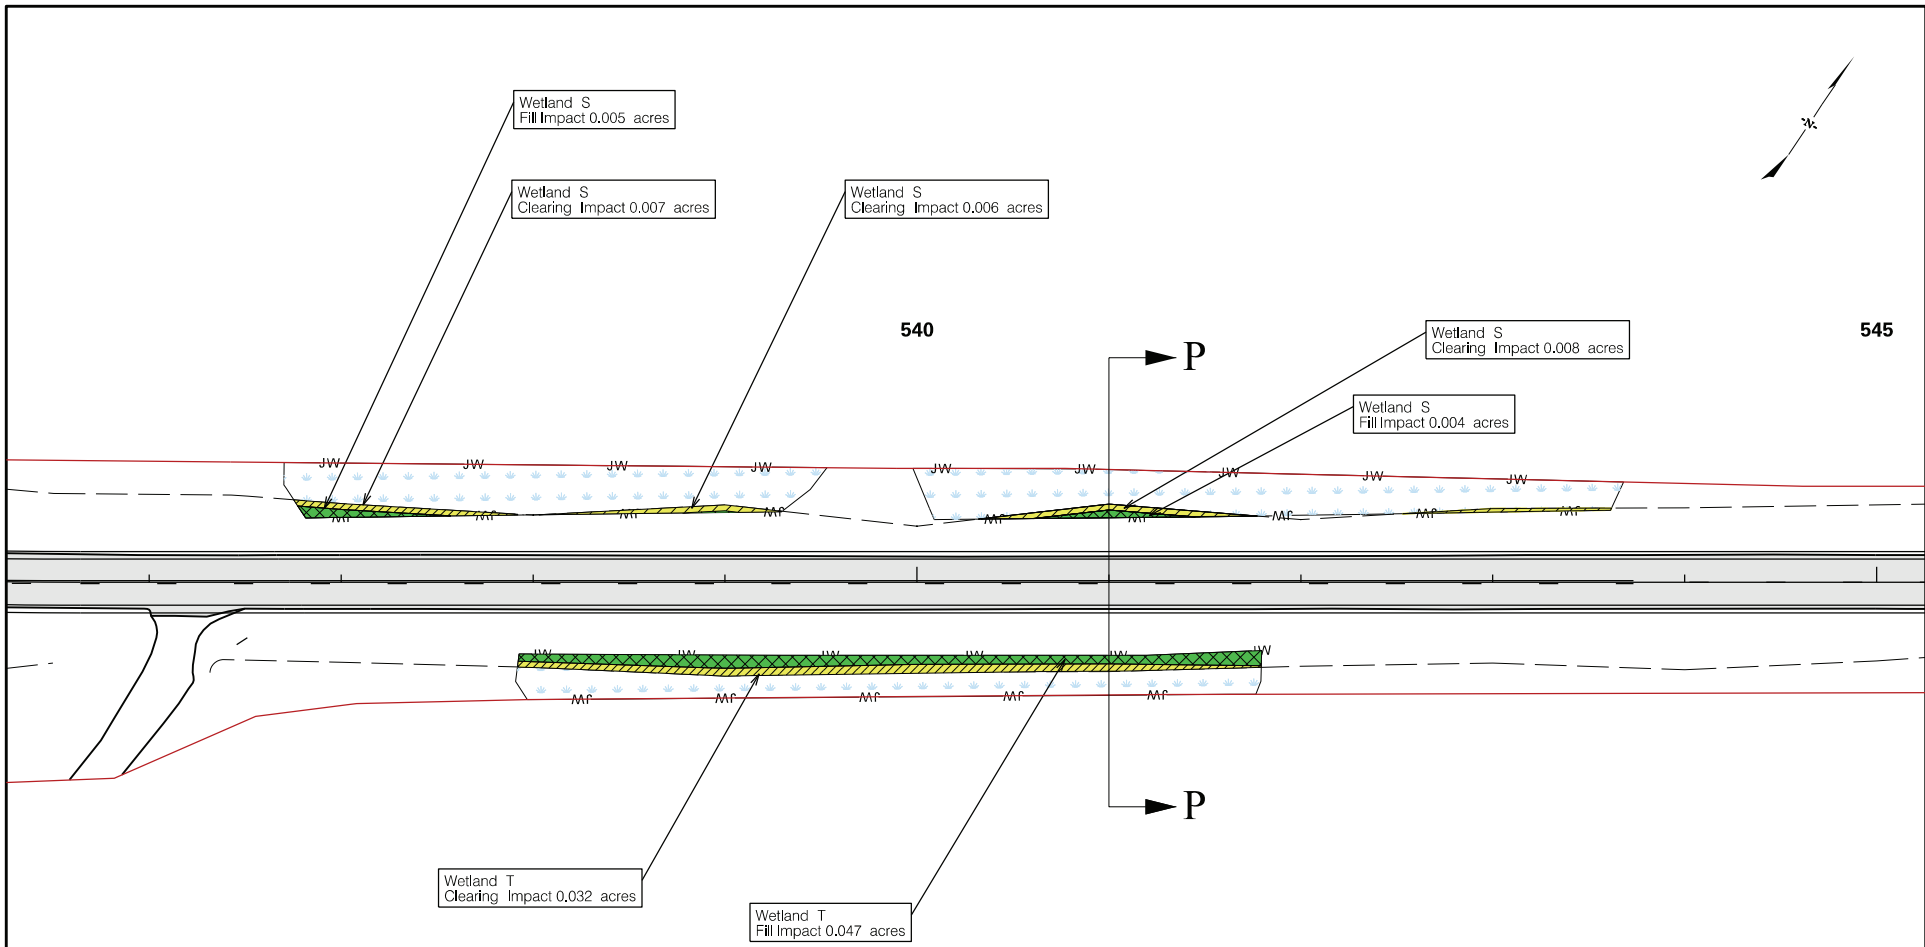






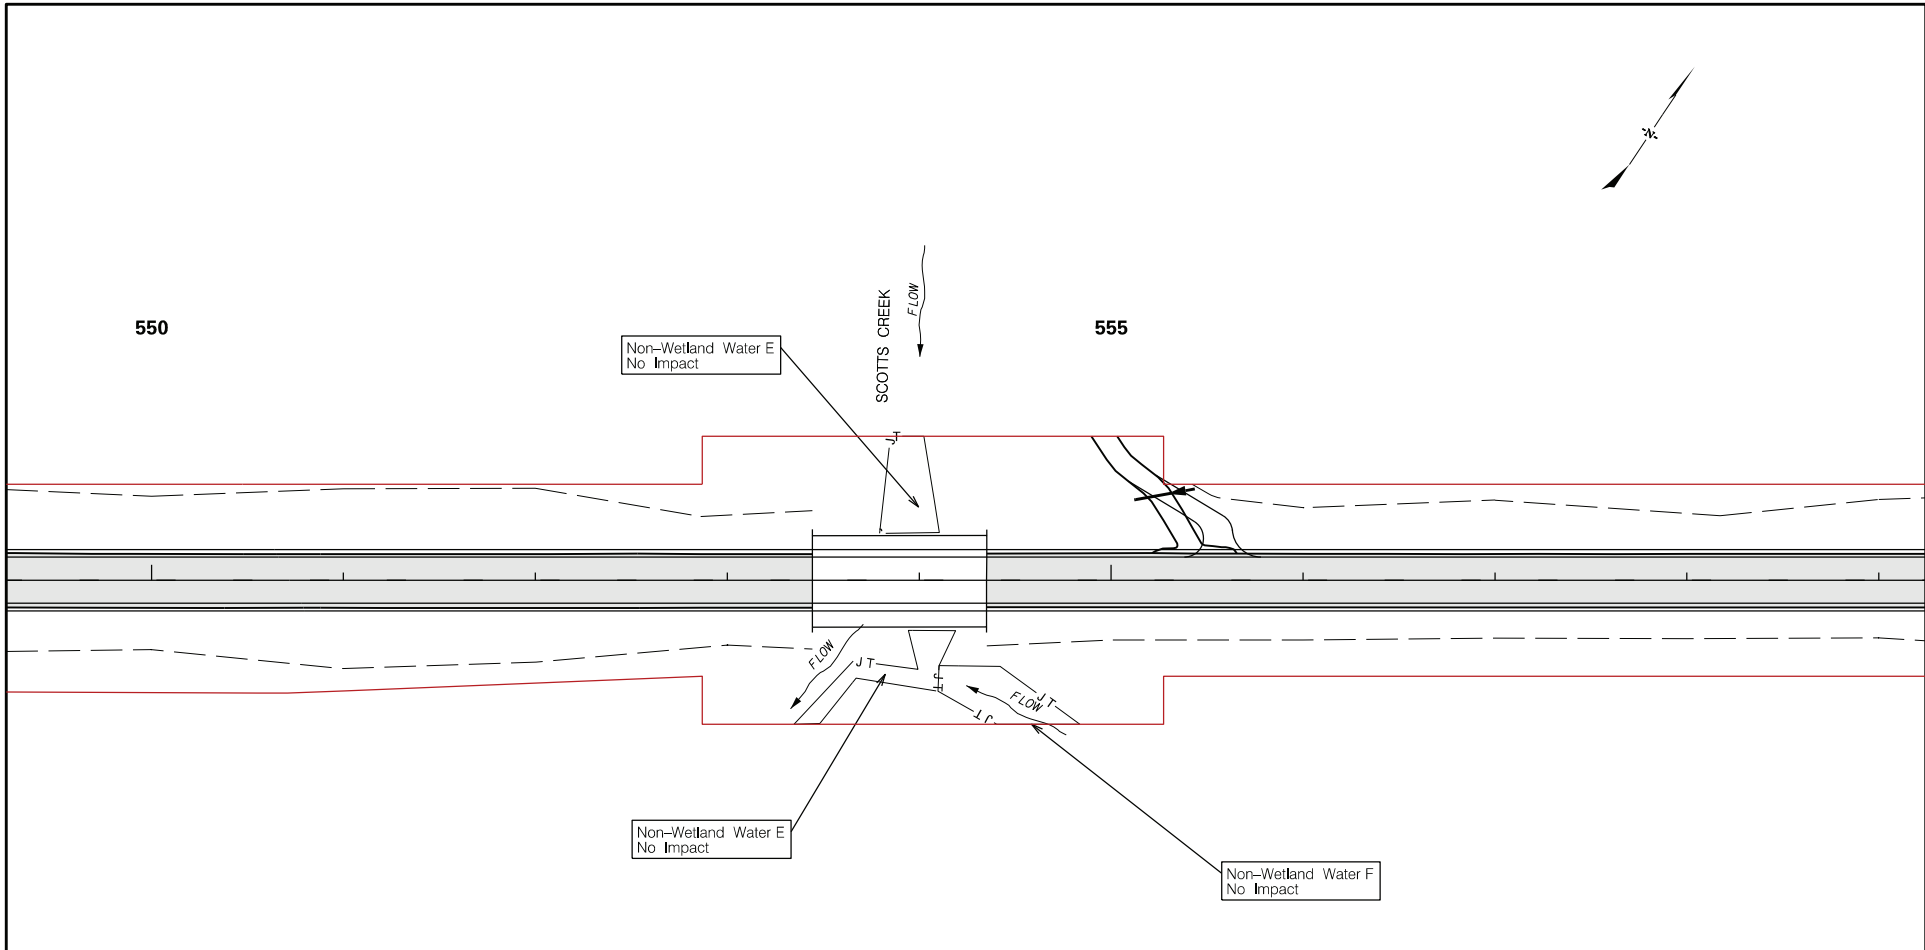





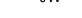

LEGEND	
	= PROJECT STUDY AREA
	= PROPOSED CULVERT
	= PROPOSED PIPE
	= LIMITS OF CONSTRUCTION
	= WETLAND
	= NON-WETLAND WATER
	= NON-WETLAND WATER POND
	= RIP-RAP
	= WETLAND FILL IMPACT
	= EXISTING ROADWAY
	= WETLAND CLEARING IMPACT
	= NON-WETLAND WATER IMPACT

APPLICANT	SHEET TOTALS	SHEET TITLE	PROJECT TITLE
 South Carolina Department of Transportation	<b>Sheet Totals:</b> <b>Wetland Fill:</b> 0.056 acres <b>Wetland Clearing:</b> 0.053 acres	<b>USACE IMPACT PLAN VIEW</b>	<b>DORCHESTER COUNTY            PROJECT P062321            PROPOSED ROAD US 17A            TRAFFIC SAFETY PROJECT</b>
		<b>SCALE: 1" = 100'</b>	



**LEGEND**

-  = PROJECT STUDY AREA
-  = PROPOSED CULVERT
-  = PROPOSED PIPE
-  = LIMITS OF CONSTRUCTION
-  = WETLAND
-  = NON-WETLAND WATER
-  = NON-WETLAND WATER POND
-  = RIP-RAP
-  = WETLAND FILL IMPACT
-  = EXISTING ROADWAY
-  = WETLAND CLEARING IMPACT
-  = NON-WETLAND WATER IMPACT

APPLICANT		SHEET TITLE	PROJECT TITLE
 <small>South Carolina Department of Transportation</small>		<b>USACE IMPACT PLAN VIEW</b>	<b>DORCHESTER COUNTY PROJECT P062321 PROPOSED ROAD US 17A TRAFFIC SAFETY PROJECT</b>
		<b>SCALE: 1" = 100'</b>	<b>SHEET No. 33 OF 67</b>




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565

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





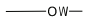


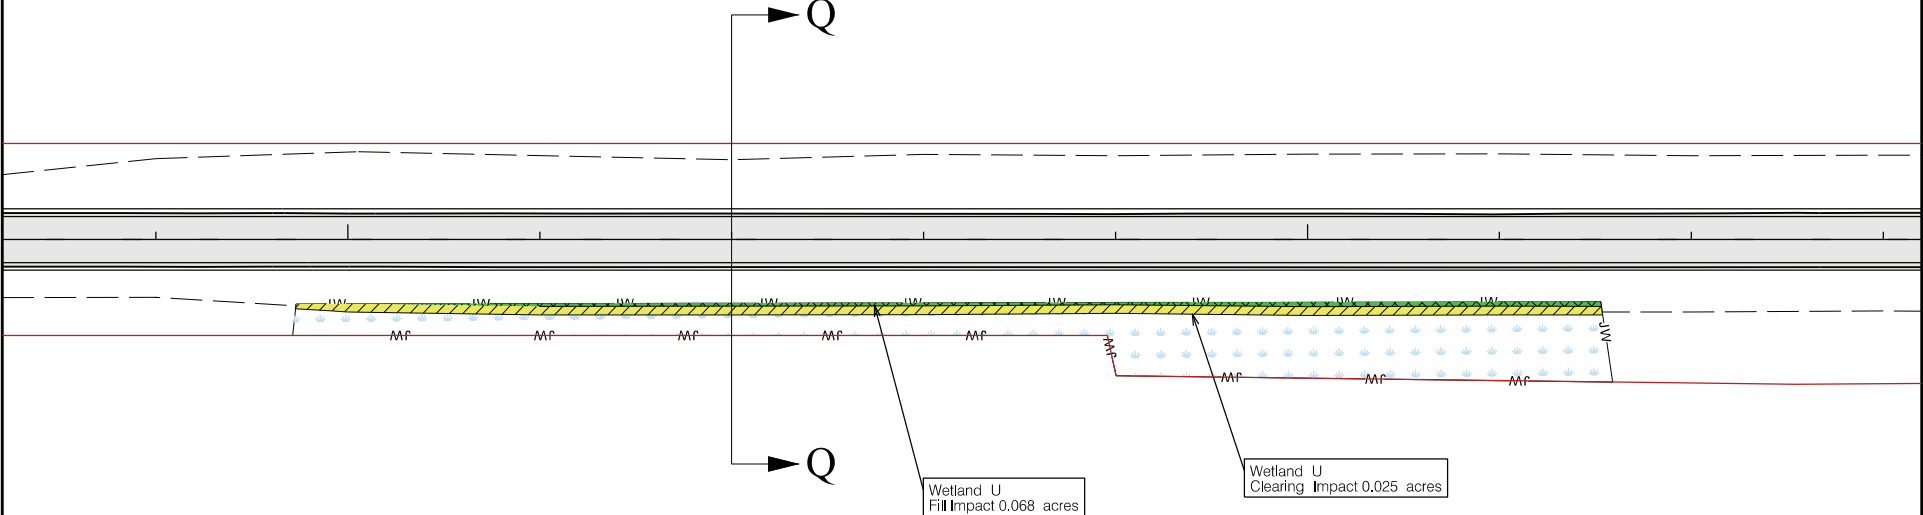


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


Wetland U  
Fill Impact 0.068 acres

Wetland J  
Clearing Impact 0.025 acres

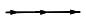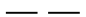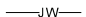
**LEGEND**

-  = PROJECT STUDY AREA
-  = PROPOSED CULVERT
-  = PROPOSED PIPE
-  = LIMITS OF CONSTRUCTION
-  = WETLAND
-  = NON-WETLAND WATER
-  = NON-WETLAND WATER POND
-  = RIP-RAP
-  = WETLAND FILL IMPACT
-  = EXISTING ROADWAY
-  = WETLAND CLEARING IMPACT
-  = NON-WETLAND WATER IMPACT

APPLICANT		SHEET TITLE	PROJECT TITLE
 South Carolina Department of Transportation	Sheet Totals: Wetland Fill: 0.068 acres Wetland Clearing: 0.025 acres	<b>USACE IMPACT PLAN VIEW</b>  SCALE: 1" = 100'	<b>DORCHESTER COUNTY PROJECT P062321 PROPOSED ROAD US 17A TRAFFIC SAFETY PROJECT</b>
<b>SHEET No. 34 OF 67</b>			

575

580

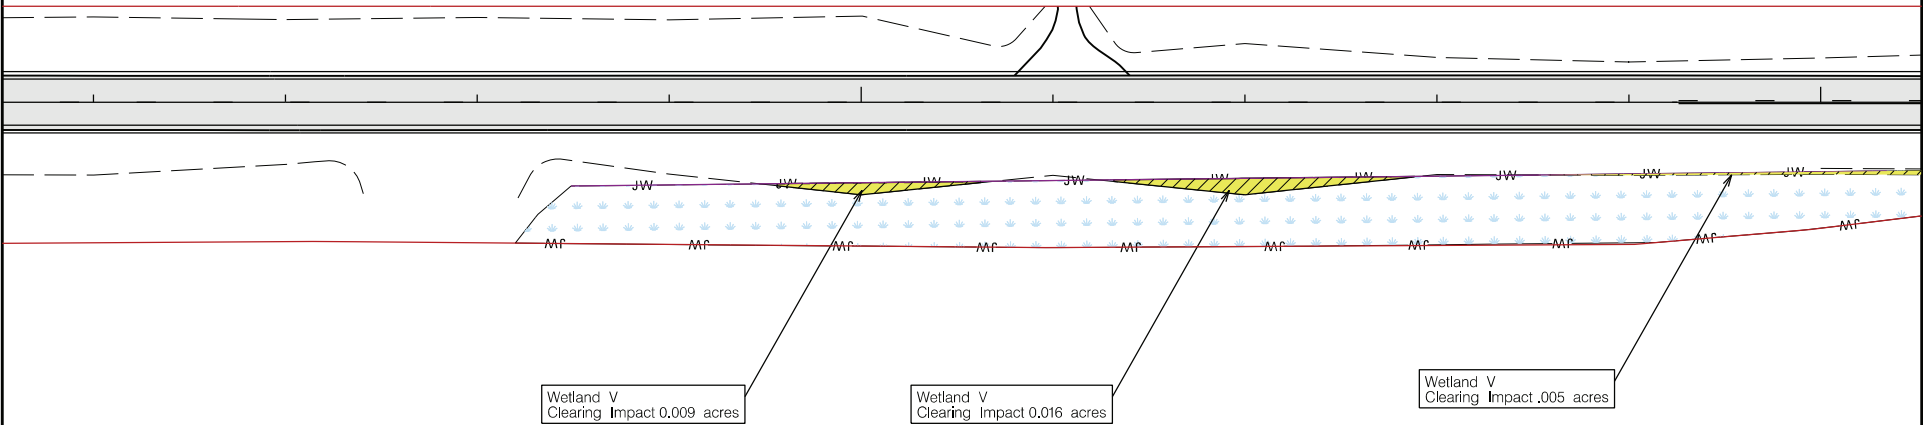




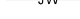









Wetland V  
Clearing Impact 0.009 acres

Wetland V  
Clearing Impact 0.016 acres

Wetland V  
Clearing Impact .005 acres

**LEGEND**

-  = PROJECT STUDY AREA
-  = PROPOSED CULVERT
-  = PROPOSED PIPE
-  = LIMITS OF CONSTRUCTION
-  = WETLAND
-  = NON-WETLAND WATER
-  = NON-WETLAND WATER POND
-  = RIP-RAP
-  = WETLAND FILL IMPACT
-  = EXISTING ROADWAY
-  = WETLAND CLEARING IMPACT
-  = NON-WETLAND WATER IMPACT

APPLICANT	SHEET TITLE	PROJECT TITLE
 <small>South Carolina Department of Transportation</small>	<b>USACE IMPACT PLAN VIEW</b>  <b>SCALE: 1" = 100'</b>	<b>DORCHESTER COUNTY PROJECT P062321 PROPOSED ROAD US 17A TRAFFIC SAFETY PROJECT</b>
<b>Sheet Totals:</b> Wetland Clearing:                      0.030 acres		<b>SHEET No. 35 OF 67</b>



580

585

R

R

Wetland V  
Fill Impact 0.063 acres


Wetland V  
Clearing Impact 0.041 acres

**LEGEND**








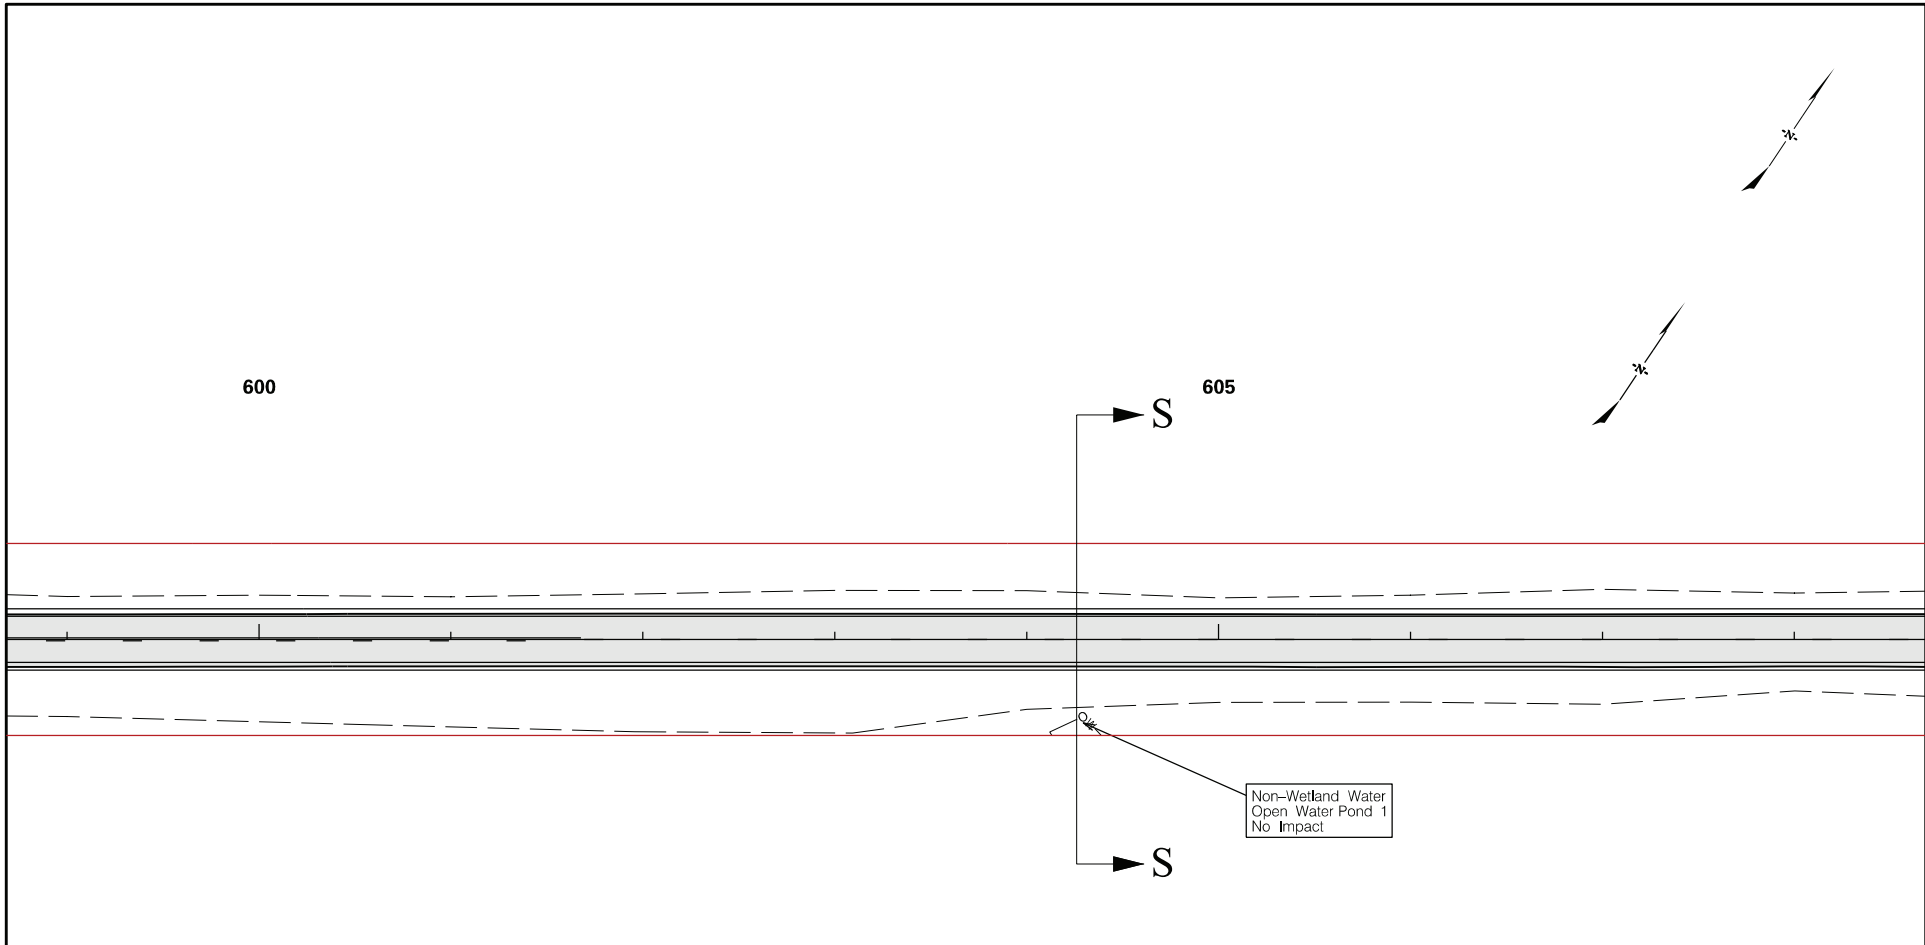




- = PROJECT STUDY AREA
- = PROPOSED CULVERT
- = PROPOSED PIPE
- = LIMITS OF CONSTRUCTION
- JW = WETLAND
- JT = NON-WETLAND WATER
- OW = NON-WETLAND WATER POND
- = RIP-RAP
- = WETLAND FILL IMPACT
- = EXISTING ROADWAY
- = WETLAND CLEARING IMPACT
- = NON-WETLAND WATER IMPACT


APPLICANT	SHEET TITLE	PROJECT TITLE
 South Carolina Department of Transportation	<b>USACE IMPACT PLAN VIEW</b>  <b>SCALE: 1" = 100'</b>	<b>DORCHESTER COUNTY PROJECT P062321 PROPOSED ROAD US 17A TRAFFIC SAFETY PROJECT</b>
<b>Sheet Totals:</b> Wetland Fill: 0.063 acres Wetland Clearing: 0.041 acres		<b>SHEET No. 36 OF 67</b>

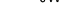




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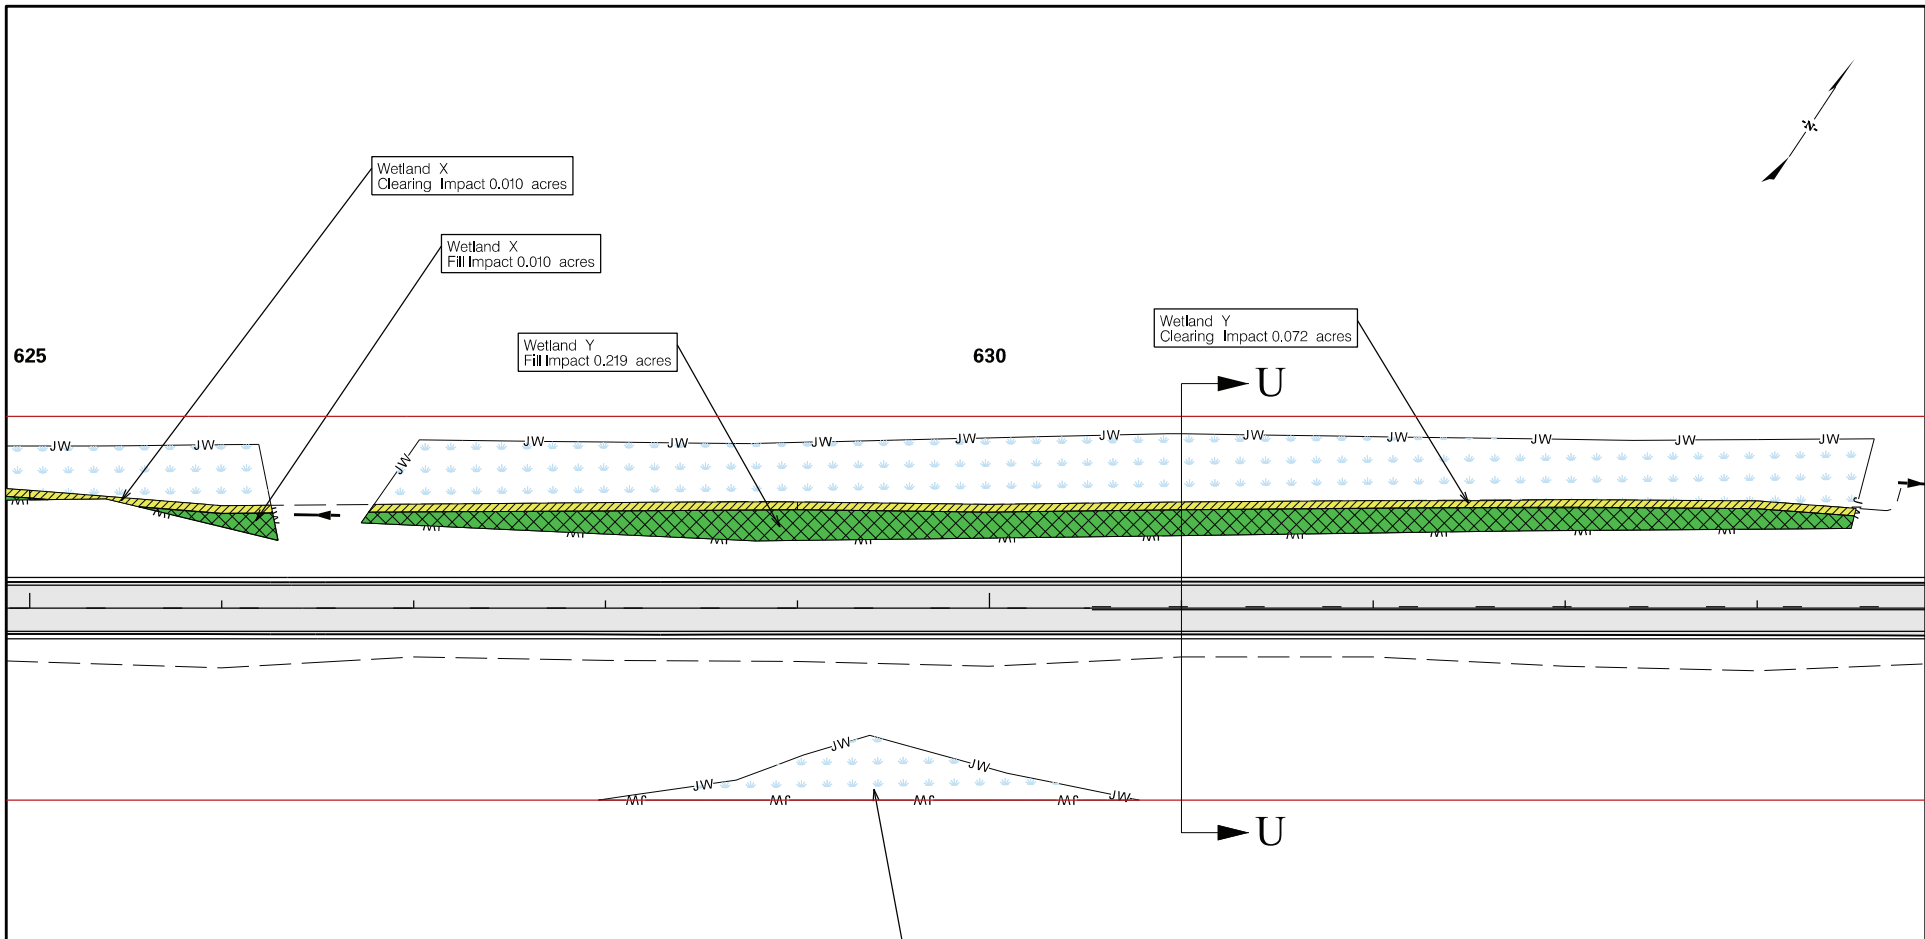
-  = PROJECT STUDY AREA
-  = PROPOSED CULVERT
-  = PROPOSED PIPE
-  = LIMITS OF CONSTRUCTION
-  = WETLAND
-  = NON-WETLAND WATER
-  = NON-WETLAND WATER POND
-  = RIP-RAP
-  = WETLAND FILL IMPACT
-  = EXISTING ROADWAY
-  = WETLAND CLEARING IMPACT
-  = NON-WETLAND WATER IMPACT

APPLICANT		SHEET TITLE	PROJECT TITLE
 <small>South Carolina Department of Transportation</small>		<b>USACE IMPACT PLAN VIEW</b>	<b>DORCHESTER COUNTY PROJECT P062321 PROPOSED ROAD US 17A TRAFFIC SAFETY PROJECT</b>
		<b>SCALE: 1" = 100'</b>	<b>SHEET No. 37 OF 67</b>

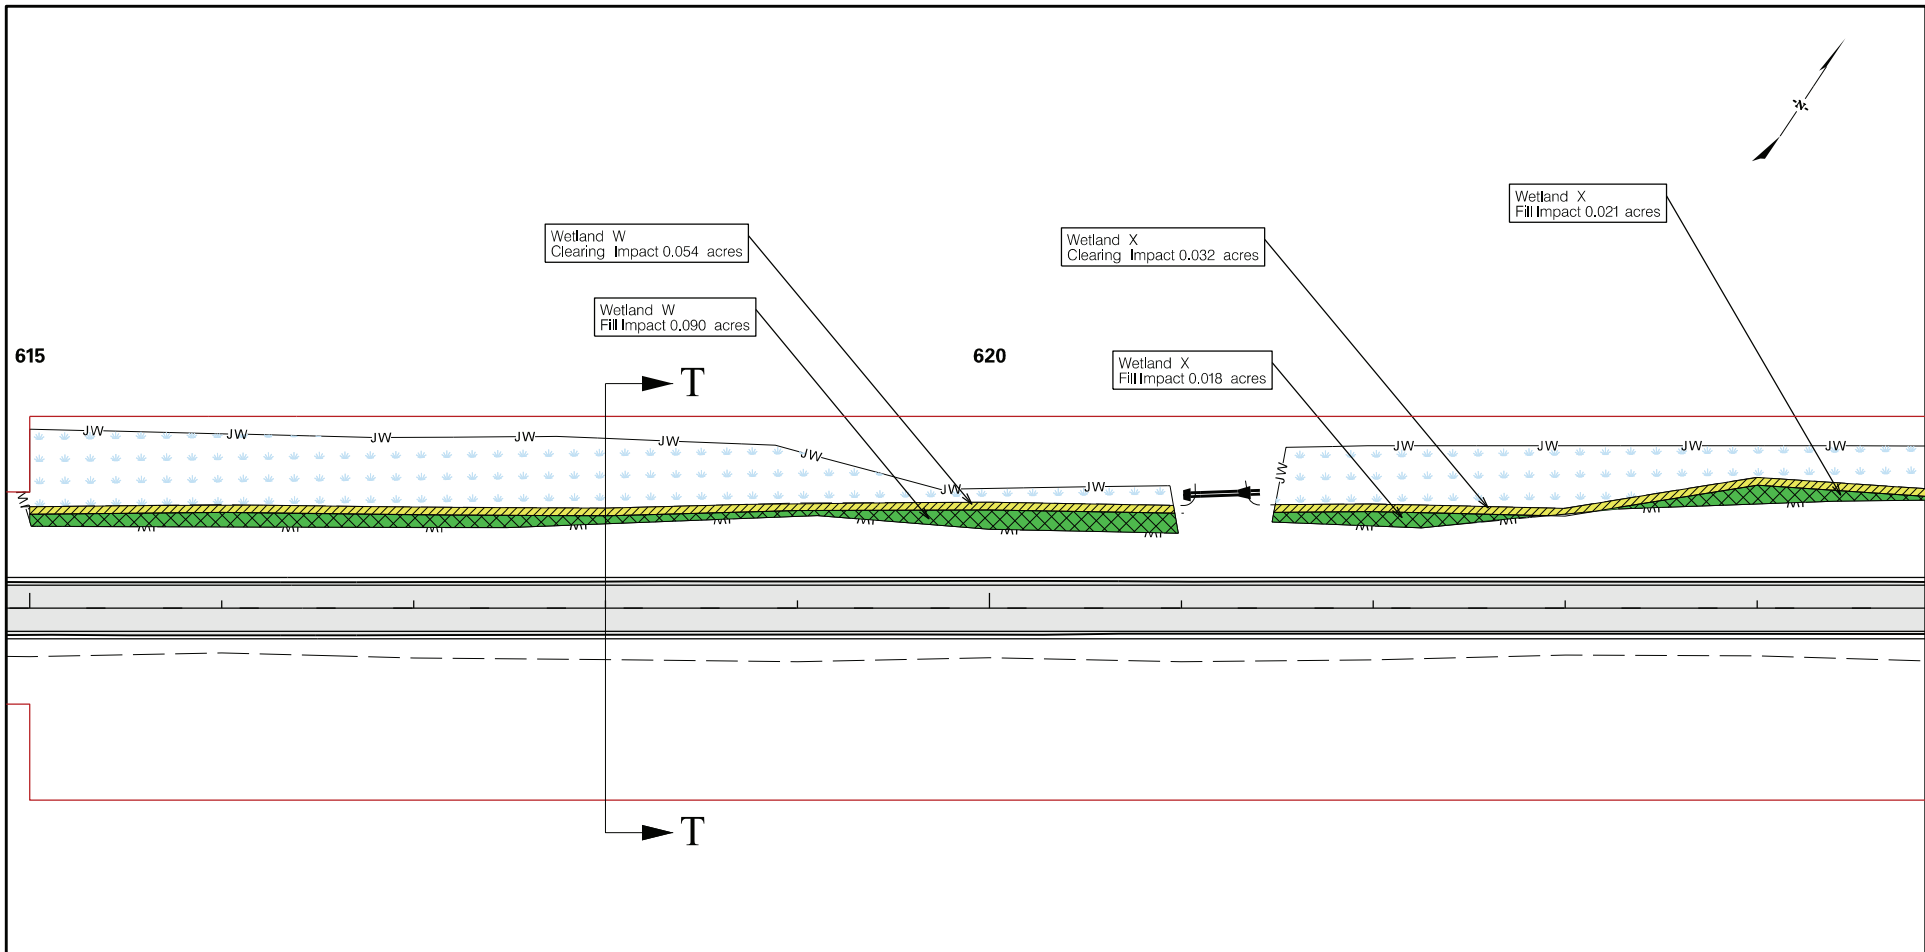


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	= PROPOSED CULVERT
	= PROPOSED PIPE
	= LIMITS OF CONSTRUCTION
	= WETLAND
	= NON-WETLAND WATER
	= NON-WETLAND WATER POND
	= RIP-RAP
	= WETLAND FILL IMPACT
	= EXISTING ROADWAY
	= WETLAND CLEARING IMPACT
	= NON-WETLAND WATER IMPACT

APPLICANT		SHEET TITLE	PROJECT TITLE
 South Carolina Department of Transportation	<b>Sheet Totals:</b> Wetland Fill: 0.129 acres Wetland Clearing: 0.086 acres	USACE IMPACT PLAN VIEW	DORCHESTER COUNTY PROJECT P062321 PROPOSED ROAD US 17A TRAFFIC SAFETY PROJECT
		SCALE: 1" = 100'	
			SHEET No. 38 OF 67



LEGEND	
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	= PROPOSED CULVERT
	= PROPOSED PIPE
	= LIMITS OF CONSTRUCTION
	= WETLAND
	= NON-WETLAND WATER
	= NON-WETLAND WATER POND
	= RIP-RAP
	= WETLAND FILL IMPACT
	= EXISTING ROADWAY
	= WETLAND CLEARING IMPACT
	= NON-WETLAND WATER IMPACT

APPLICANT		SHEET TITLE	PROJECT TITLE
 South Carolina Department of Transportation	<b>Sheet Totals:</b> Wetland Fill: 0.229 acres Wetland Clearing: 0.082 acres	USACE IMPACT PLAN VIEW	DORCHESTER COUNTY PROJECT P062321 PROPOSED ROAD US 17A TRAFFIC SAFETY PROJECT
		SCALE: 1" = 100'	

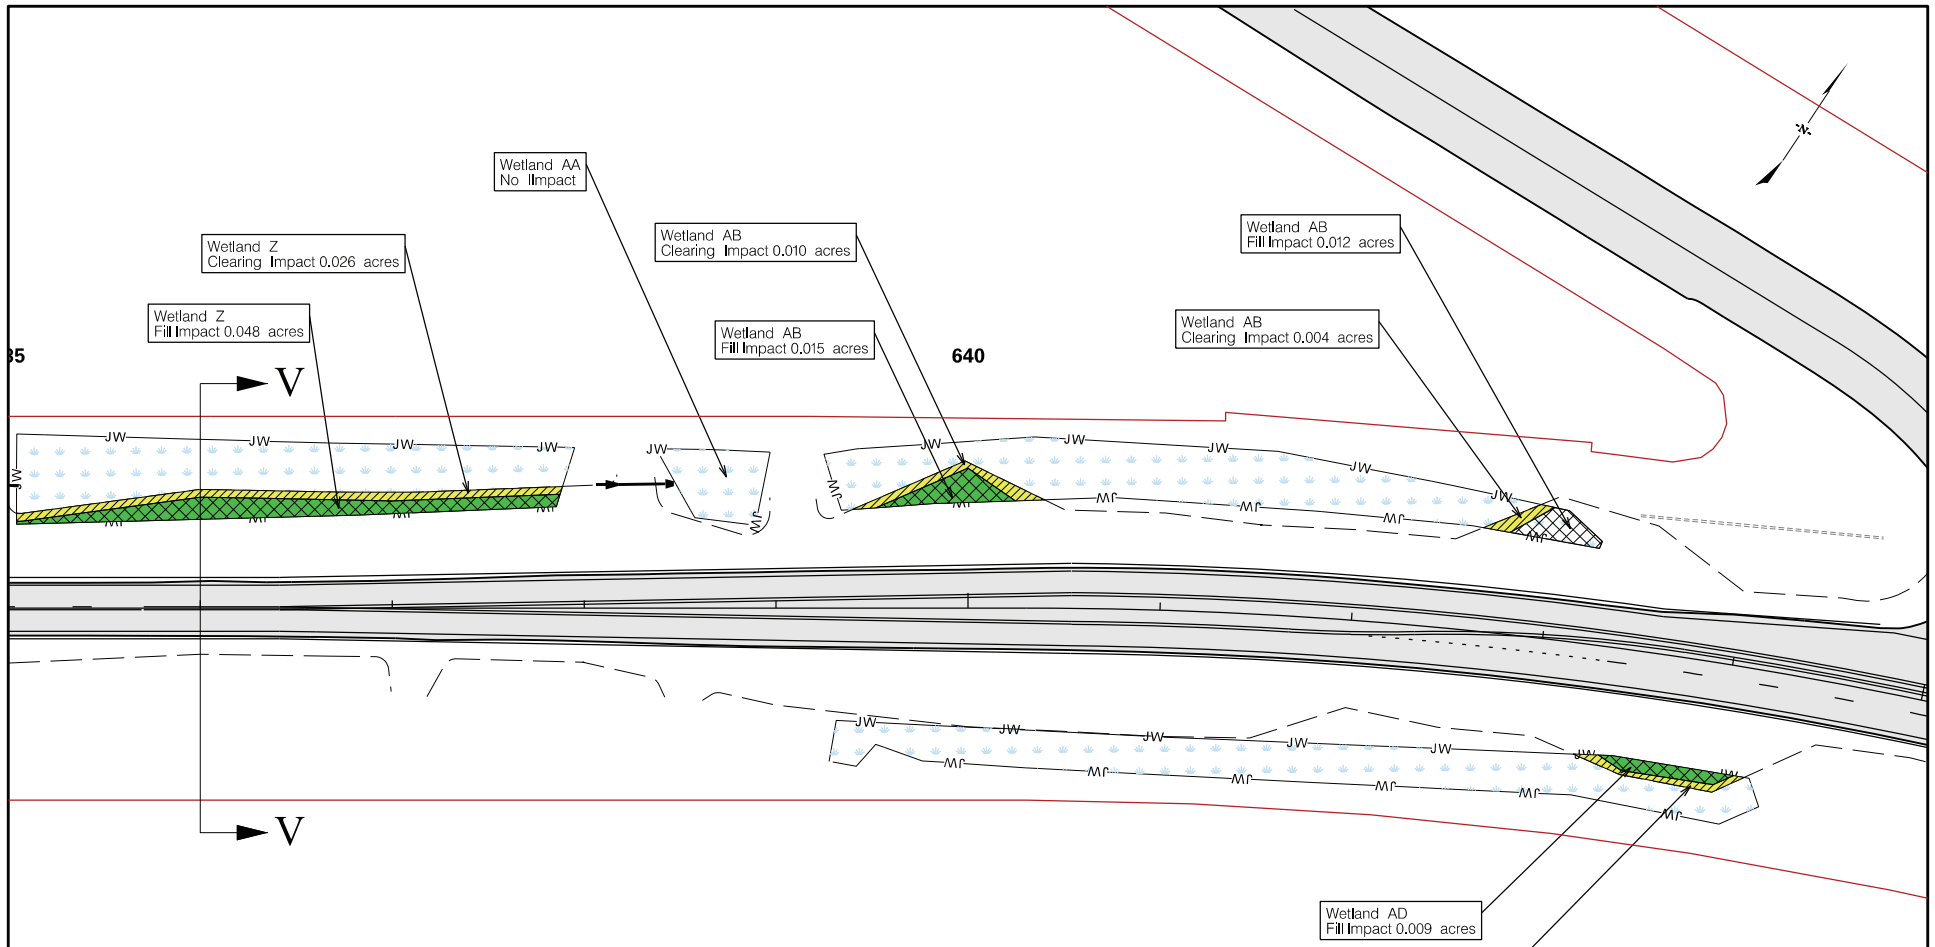

**LEGEND**

- = PROJECT STUDY AREA
- = PROPOSED CULVERT
- = PROPOSED PIPE
- = LIMITS OF PIPE
- = LIMITS OF CONSTRUCTION
- JW = WETLAND
- JT = NON-WETLAND WATER
- OW = NON-WETLAND WATER POND
- = RIP-RAP
- = WETLAND FILL IMPACT
- = EXISTING ROADWAY
- = WETLAND CLEARING IMPACT
- = NON-WETLAND WATER IMPACT

**APPLICANT**



South Carolina Department of Transportation

**Sheet Totals:**

Wetland Fill: 0.084 acres

Wetland Clearing: 0.046 acres


**SHEET TITLE**

**USACE IMPACT  
PLAN VIEW**

**SCALE: 1" = 100'**

**PROJECT TITLE**

**DORCHESTER COUNTY  
PROJECT P062321  
PROPOSED ROAD US 17A  
TRAFFIC SAFETY PROJECT**

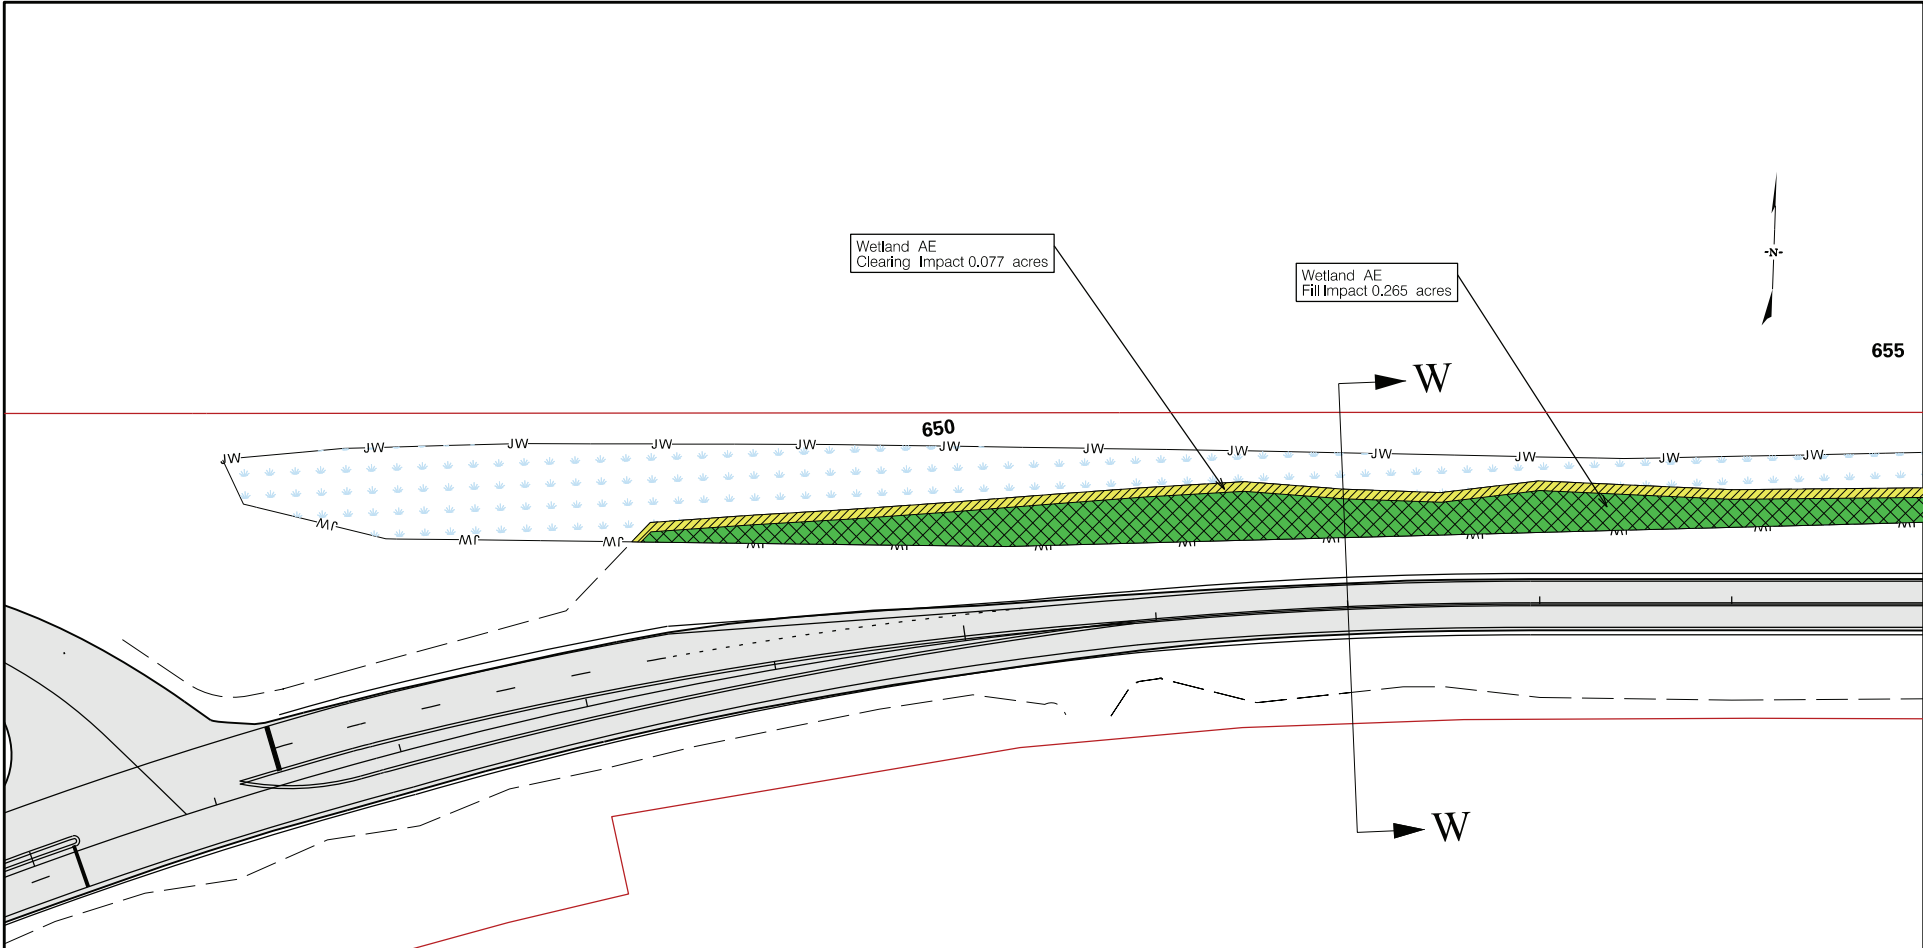

**LEGEND**

- = PROJECT STUDY AREA
- = PROPOSED CULVERT
- = PROPOSED PIPE
- = LIMITS OF CONSTRUCTION
- JW = WETLAND
- JT = NON-WETLAND WATER
- OW = NON-WETLAND WATER POND
- = RIP-RAP
- = WETLAND FILL IMPACT
- = EXISTING ROADWAY
- = WETLAND CLEARING IMPACT
- = NON-WETLAND WATER IMPACT

**APPLICANT**



South Carolina Department of Transportation

Sheet Totals:  
 Wetland Fill: 0.265 acres  
 Wetland Clearing: 0.077 acres


**SHEET TITLE**

**USACE IMPACT  
PLAN VIEW**






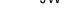

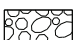


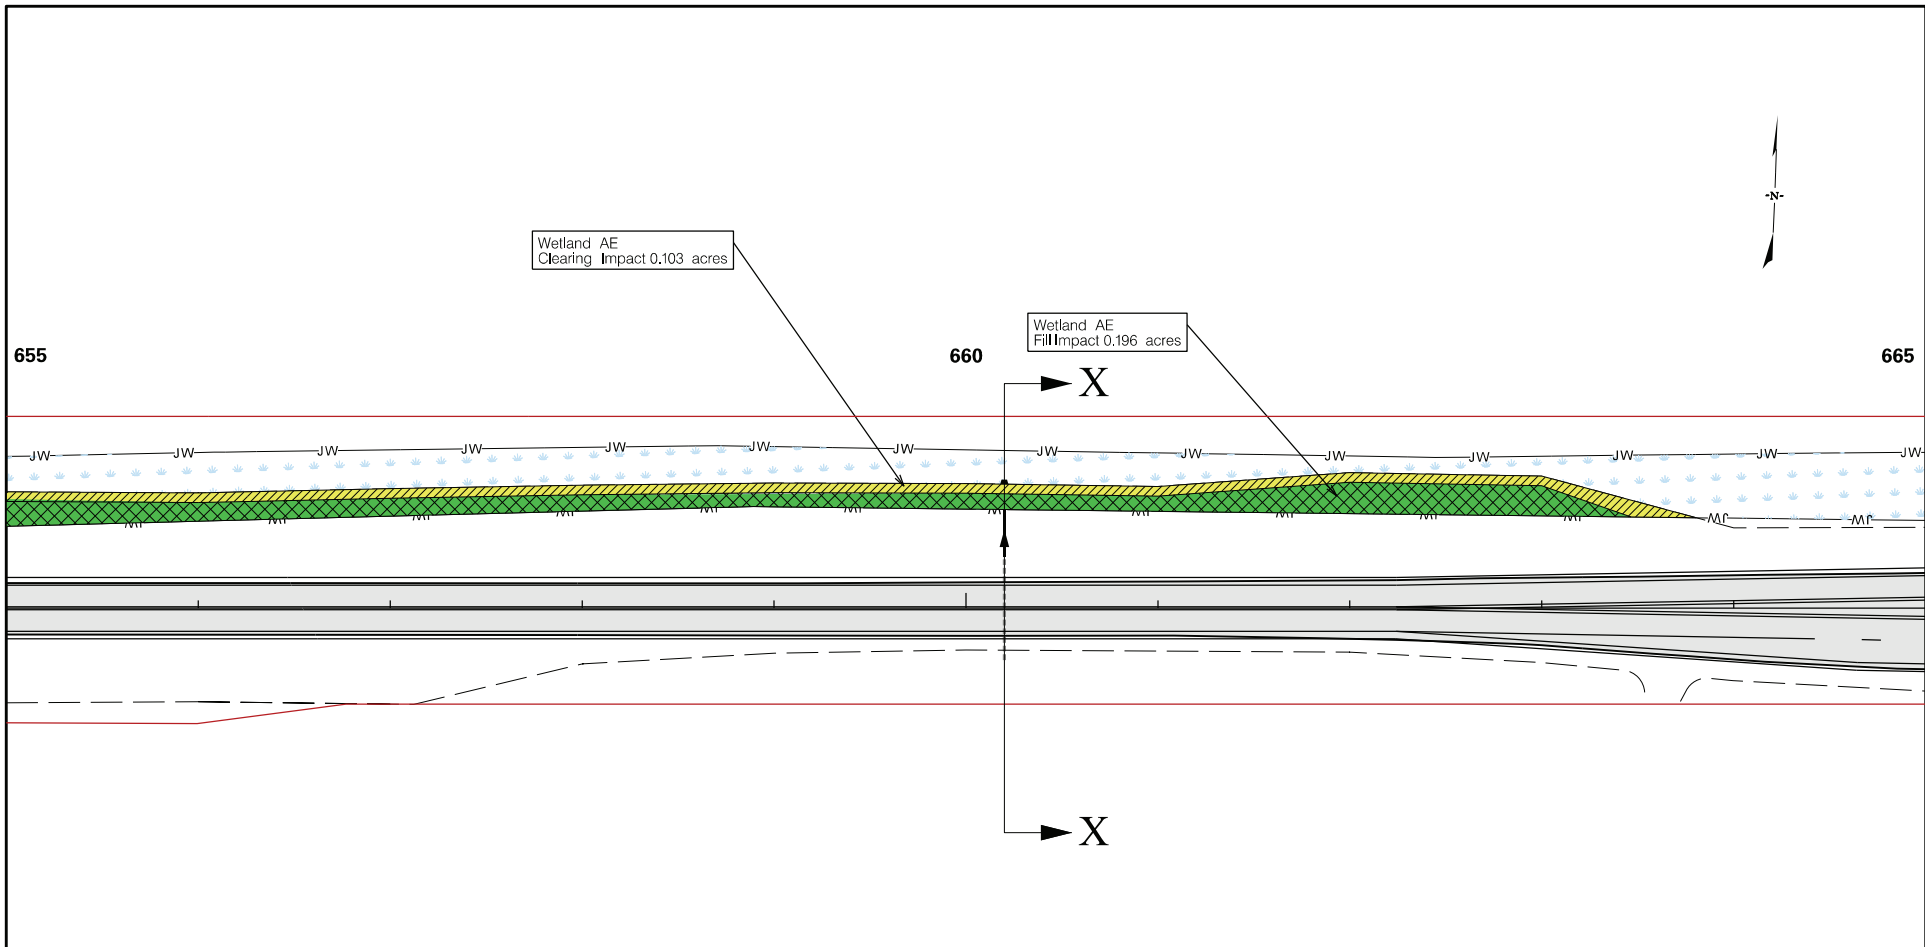

**SCALE: 1" = 100'**


**PROJECT TITLE**


**DORCHESTER COUNTY  
PROJECT P062321  
PROPOSED ROAD US 17A  
TRAFFIC SAFETY PROJECT**



**LEGEND**

-  = PROJECT STUDY AREA
-  = PROPOSED CULVERT
-  = PROPOSED PIPE
-  = LIMITS OF CONSTRUCTION
-  = WETLAND
-  = NON-WETLAND WATER
-  = NON-WETLAND WATER POND
-  = RIP-RAP
-  = WETLAND FILL IMPACT
-  = EXISTING ROADWAY
-  = WETLAND CLEARING IMPACT
-  = NON-WETLAND WATER IMPACT

APPLICANT		SHEET TITLE	PROJECT TITLE
 South Carolina Department of Transportation	Sheet Totals: Wetland Fill: 0.196 acres Wetland Clearing: 0.103 acres	<b>USACE IMPACT PLAN VIEW</b>  SCALE: 1" = 100'	<b>DORCHESTER COUNTY PROJECT P062321 PROPOSED ROAD US 17A TRAFFIC SAFETY PROJECT</b>
			<b>SHEET No. 42 OF 67</b>

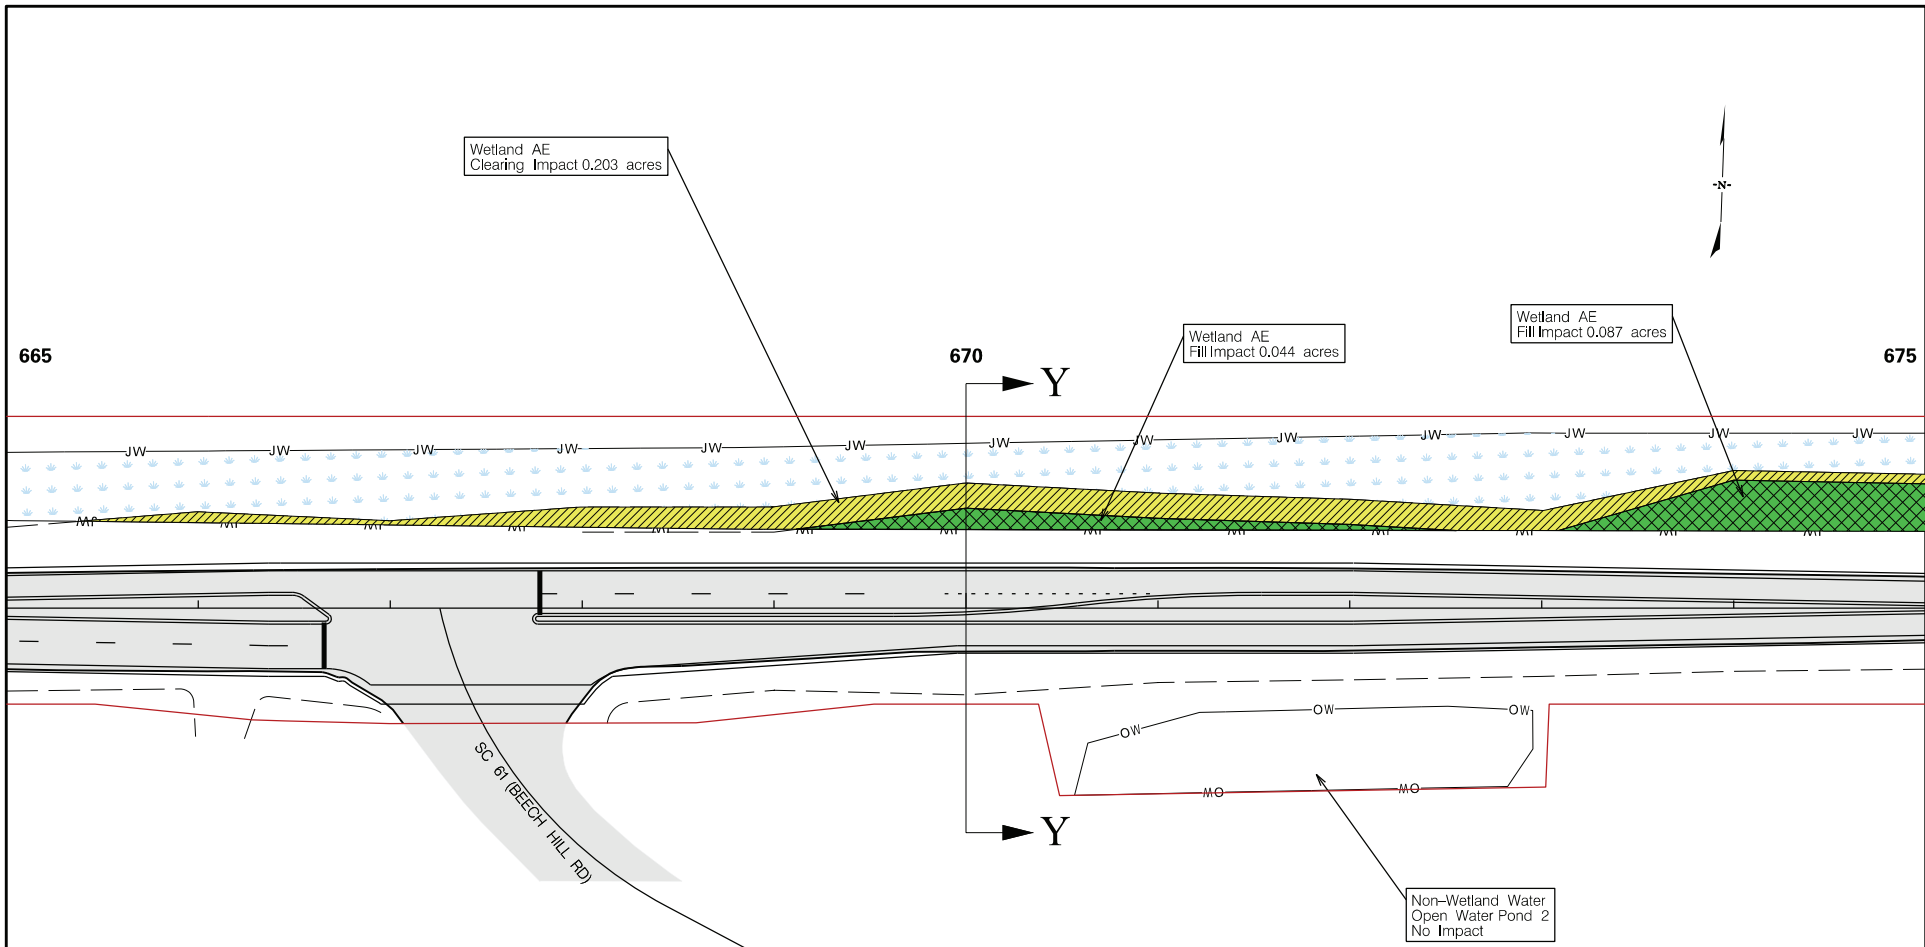


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	= PROPOSED CULVERT
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	= LIMITS OF CONSTRUCTION
	= WETLAND
	= NON-WETLAND WATER
	= NON-WETLAND WATER POND
	= RIP-RAP
	= WETLAND FILL IMPACT
	= EXISTING ROADWAY
	= WETLAND CLEARING IMPACT
	= NON-WETLAND WATER IMPACT

APPLICANT
 South Carolina Department of Transportation

<b>Sheet Totals:</b> Wetland Fill: 0.131 acres Wetland Clearing: 0.203 acres
--

SHEET TITLE
USACE IMPACT PLAN VIEW
SCALE: 1" = 100'

PROJECT TITLE
DORCHESTER COUNTY PROJECT P062321 PROPOSED ROAD US 17A TRAFFIC SAFETY PROJECT
SHEET No. 43 OF 67

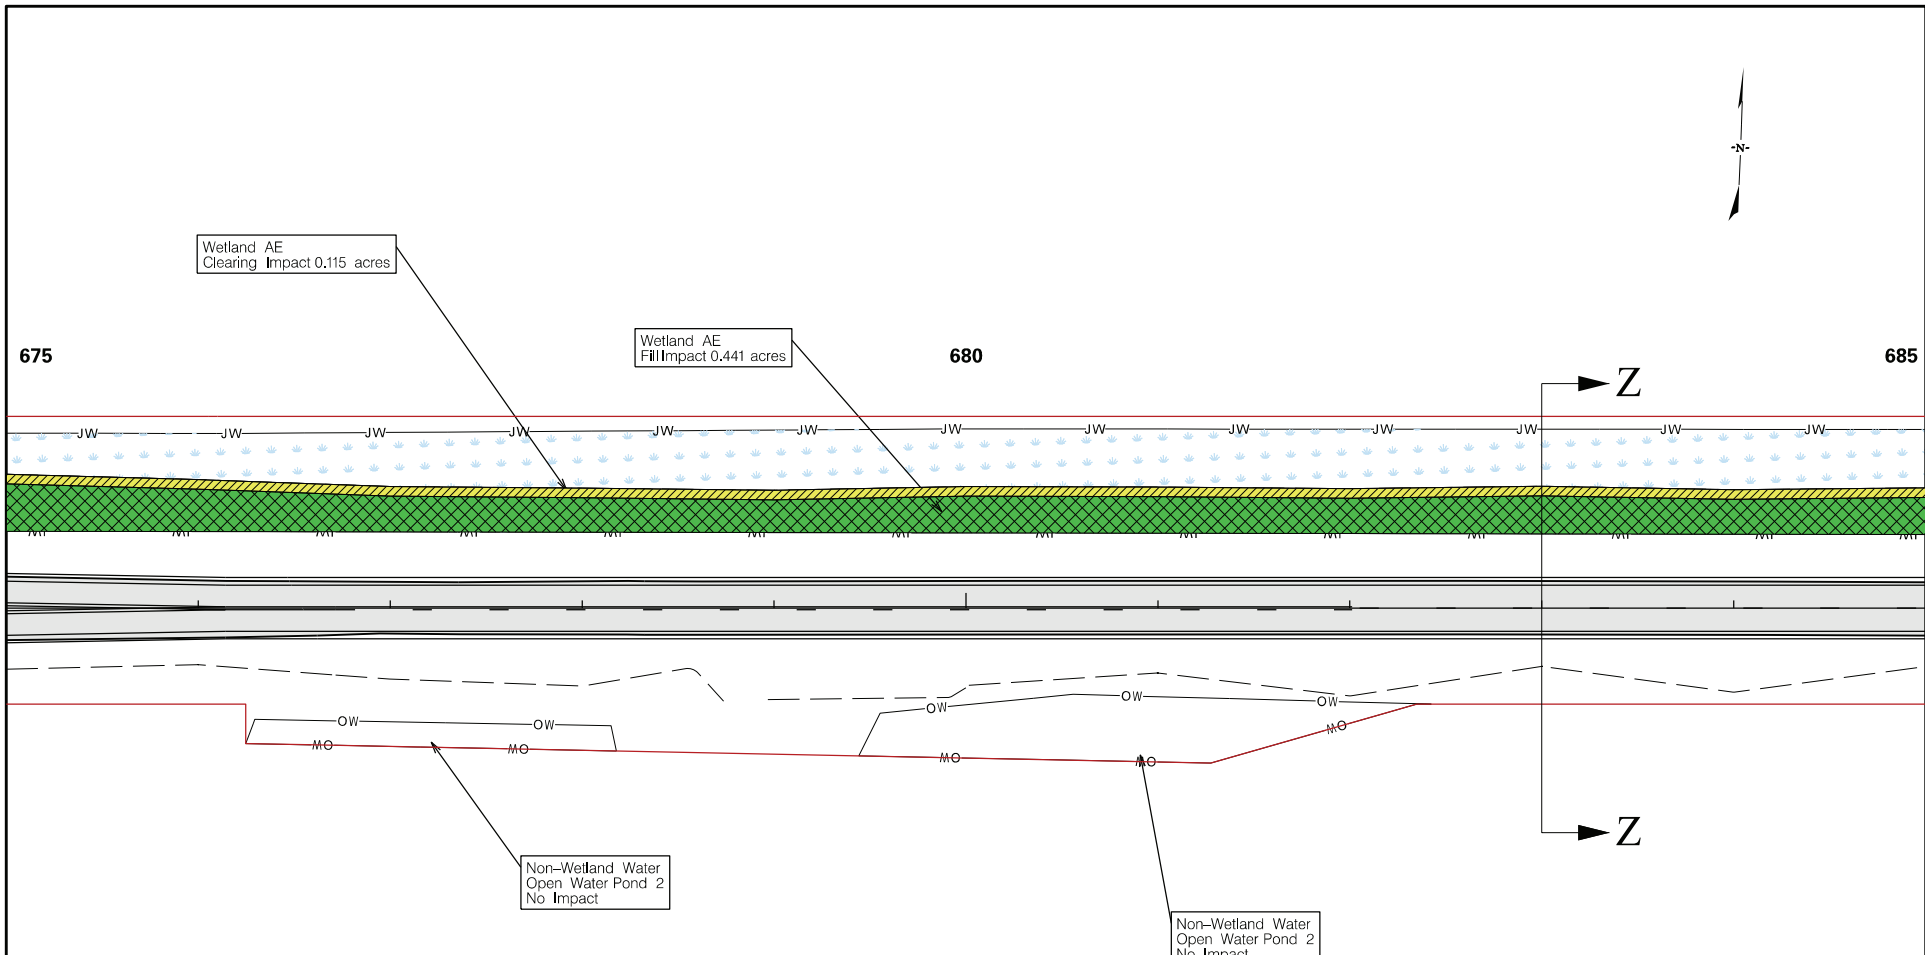

**LEGEND**

- = PROJECT STUDY AREA
- = PROPOSED CULVERT
- = PROPOSED PIPE
- = LIMITS OF CONSTRUCTION
- JW = WETLAND
- JT = NON-WETLAND WATER
- OW = NON-WETLAND WATER POND
- = RIP-RAP
- = WETLAND FILL IMPACT
- = EXISTING ROADWAY
- = WETLAND CLEARING IMPACT
- = NON-WETLAND WATER IMPACT


<b>APPLICANT</b>
<p>South Carolina Department of Transportation</p>

Sheet Totals:  
 Wetland Fill: 0.441 acres  
 Wetland Clearing: 0.115 acres








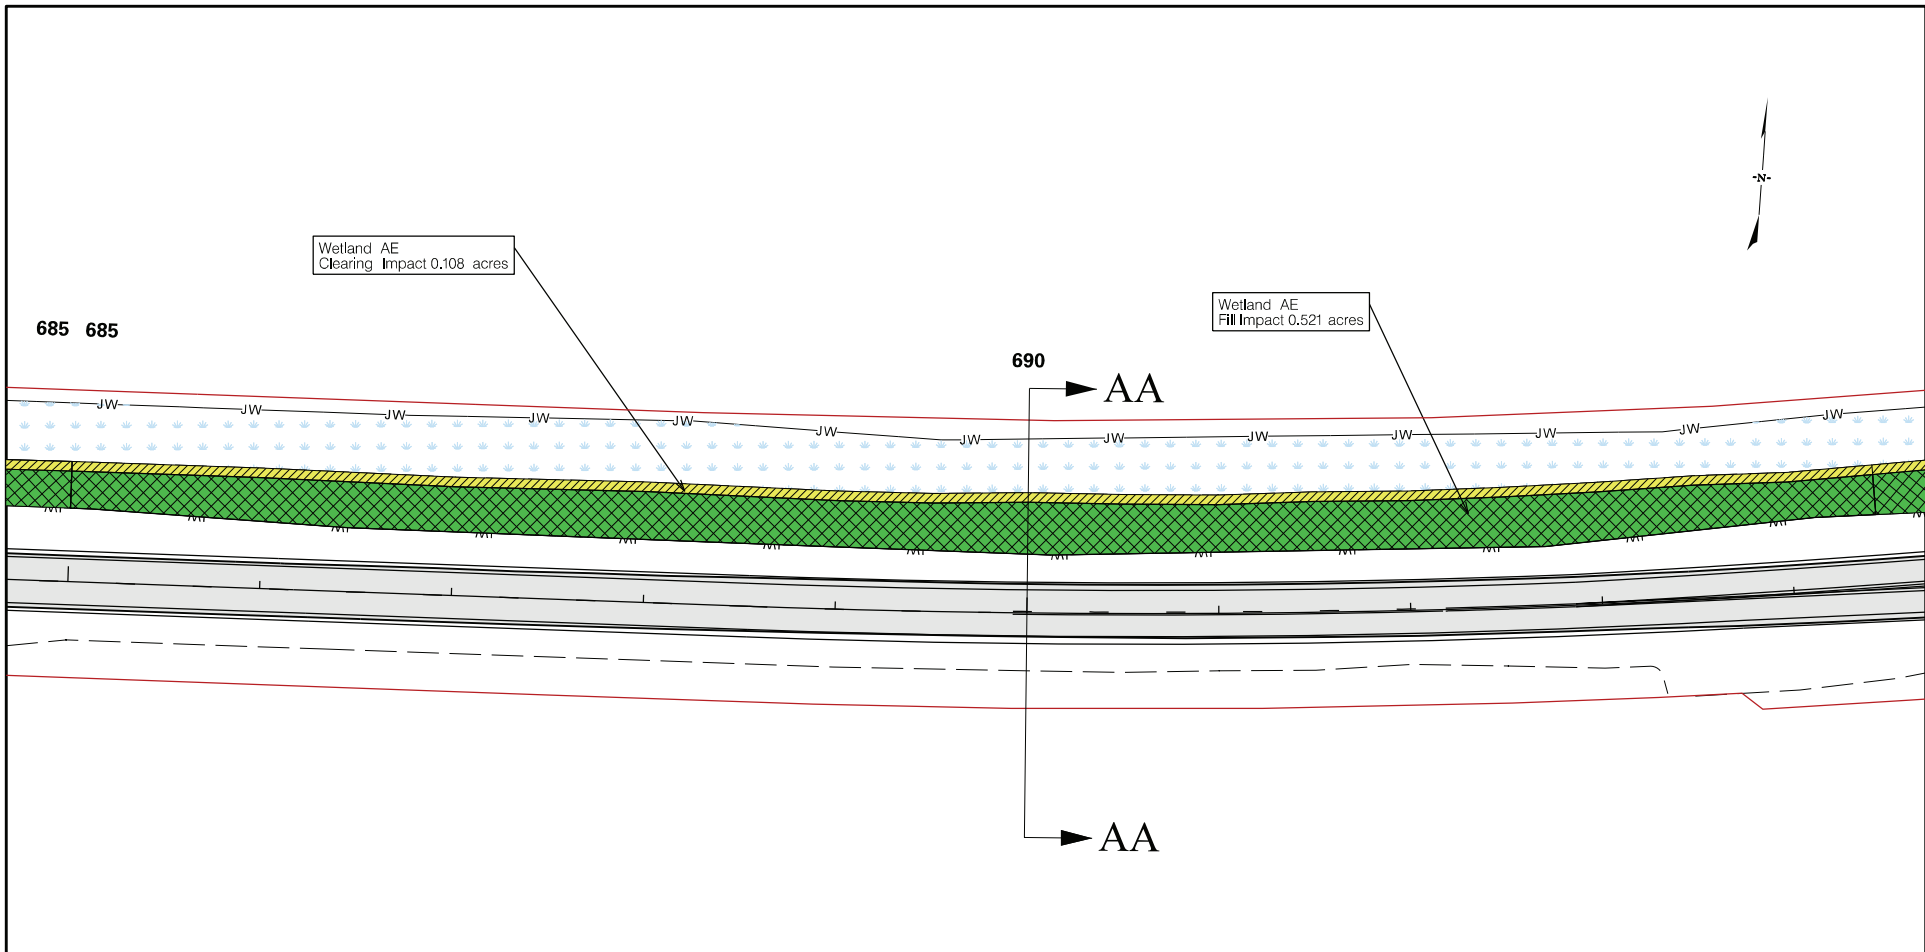




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<b>USACE IMPACT PLAN VIEW</b>
<b>SCALE: 1" = 100'</b>


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<b>DORCHESTER COUNTY          PROJECT P062321          PROPOSED ROAD US 17A          TRAFFIC SAFETY PROJECT</b>
<b>SHEET No. 44 OF 67</b>

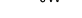




**LEGEND**

-  = PROJECT STUDY AREA
-  = PROPOSED CULVERT
-  = PROPOSED PIPE
-  = LIMITS OF CONSTRUCTION
-  = WETLAND
-  = NON-WETLAND WATER
-  = NON-WETLAND WATER POND
-  = RIP-RAP
-  = WETLAND FILL IMPACT
-  = EXISTING ROADWAY
-  = WETLAND CLEARING IMPACT
-  = NON-WETLAND WATER IMPACT

APPLICANT		SHEET TITLE	PROJECT TITLE
 South Carolina Department of Transportation	Sheet Totals: Wetland Fill: 0.521 acres Wetland Clearing: 0.108 acres	<b>USACE IMPACT PLAN VIEW</b>  SCALE: 1" = 100'	<b>DORCHESTER COUNTY PROJECT P062321 PROPOSED ROAD US 17A TRAFFIC SAFETY PROJECT</b>
			SHEET No. 45 OF 67

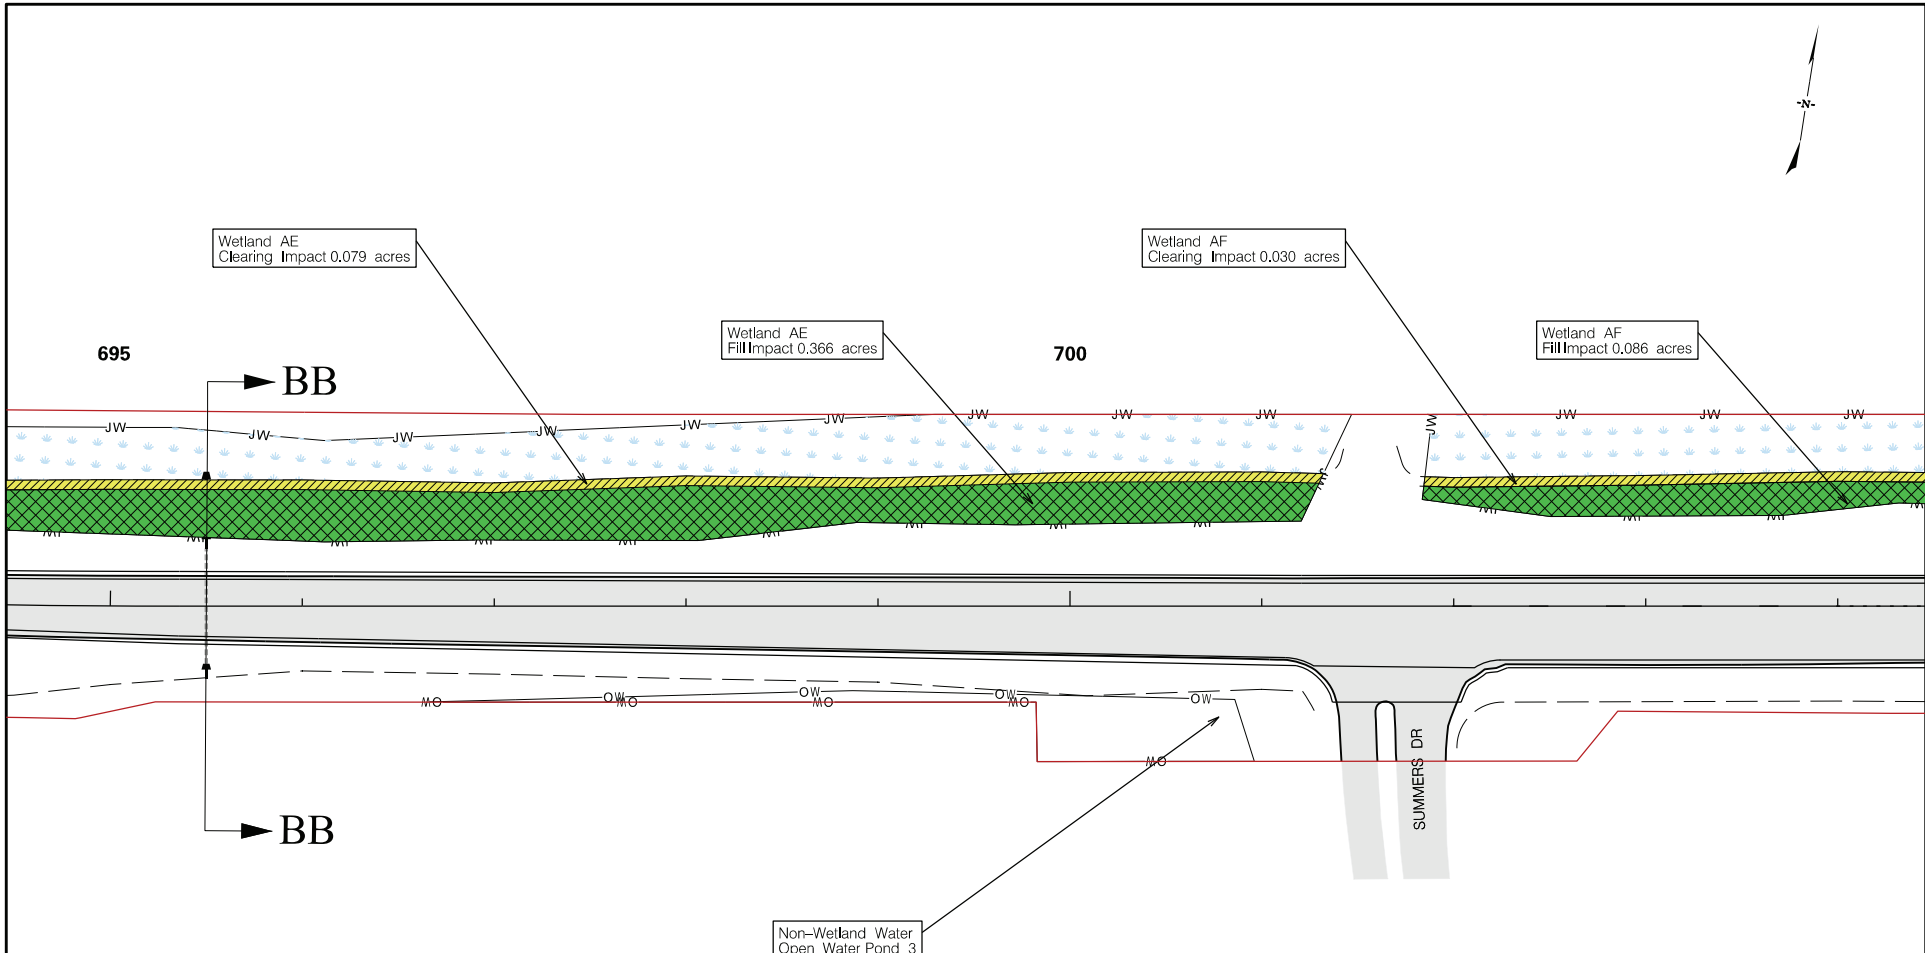

**LEGEND**


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- = PROPOSED CULVERT
- = PROPOSED PIPE
- = LIMITS OF CONSTRUCTION
- = WETLAND
- = NON-WETLAND WATER
- = NON-WETLAND WATER POND
- = RIP-RAP
- = WETLAND FILL IMPACT
- = EXISTING ROADWAY
- = WETLAND CLEARING IMPACT
- = NON-WETLAND WATER IMPACT

<b>APPLICANT</b>
<p>South Carolina Department of Transportation</p>








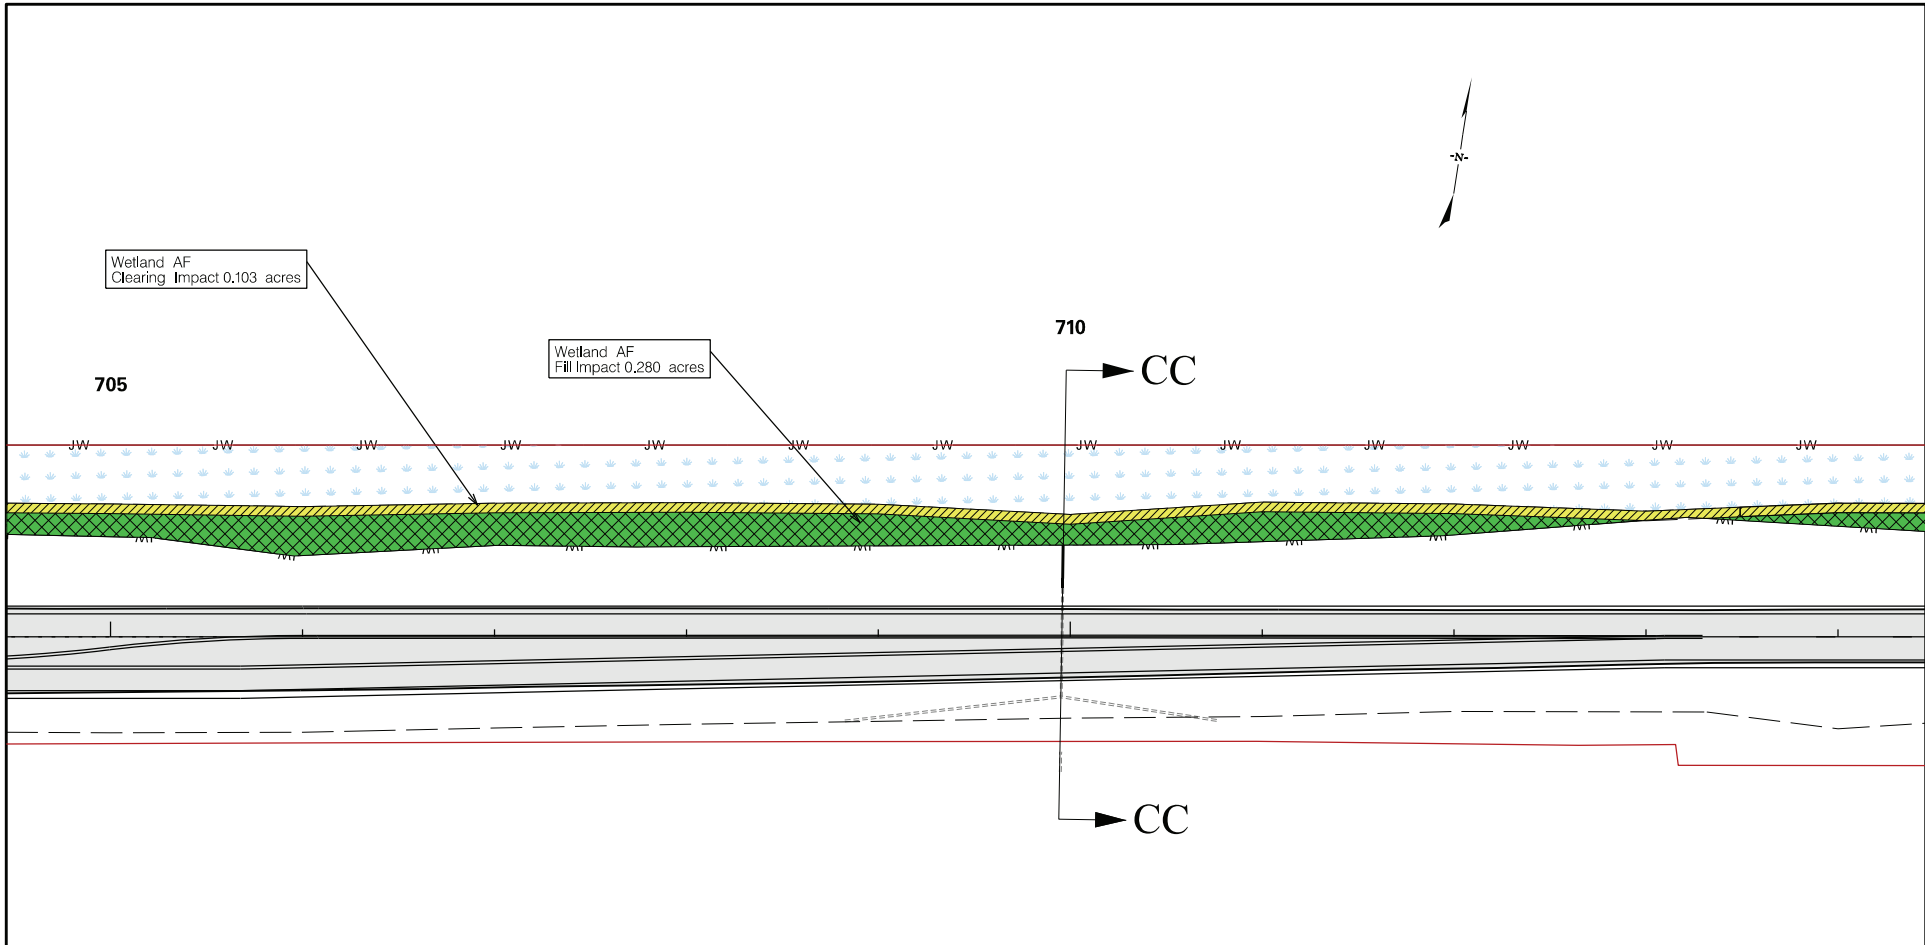




Sheet Totals:	
Wetland Fill:	0.452 acres
Wetland Clearing:	0.109 acres


<b>SHEET TITLE</b>
<b>USACE IMPACT PLAN VIEW</b>
<b>SCALE: 1" = 100'</b>

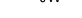
<b>PROJECT TITLE</b>
<b>DORCHESTER COUNTY PROJECT P062321 PROPOSED ROAD US 17A TRAFFIC SAFETY PROJECT</b>
<b>SHEET No. 46 OF 67</b>










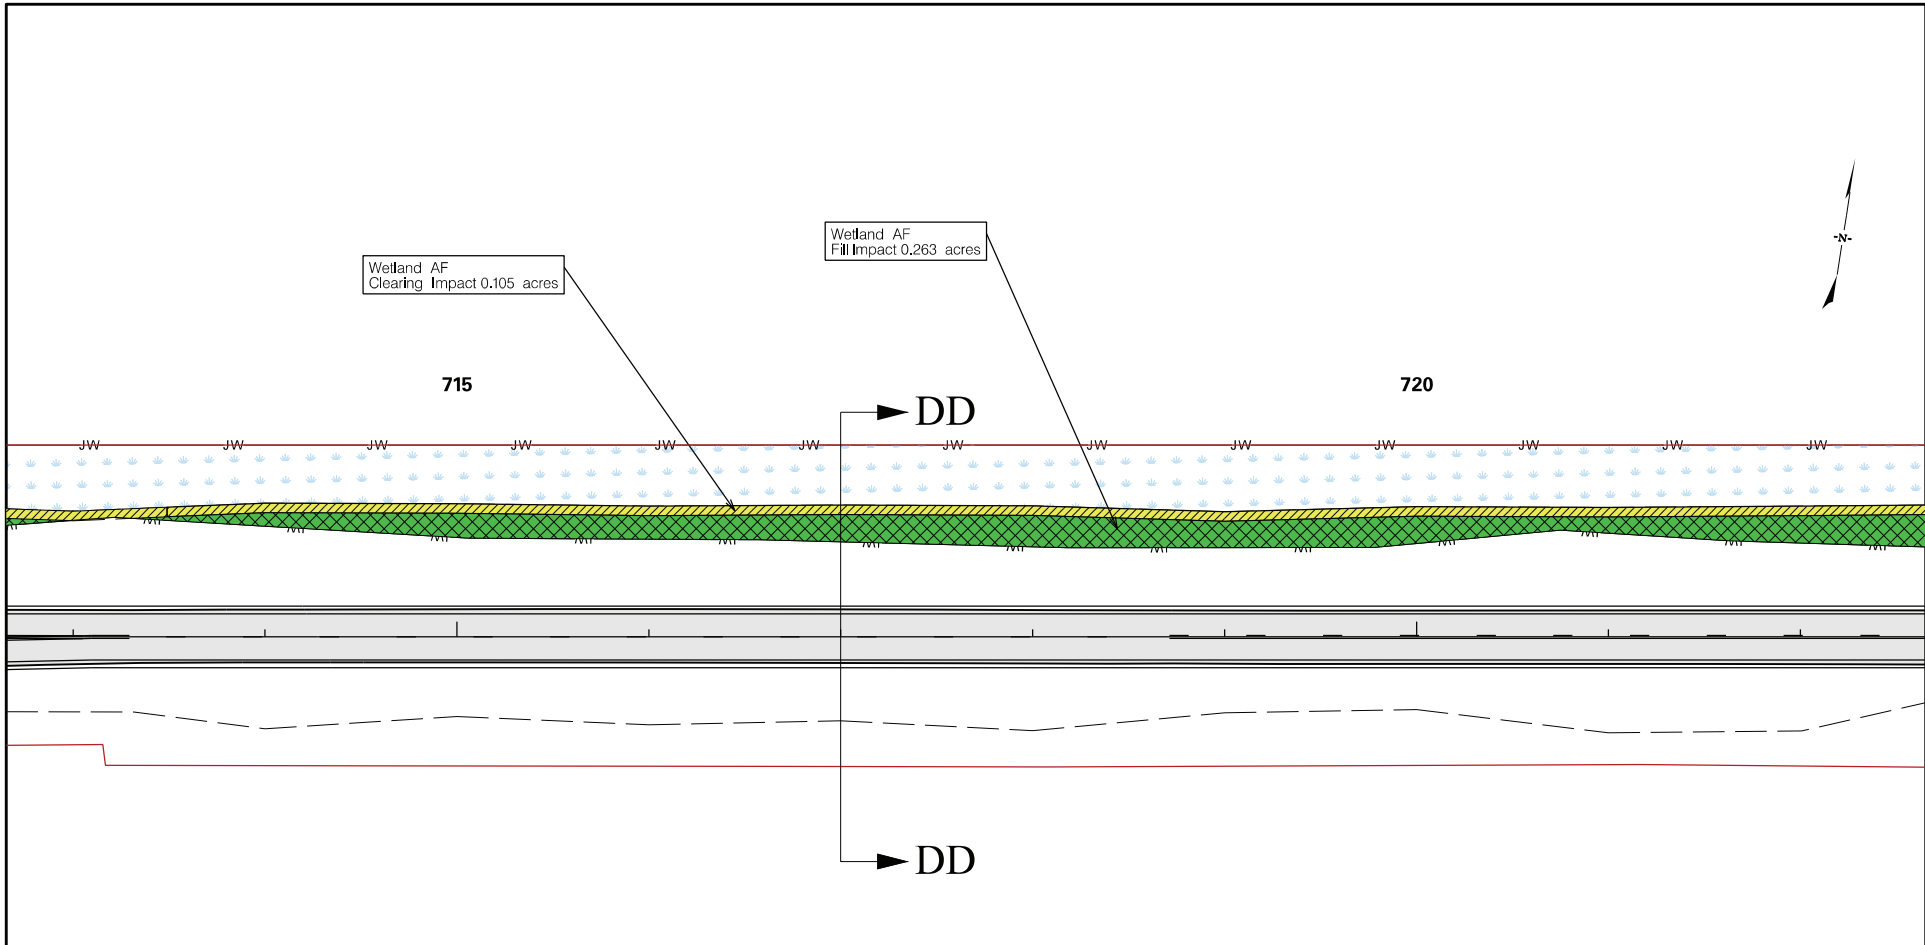




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
-  = PROJECT STUDY AREA
-  = PROPOSED CULVERT
-  = PROPOSED PIPE
-  = LIMITS OF CONSTRUCTION
-  = WETLAND
-  = NON-WETLAND WATER
-  = NON-WETLAND WATER POND
-  = RIP-RAP
-  = WETLAND FILL IMPACT
-  = EXISTING ROADWAY
-  = WETLAND CLEARING IMPACT
-  = NON-WETLAND WATER IMPACT


APPLICANT		SHEET TITLE	PROJECT TITLE
 South Carolina Department of Transportation	Sheet Totals: Wetland Fill: 0.280 acres Wetland Clearing: 0.103 acres	<b>USACE IMPACT PLAN VIEW</b>  SCALE: 1" = 100'	<b>DORCHESTER COUNTY PROJECT P062321 PROPOSED ROAD US 17A TRAFFIC SAFETY PROJECT</b>  SHEET No. 47 OF 67

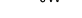

**LEGEND**

-  = PROJECT STUDY AREA
-  = PROPOSED CULVERT
-  = PROPOSED PIPE
-  = LIMITS OF CONSTRUCTION
-  = WETLAND
-  = NON-WETLAND WATER
-  = NON-WETLAND WATER POND
-  = RIP-RAP
-  = WETLAND FILL IMPACT
-  = EXISTING ROADWAY
-  = WETLAND CLEARING IMPACT
-  = NON-WETLAND WATER IMPACT


APPLICANT		SHEET TITLE	PROJECT TITLE
 South Carolina Department of Transportation	Sheet Totals: Wetland Fill: 0.263 acres Wetland Clearing: 0.105 acres	<b>USACE IMPACT PLAN VIEW</b>  SCALE: 1" = 100'	<b>DORCHESTER COUNTY PROJECT P062321 PROPOSED ROAD US 17A TRAFFIC SAFETY PROJECT</b>
			SHEET No. 48 OF 67

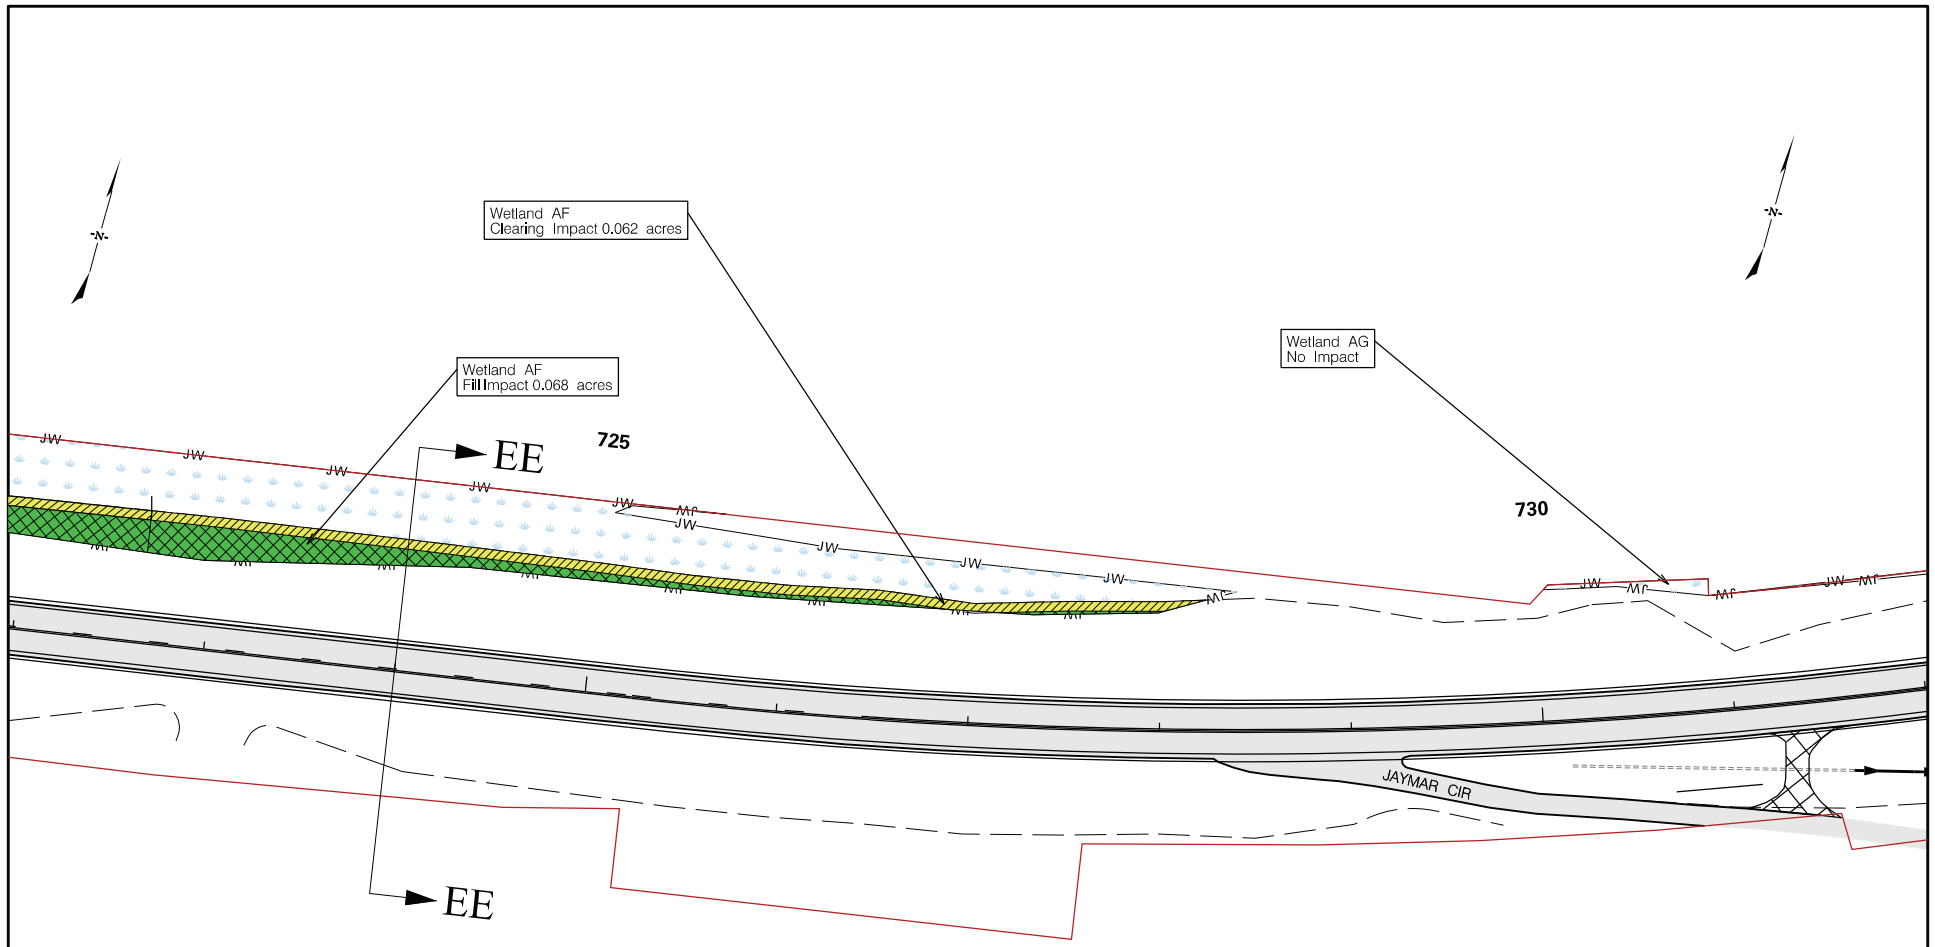

**LEGEND**


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- = PROPOSED CULVERT
- = PROPOSED PIPE
- = LIMITS OF CONSTRUCTION
- JW = WETLAND
- JT = NON-WETLAND WATER
- OW = NON-WETLAND WATER POND
- = RIP-RAP
- = WETLAND FILL IMPACT
- = EXISTING ROADWAY
- = WETLAND CLEARING IMPACT
- = NON-WETLAND WATER IMPACT


APPLICANT	SHEET TITLE	PROJECT TITLE
 South Carolina Department of Transportation	<b>USACE IMPACT PLAN VIEW</b>  <b>SCALE: 1" = 100'</b>	<b>DORCHESTER COUNTY PROJECT P062321 PROPOSED ROAD US 17A TRAFFIC SAFETY PROJECT</b>
<b>Sheet Totals:</b> Wetland Fill: 0.068 acres Wetland Clearing: 0.062 acres		<b>SHEET No. 49 OF 67</b>

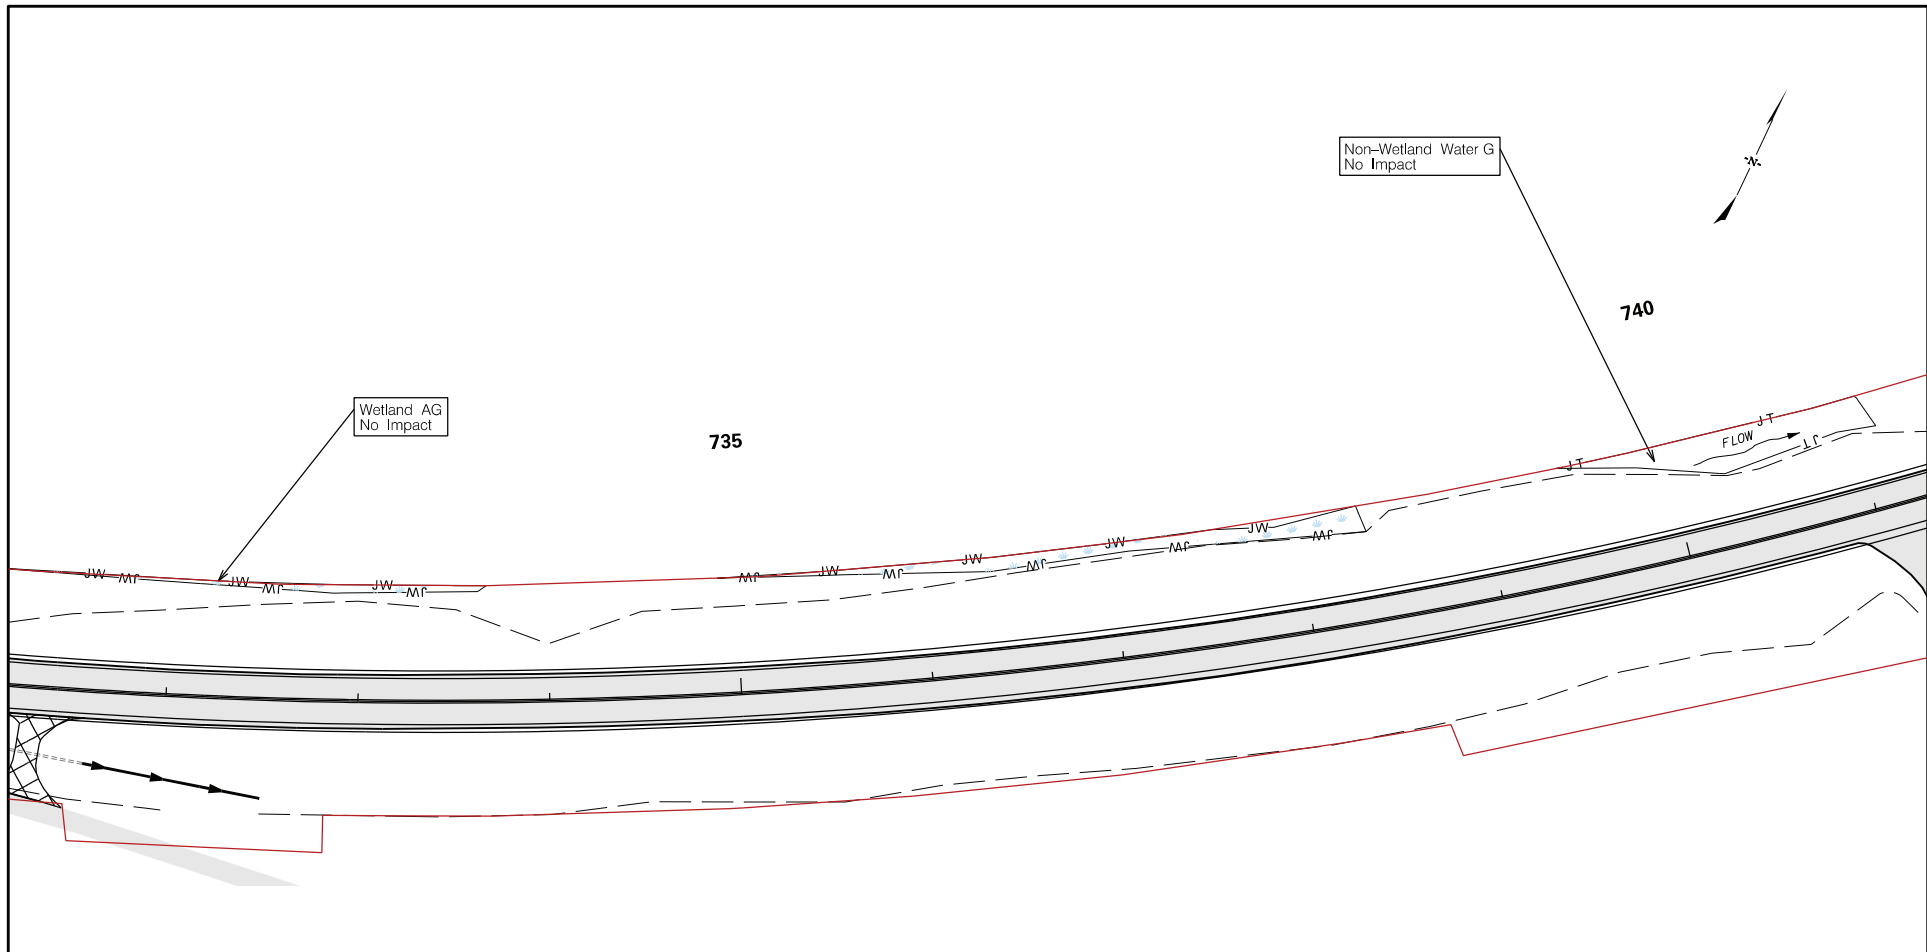

**LEGEND**


- = PROJECT STUDY AREA
- = PROPOSED CULVERT
- = PROPOSED PIPE
- = LIMITS OF CONSTRUCTION
- JW = WETLAND
- JT = NON-WETLAND WATER
- OW = NON-WETLAND WATER POND
- = RIP-RAP
- = WETLAND FILL IMPACT
- = EXISTING ROADWAY
- = WETLAND CLEARING IMPACT
- = NON-WETLAND WATER IMPACT

APPLICANT	SHEET TITLE	PROJECT TITLE
 <small>South Carolina Department of Transportation</small>	<b>USACE IMPACT PLAN VIEW</b>	<b>DORCHESTER COUNTY PROJECT P062321 PROPOSED ROAD US 17A TRAFFIC SAFETY PROJECT</b>
	<b>SCALE: 1" = 100'</b>	<b>SHEET No. 50 OF 67</b>

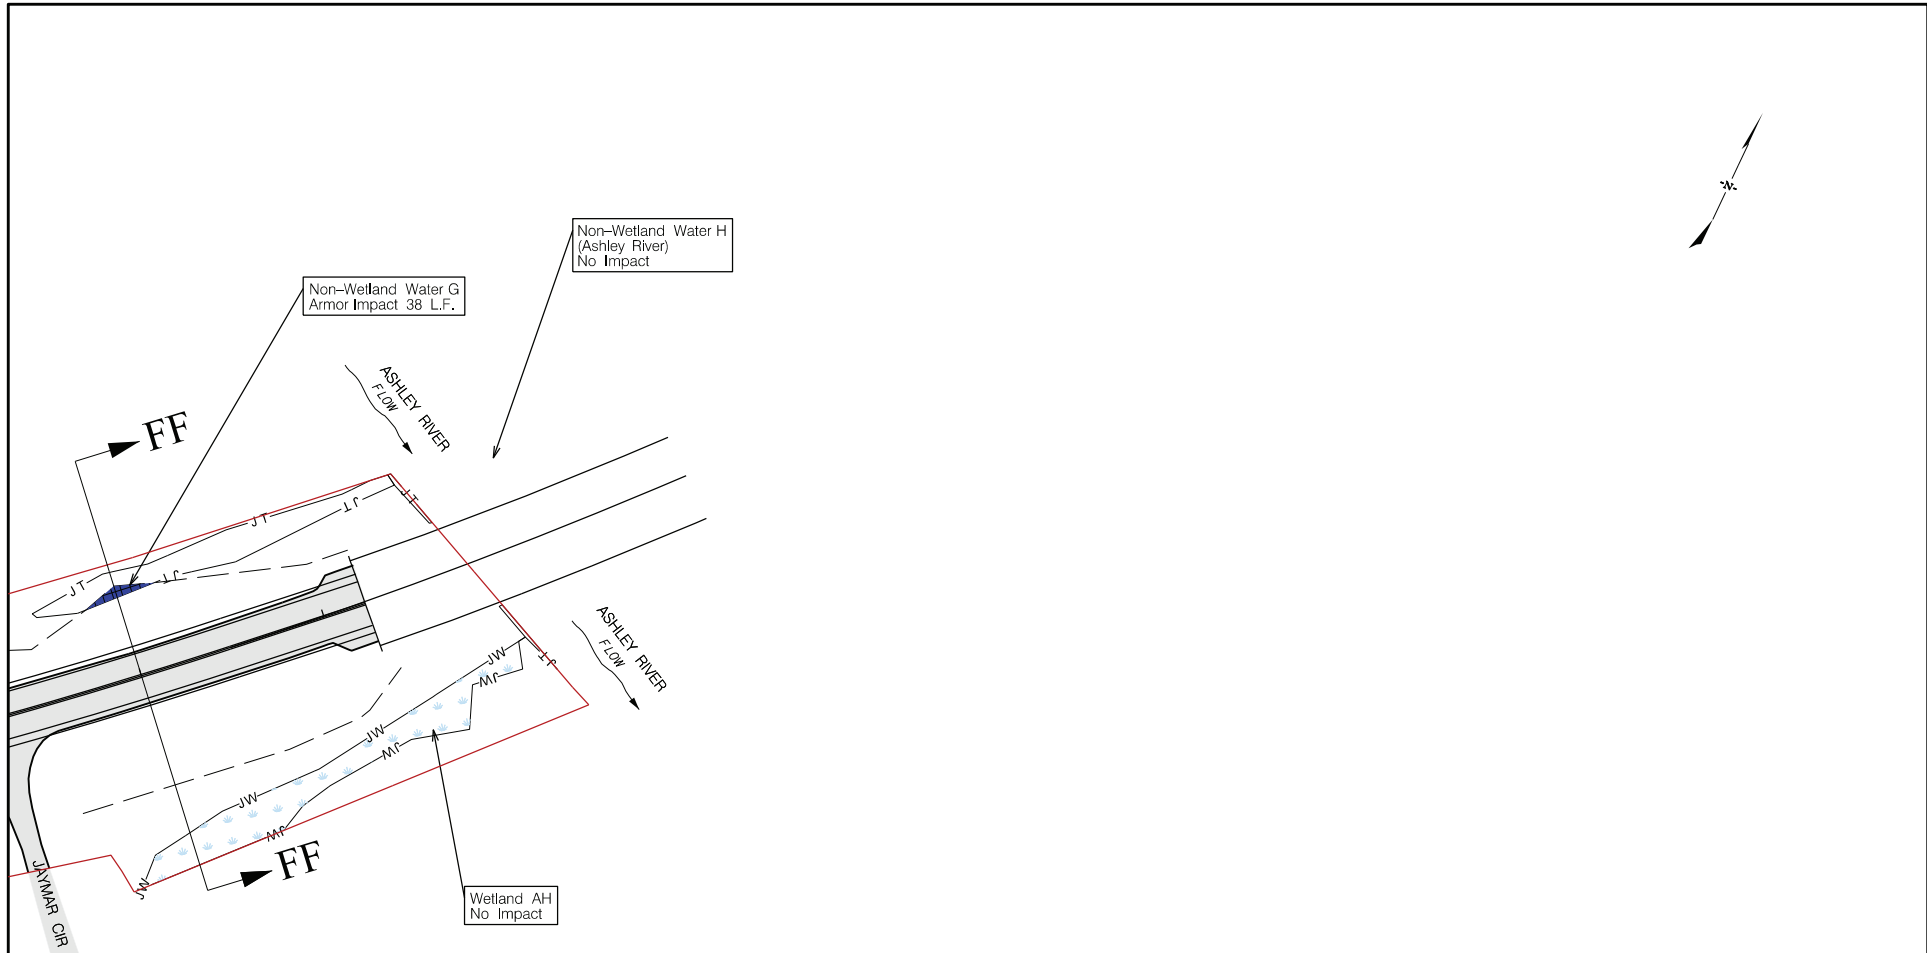


**LEGEND**

- = PROJECT STUDY AREA
- = PROPOSED CULVERT
- = PROPOSED PIPE
- = LIMITS OF PIPE
- = LIMITS OF CONSTRUCTION
- JW = WETLAND
- JT = NON-WETLAND WATER
- OW = NON-WETLAND WATER POND
- = RIP-RAP
- = WETLAND FILL IMPACT
- = EXISTING ROADWAY
- = WETLAND CLEARING IMPACT
- = NON-WETLAND WATER IMPACT




APPLICANT		SHEET TITLE	PROJECT TITLE
 South Carolina Department of Transportation	Sheet Totals: Non-Wetland Water G-Armor Impact: 38 L.F.	<b>USACE IMPACT PLAN VIEW</b>  SCALE: 1" = 100'	<b>DORCHESTER COUNTY PROJECT P062321 PROPOSED ROAD US 17A TRAFFIC SAFETY PROJECT</b>
			SHEET No. 51 OF 67

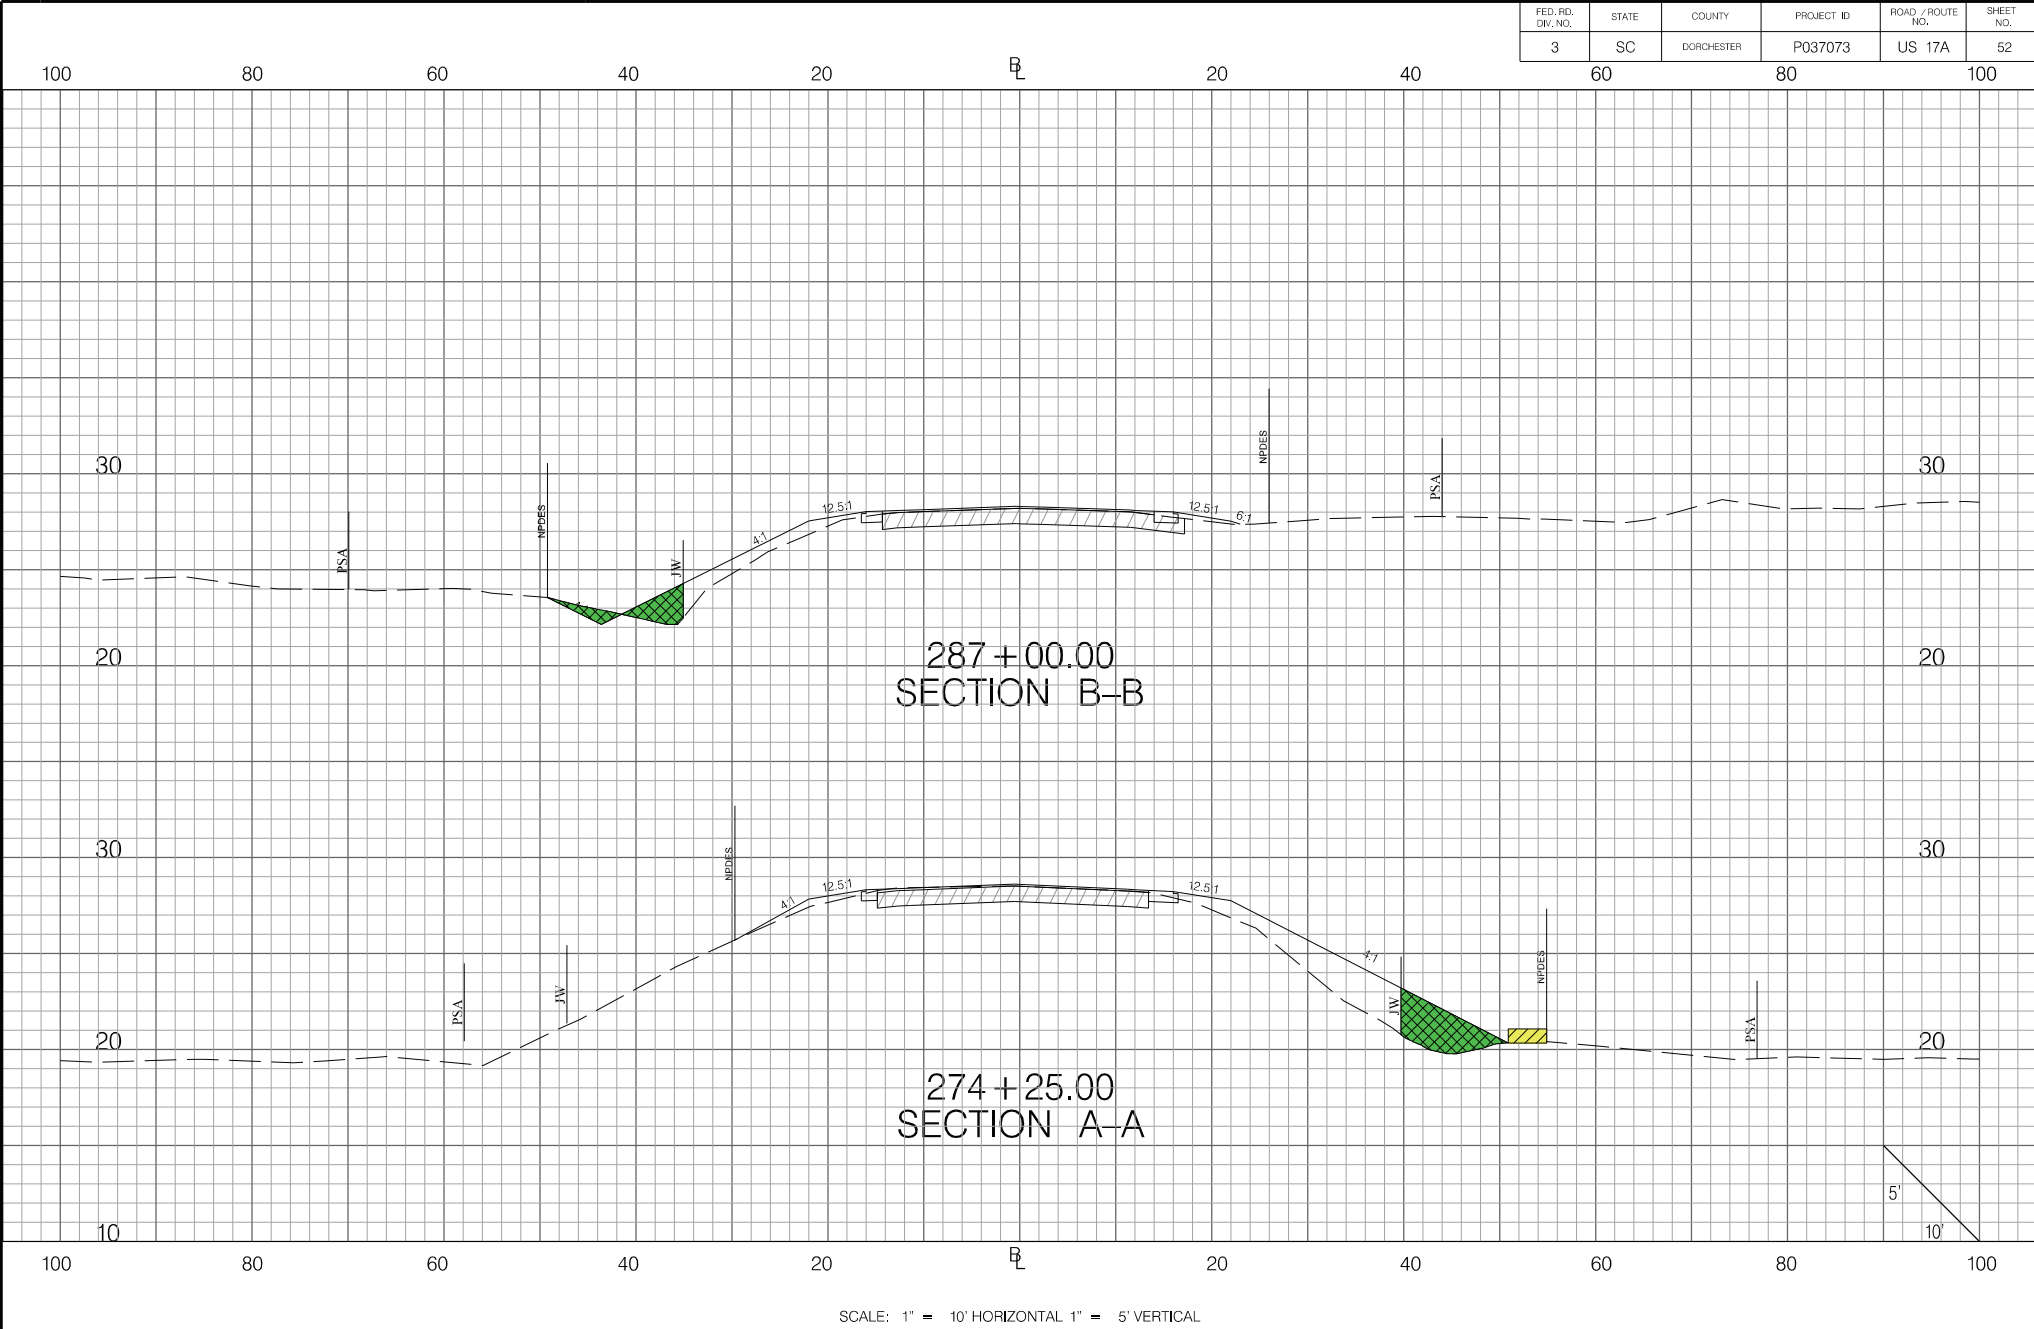FED. RD. DIV. NO.	STATE	COUNTY	PROJECT ID	ROAD / ROUTE NO.	SHEET NO.
3	SC	DORCHESTER	P037073	US 17A	52



SCALE: 1" = 10' HORIZONTAL 1" = 5' VERTICAL

LEGEND

-  WETLAND FILL IMPACT
-  WETLAND CLEARING IMPACT
-  NON-WETLAND WATER IMPACT



South Carolina Department of Transportation

SOUTH CAROLINA DEPARTMENT OF TRANSPORTATION  
US 17 ALTERNATE


CROSS SECTION SHEET

US 17 ALTERNATE  
RURAL ROADS SAFETY PROJECT

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




FED. RD. DIV. NO.	STATE	COUNTY	PROJECT ID	ROAD / ROUTE NO.	SHEET NO.
3	SC	DORCHESTER	P037073	US 17A	53

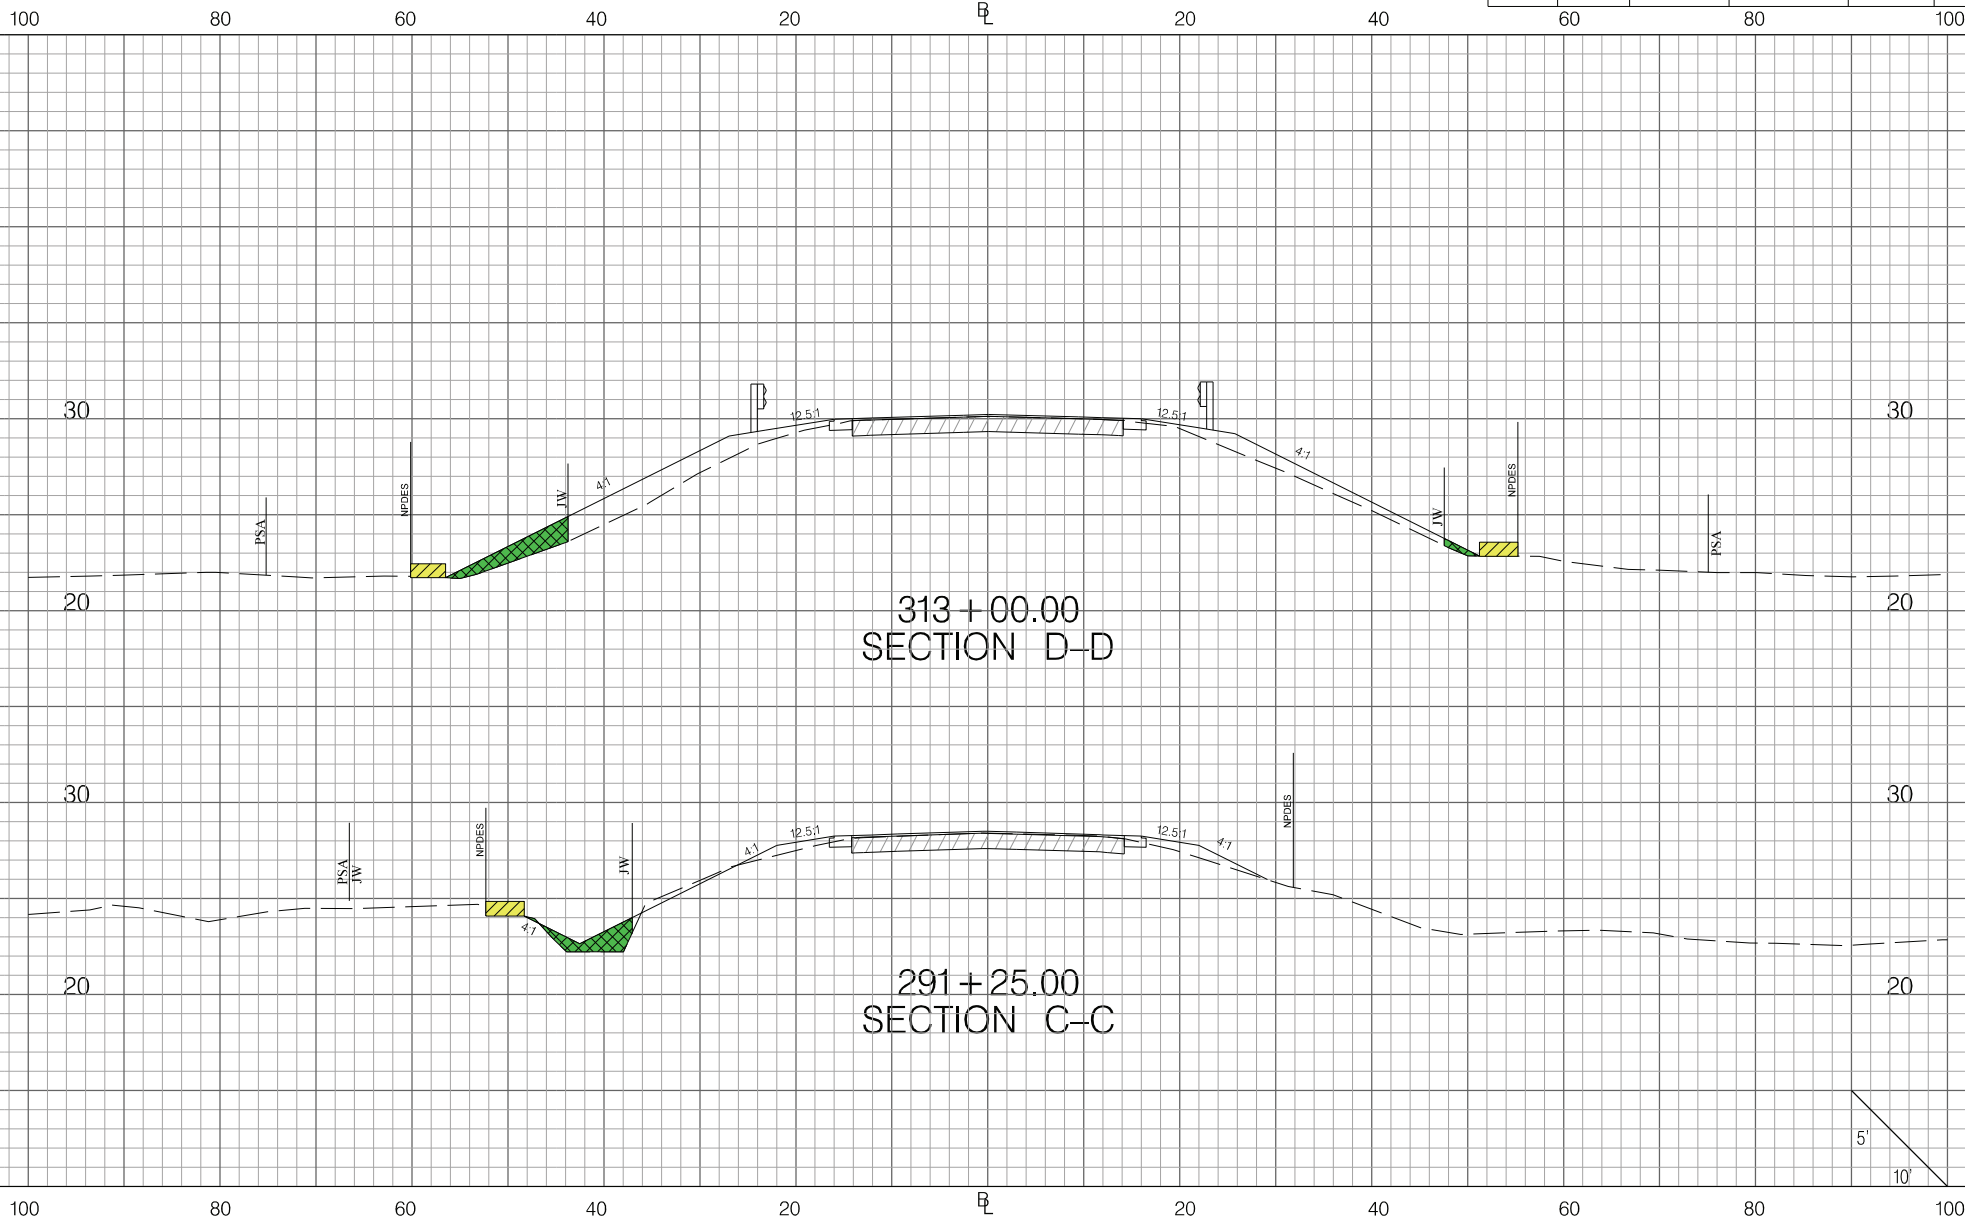

SCALE: 1" = 10' HORIZONTAL 1" = 5' VERTICAL

LEGEND

-  WETLAND FILL IMPACT
-  WETLAND CLEARING IMPACT
-  NON-WETLAND WATER IMPACT



South Carolina Department of Transportation

SOUTH CAROLINA DEPARTMENT OF TRANSPORTATION  
US 17 ALTERNATE


CROSS SECTION SHEET

US 17 ALTERNATE  
RURAL ROADS SAFETY PROJECT

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


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FED. RD. DIV. NO.	STATE	COUNTY	PROJECT ID	ROAD / ROUTE NO.	SHEET NO.
3	SC	DORCHESTER	P037073	US 17A	54

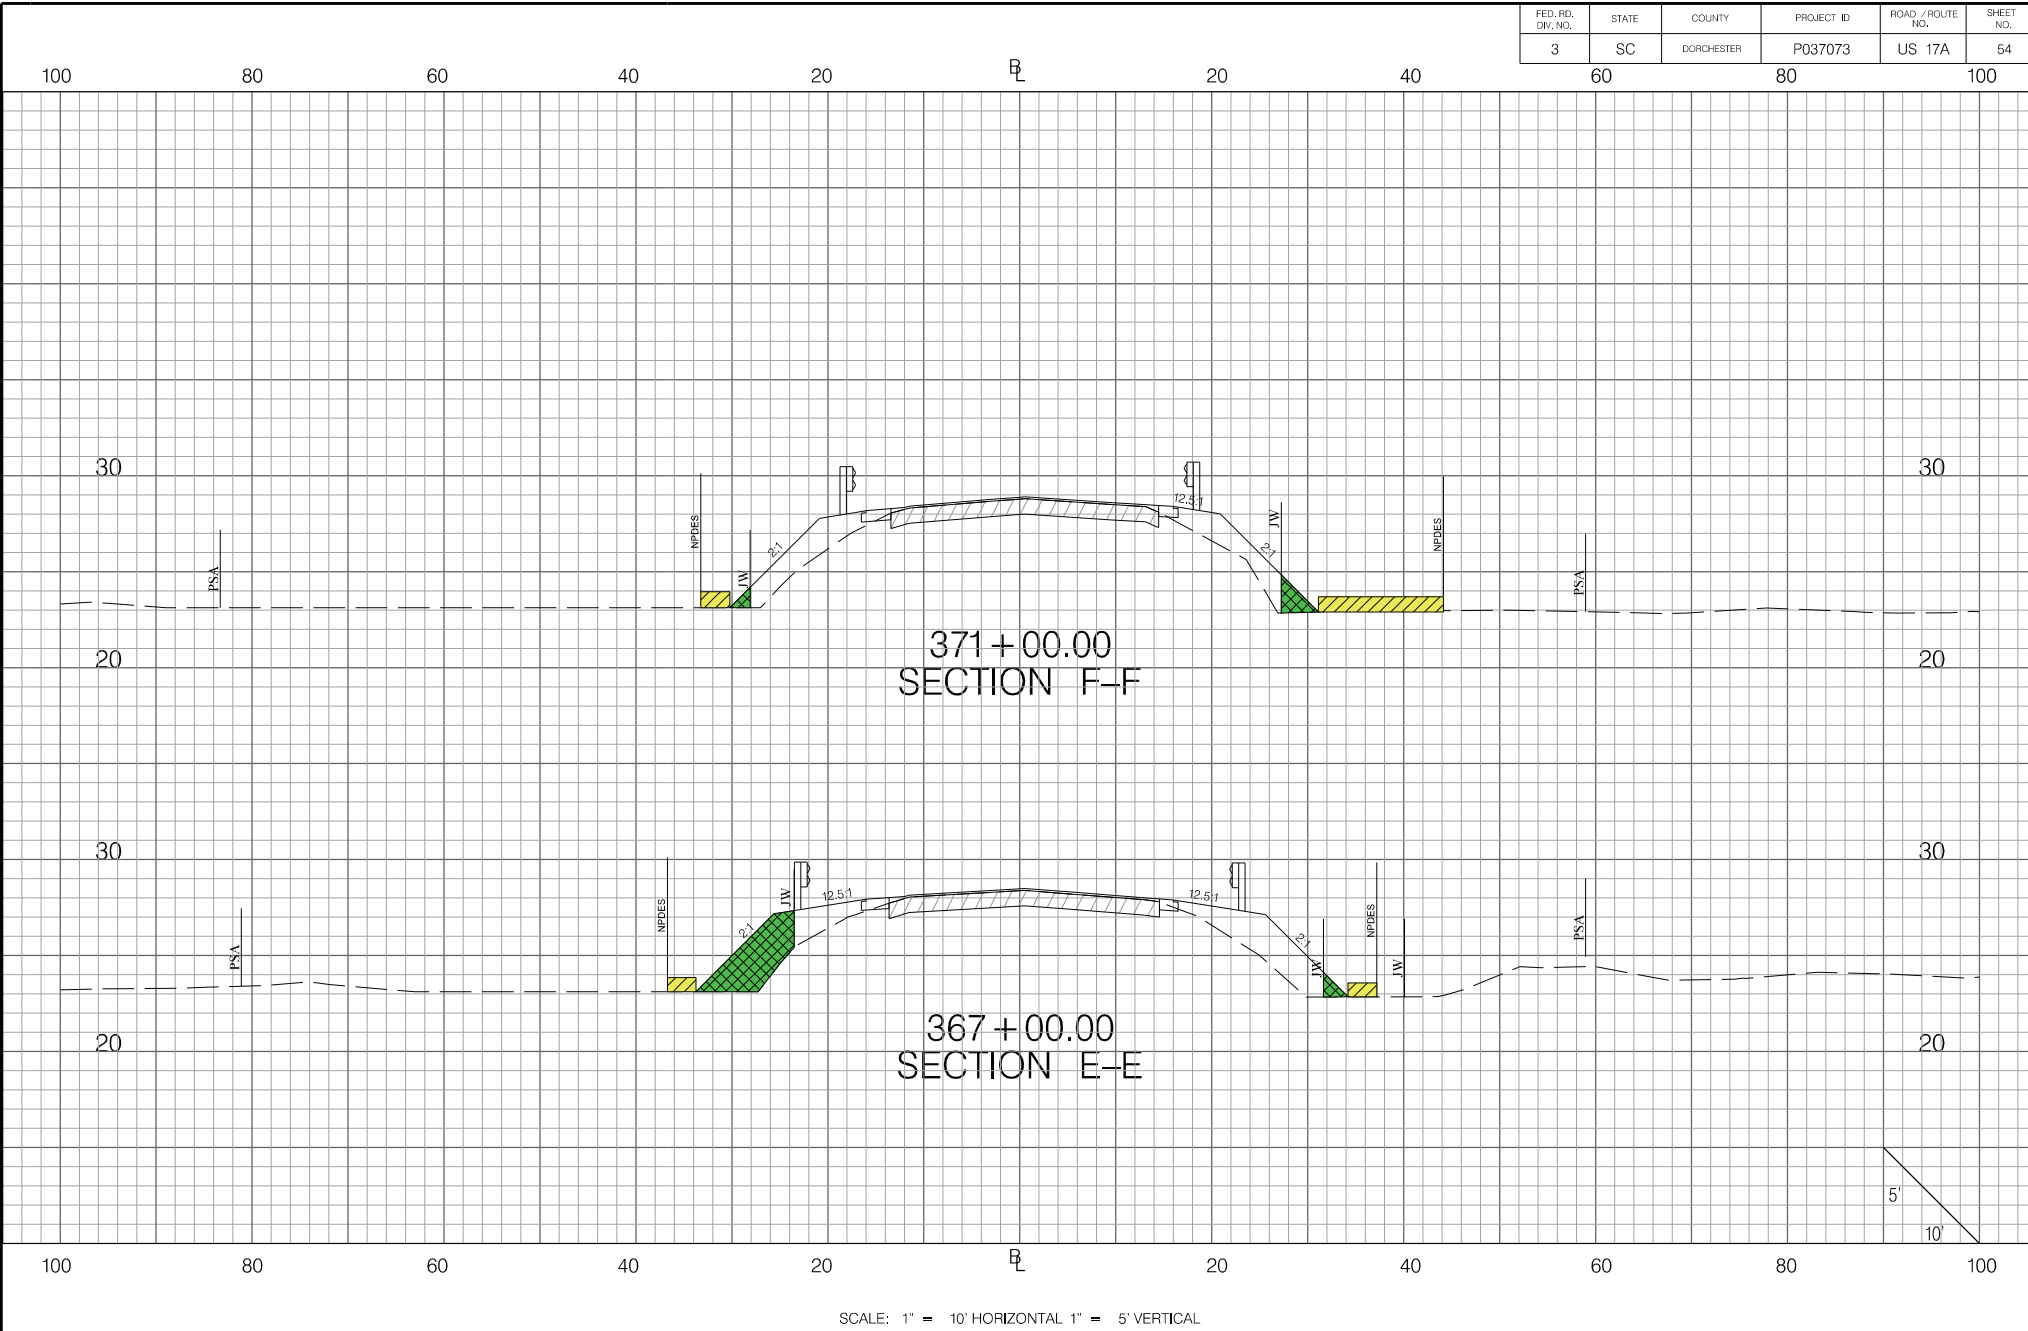

SCALE: 1" = 10' HORIZONTAL 1" = 5' VERTICAL

LEGEND

-  WETLAND FILL IMPACT
-  WETLAND CLEARING IMPACT
-  NON-WETLAND WATER IMPACT



South Carolina Department of Transportation


SOUTH CAROLINA DEPARTMENT OF TRANSPORTATION  
US 17 ALTERNATE

CROSS SECTION SHEET

US 17 ALTERNATE  
RURAL ROADS SAFETY PROJECT




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FED. RD. DIV. NO.	STATE	COUNTY	PROJECT ID	ROAD / ROUTE NO.	SHEET NO.
3	SC	DORCHESTER	P037073	US 17A	55

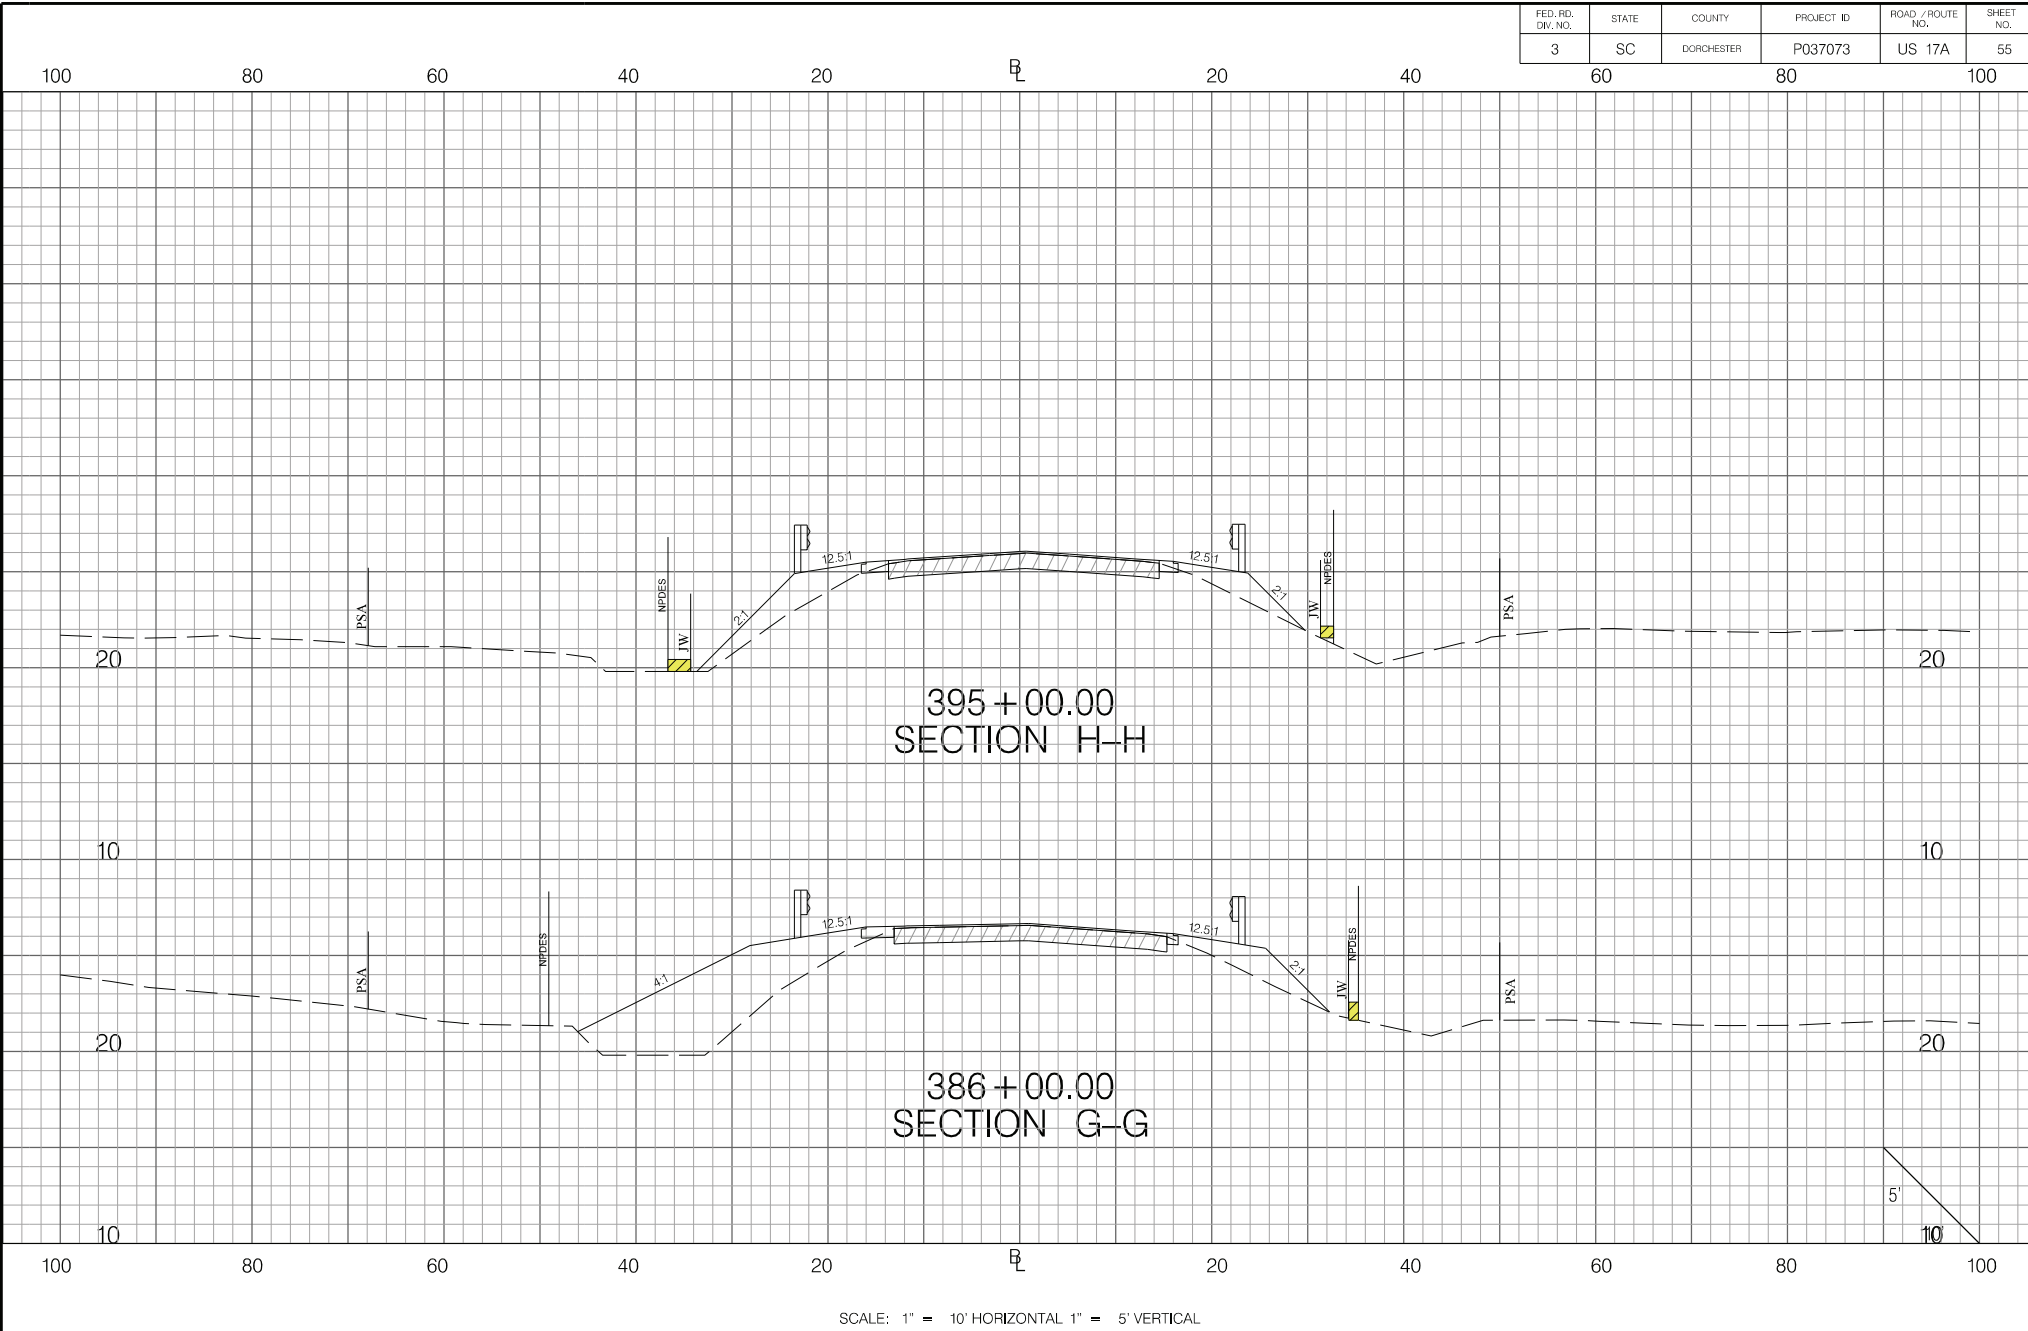

SCALE: 1" = 10' HORIZONTAL 1" = 5' VERTICAL

LEGEND

-  WETLAND FILL IMPACT
-  WETLAND CLEARING IMPACT
-  NON-WETLAND WATER IMPACT



South Carolina Department of Transportation


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US 17 ALTERNATE

CROSS SECTION SHEET

US 17 ALTERNATE  
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


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FED. RD. DIV. NO.	STATE	COUNTY	PROJECT ID	ROAD / ROUTE NO.	SHEET NO.
3	SC	DORCHESTER	P037073	US 17A	56

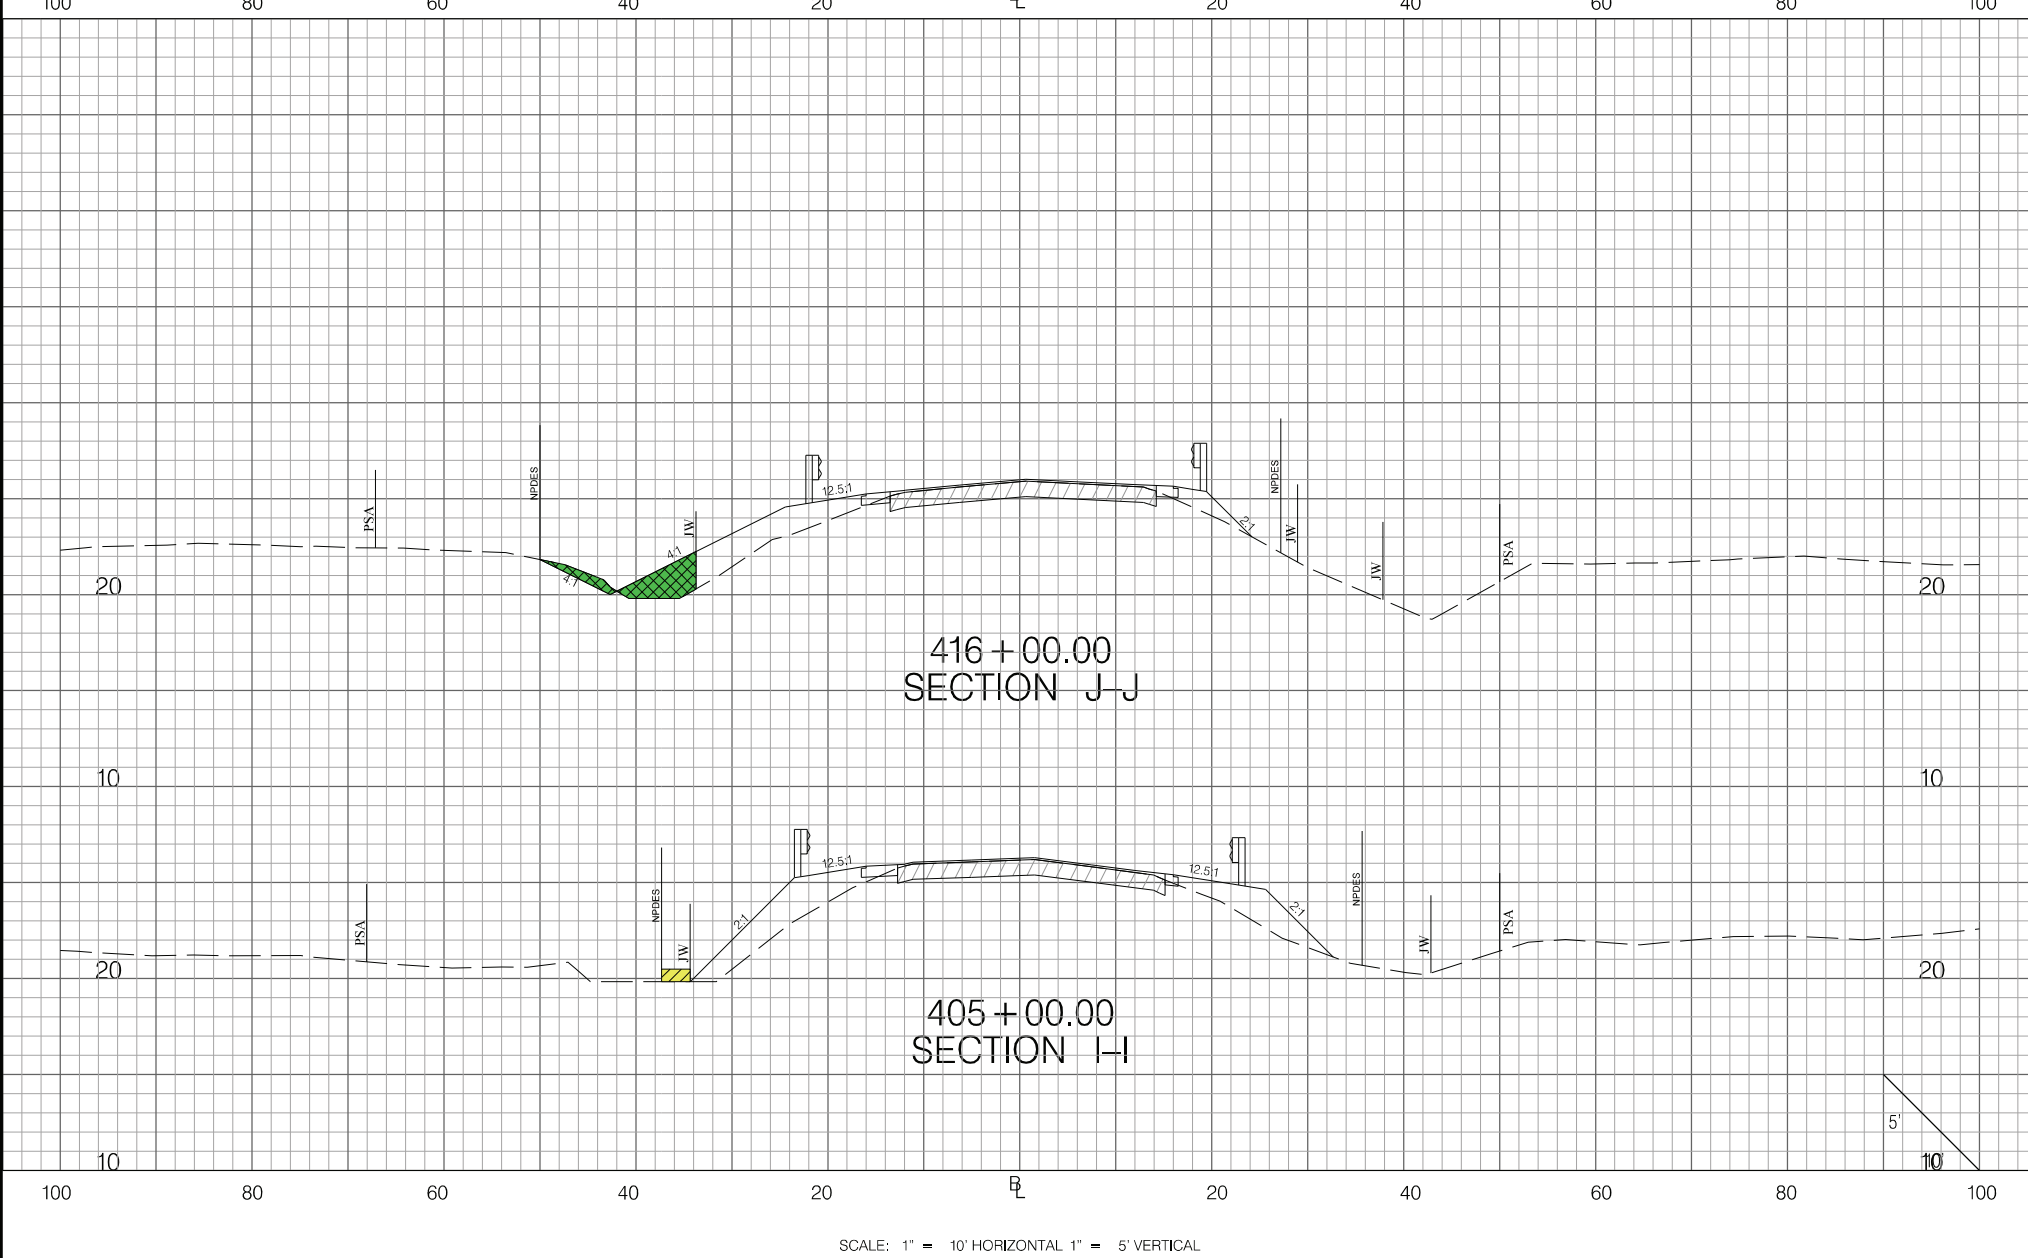

SCALE: 1" = 10' HORIZONTAL 1" = 5' VERTICAL

LEGEND

-  WETLAND FILL IMPACT
-  WETLAND CLEARING IMPACT
-  NON-WETLAND WATER IMPACT



South Carolina Department of Transportation


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US 17 ALTERNATE

CROSS SECTION SHEET

US 17 ALTERNATE  
RURAL ROADS SAFETY PROJECT




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FED. RD. DIV. NO.	STATE	COUNTY	PROJECT ID	ROAD / ROUTE NO.	SHEET NO.
3	SC	DORCHESTER	P037073	US 17A	57

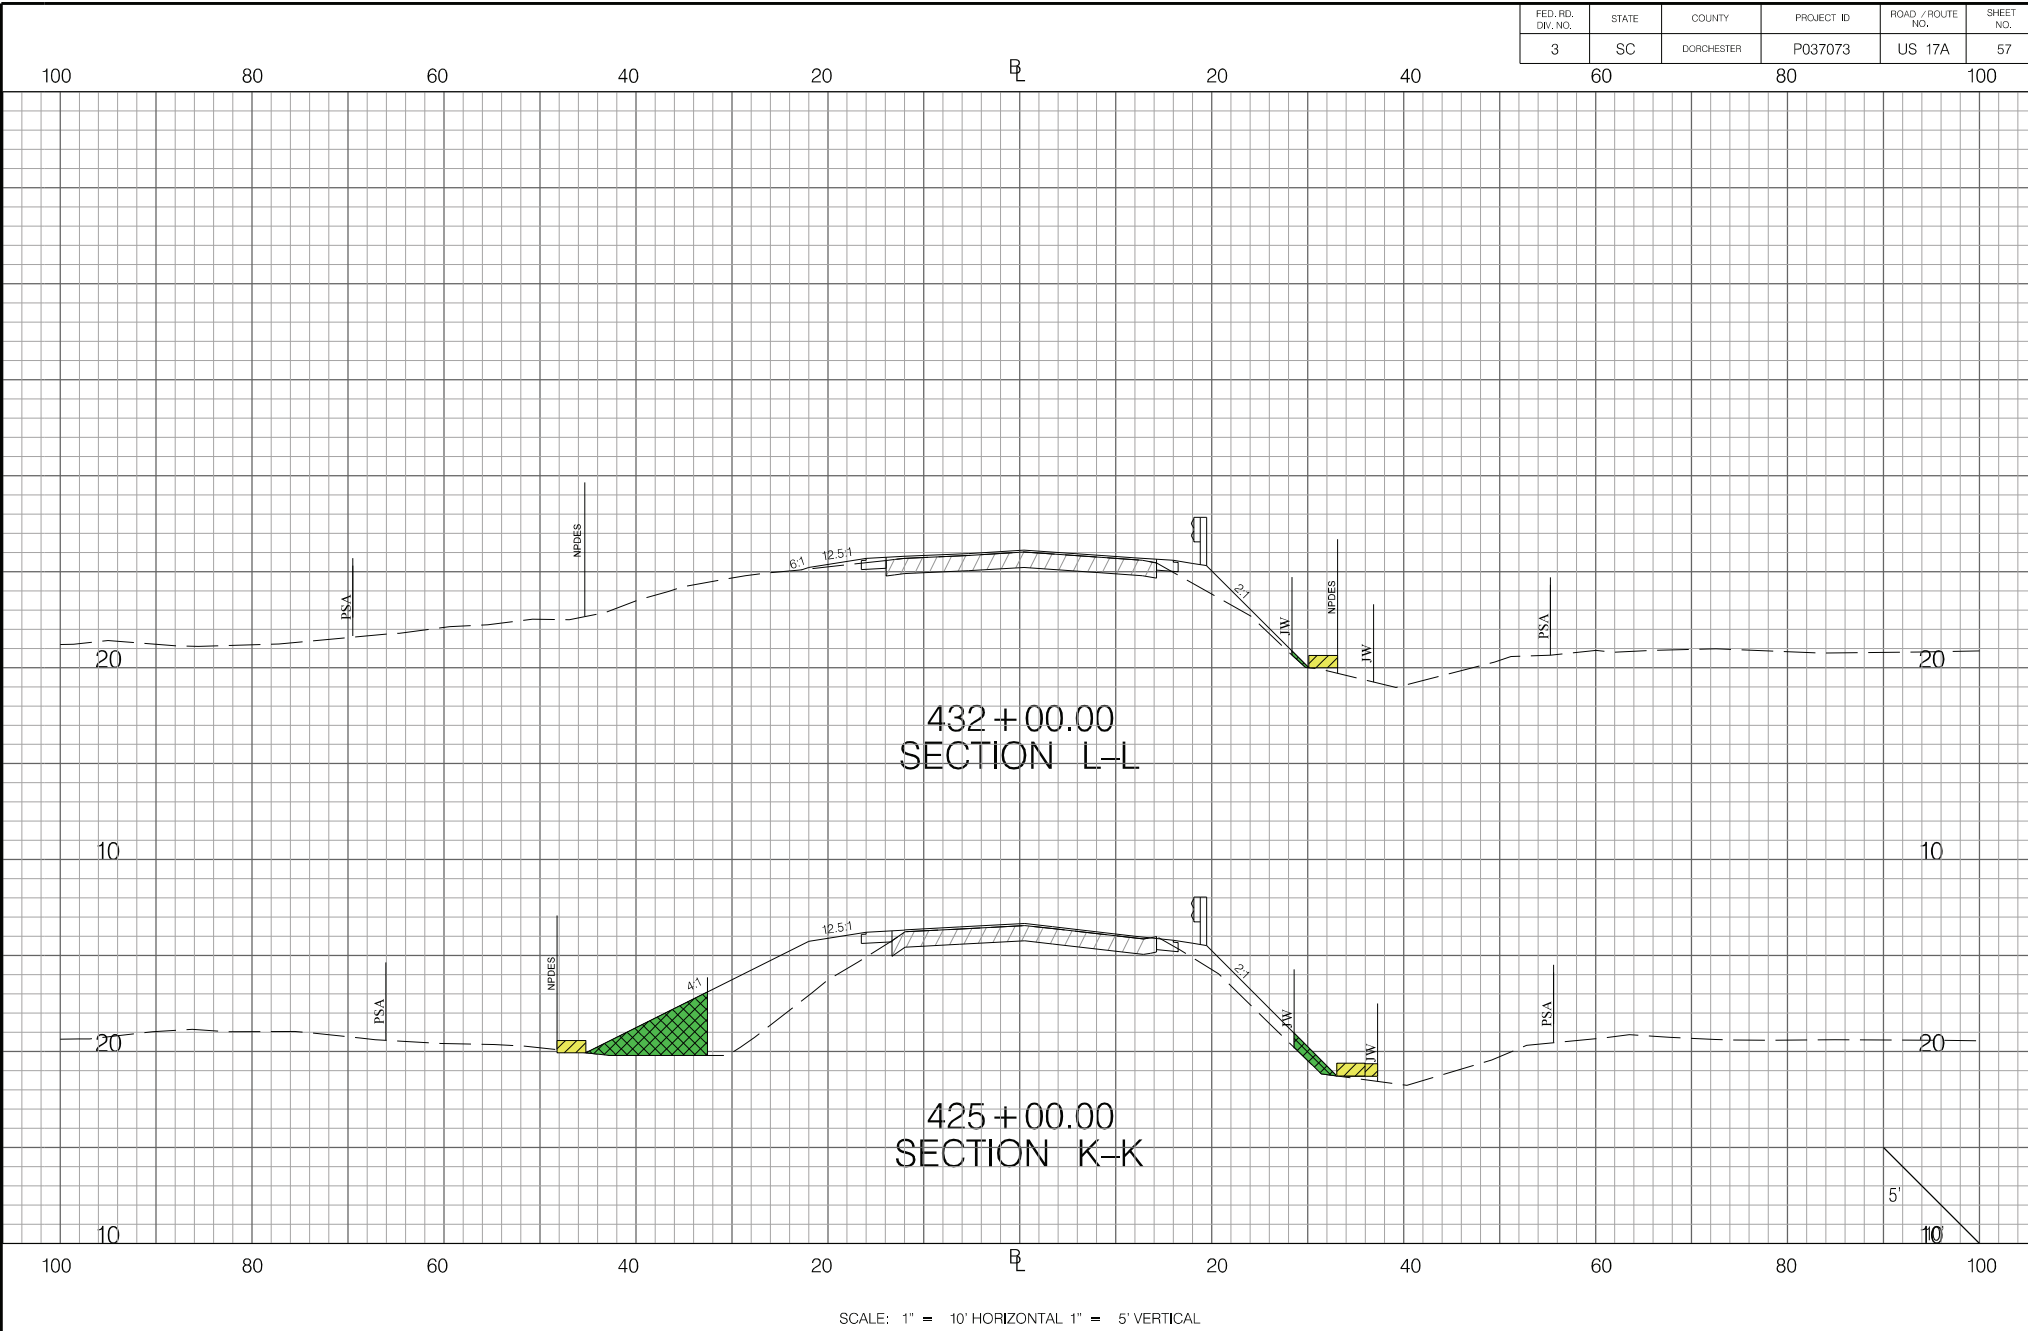

SCALE: 1" = 10' HORIZONTAL 1" = 5' VERTICAL

LEGEND

-  WETLAND FILL IMPACT
-  WETLAND CLEARING IMPACT
-  NON-WETLAND WATER IMPACT




South Carolina Department of Transportation

SOUTH CAROLINA DEPARTMENT OF TRANSPORTATION  
US 17 ALTERNATE

CROSS SECTION SHEET




US 17 ALTERNATE  
RURAL ROADS SAFETY PROJECT

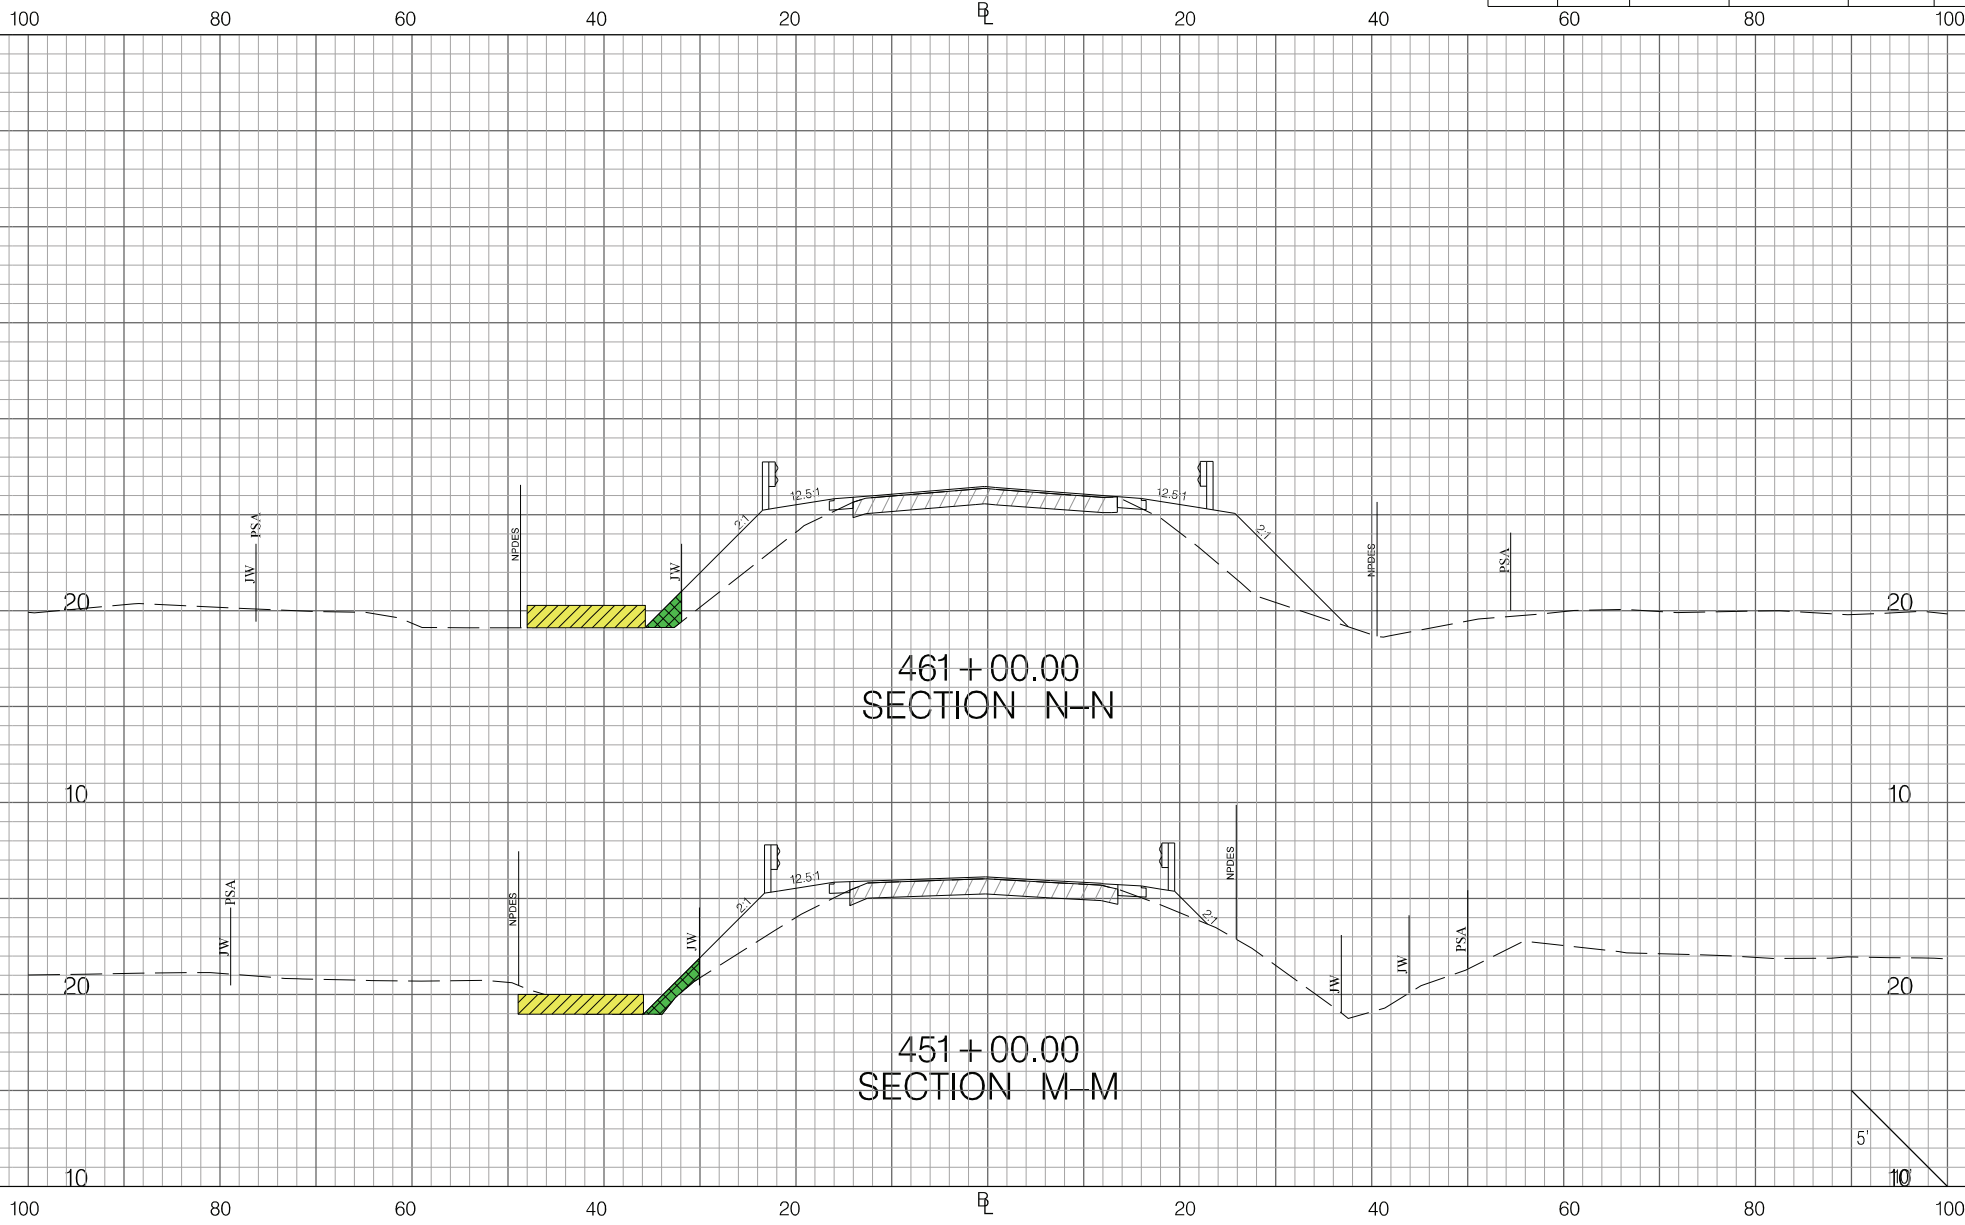FED. RD. DIV. NO.	STATE	COUNTY	PROJECT ID	ROAD / ROUTE NO.	SHEET NO.
3	SC	DORCHESTER	P037073	US 17A	58



SCALE: 1" = 10' HORIZONTAL 1" = 5' VERTICAL

LEGEND

-  WETLAND FILL IMPACT
-  WETLAND CLEARING IMPACT
-  NON-WETLAND WATER IMPACT



South Carolina Department of Transportation


SOUTH CAROLINA DEPARTMENT OF TRANSPORTATION  
US 17 ALTERNATE

CROSS SECTION SHEET

US 17 ALTERNATE  
RURAL ROADS SAFETY PROJECT




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FED. RD. DIV. NO.	STATE	COUNTY	PROJECT ID	ROAD / ROUTE NO.	SHEET NO.
3	SC	DORCHESTER	P037073	US 17A	59

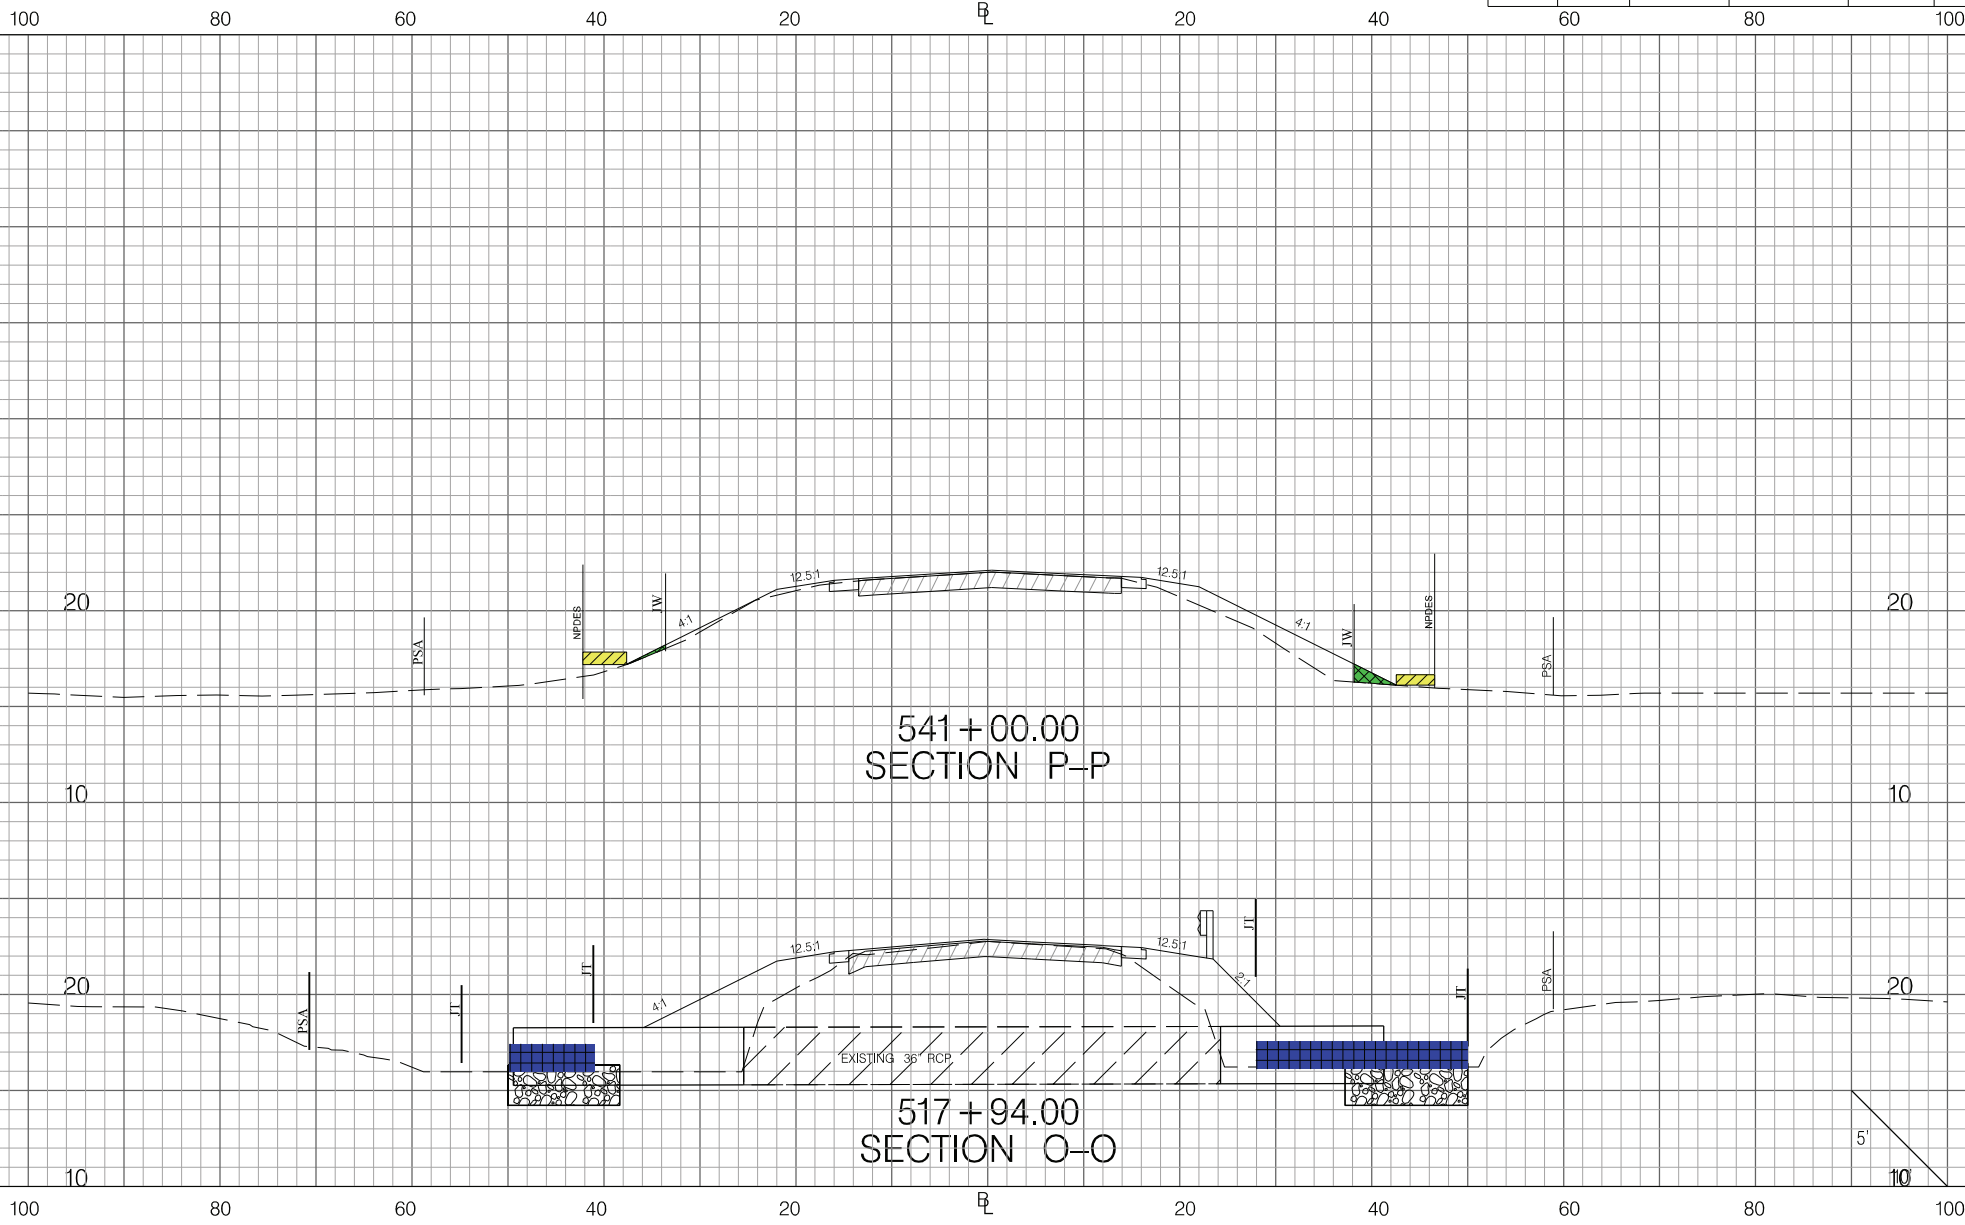

SCALE: 1" = 10' HORIZONTAL 1" = 5' VERTICAL

LEGEND

-  WETLAND FILL IMPACT
-  WETLAND CLEARING IMPACT
-  NON-WETLAND WATER IMPACT



South Carolina Department of Transportation

SOUTH CAROLINA DEPARTMENT OF TRANSPORTATION  
US 17 ALTERNATE


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US 17 ALTERNATE  
RURAL ROADS SAFETY PROJECT




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FED. RD. DIV. NO.	STATE	COUNTY	PROJECT ID	ROAD / ROUTE NO.	SHEET NO.
3	SC	DORCHESTER	P037073	US 17A	60



LEGEND

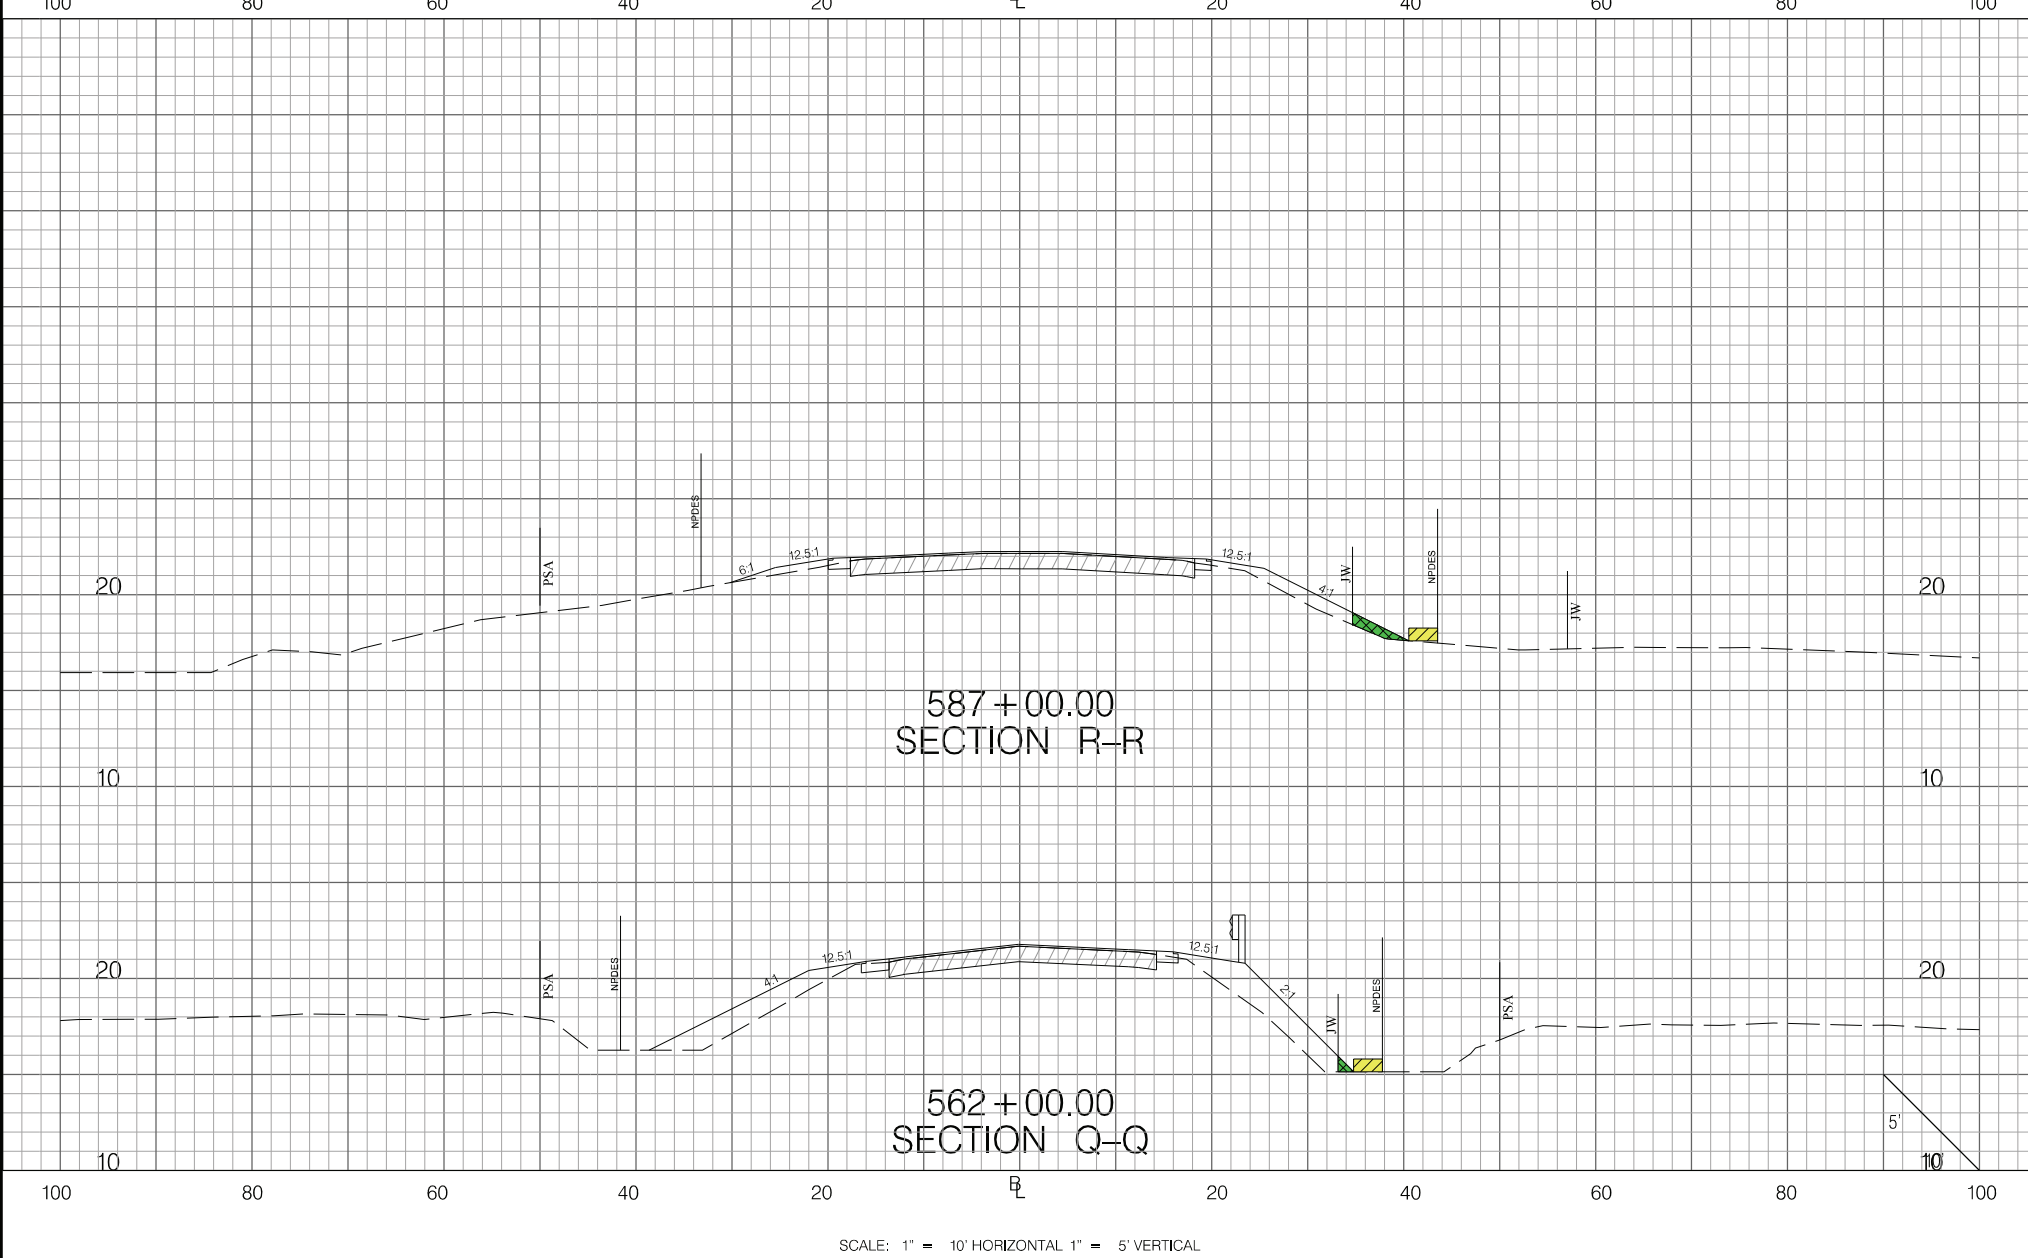-  WETLAND FILL IMPACT
-  WETLAND CLEARING IMPACT
-  NON-WETLAND WATER IMPACT



South Carolina Department of Transportation

SOUTH CAROLINA DEPARTMENT OF TRANSPORTATION  
US 17 ALTERNATE


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US 17 ALTERNATE  
RURAL ROADS SAFETY PROJECT






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FED. RD. DIV. NO.	STATE	COUNTY	PROJECT ID	ROAD / ROUTE NO.	SHEET NO.
3	SC	DORCHESTER	P037073	US 17A	61

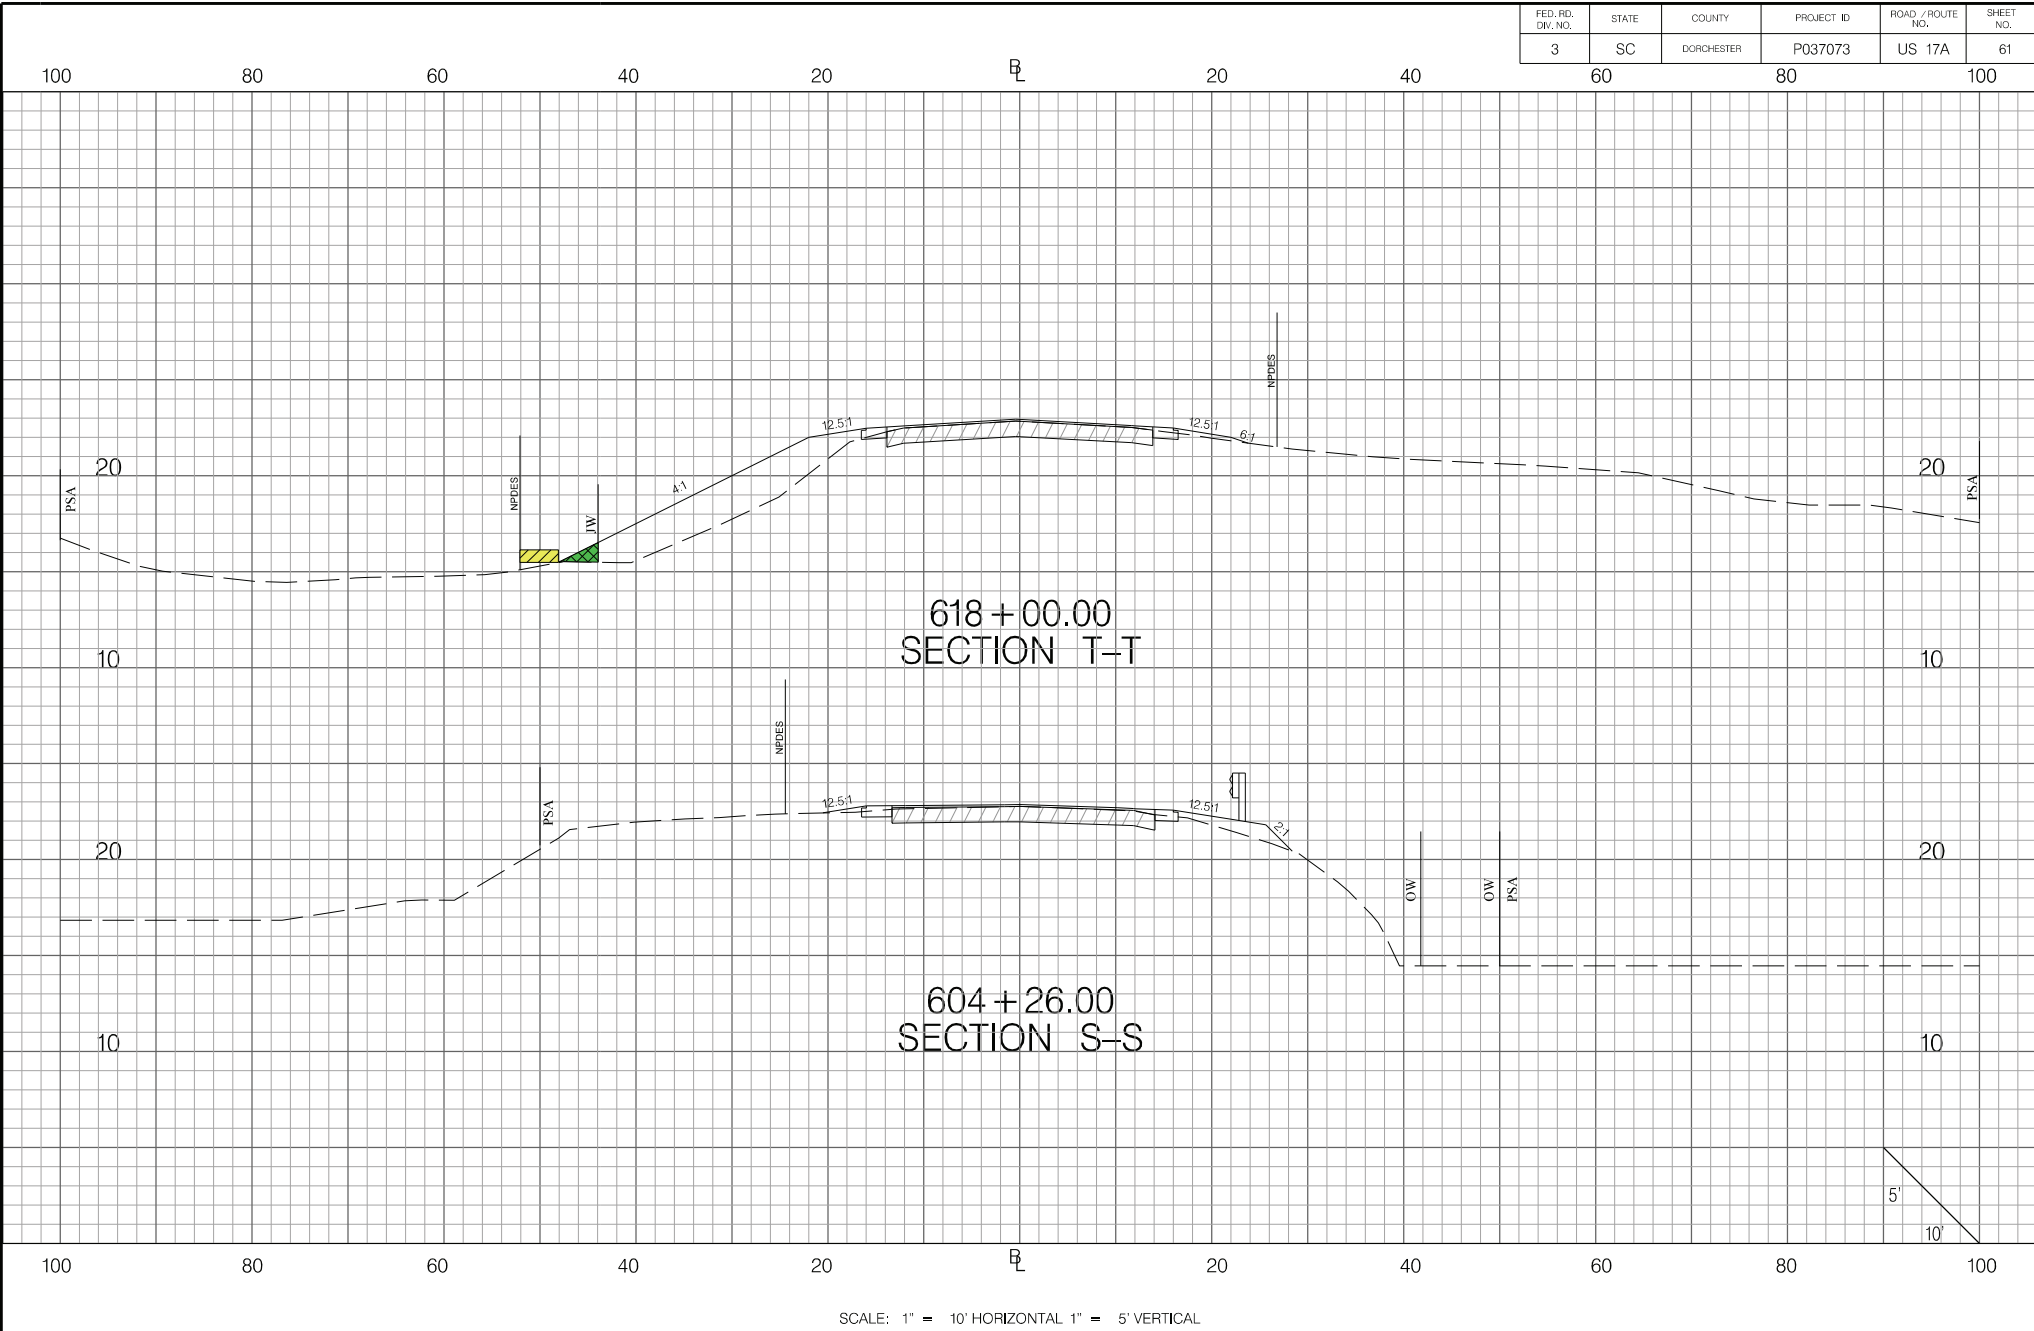

SCALE: 1" = 10' HORIZONTAL 1" = 5' VERTICAL

LEGEND

-  WETLAND FILL IMPACT
-  WETLAND CLEARING IMPACT
-  NON-WETLAND WATER IMPACT




South Carolina Department of Transportation

SOUTH CAROLINA DEPARTMENT OF TRANSPORTATION  
US 17 ALTERNATE

CROSS SECTION SHEET




US 17 ALTERNATE  
RURAL ROADS SAFETY PROJECT

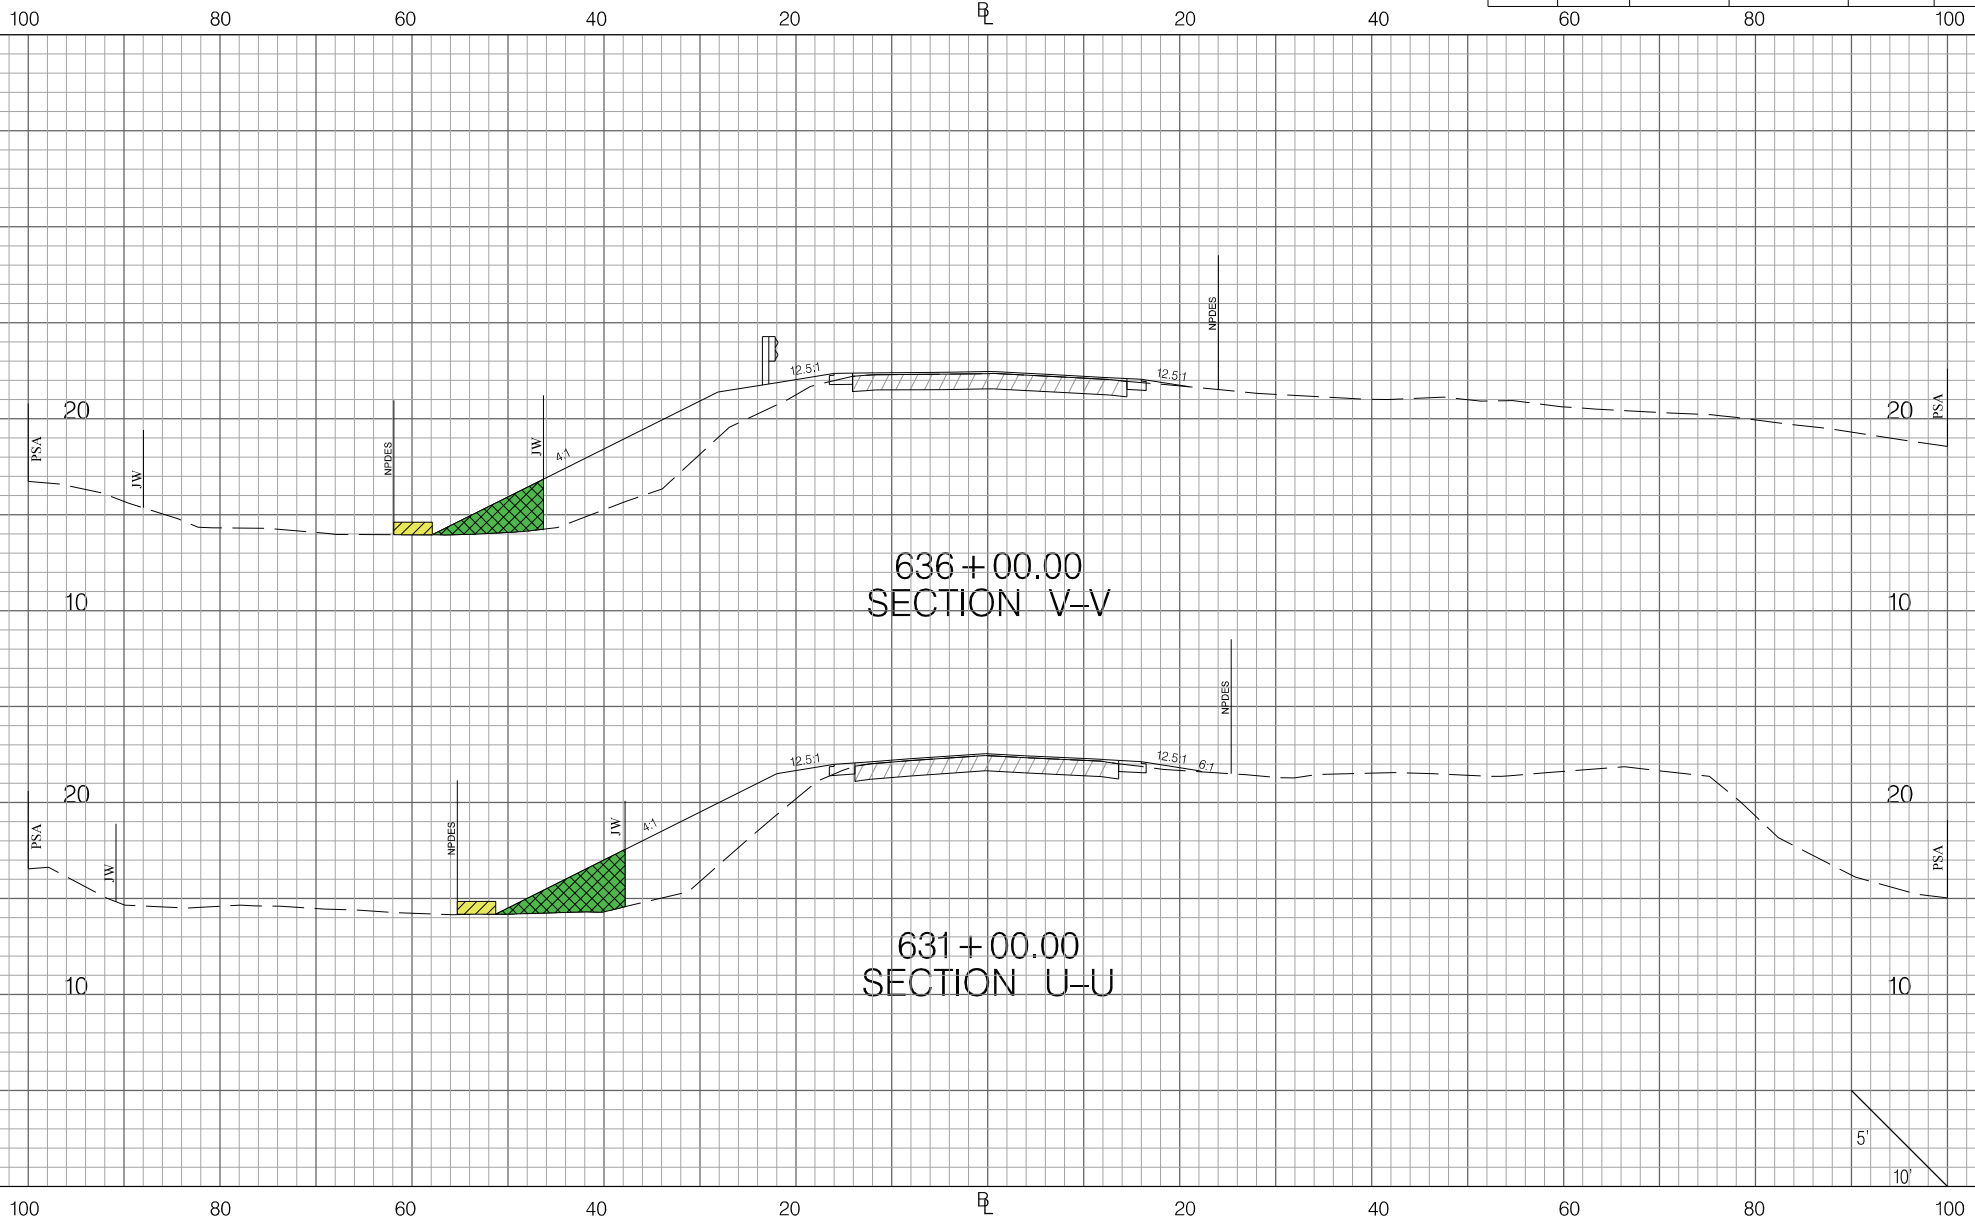FED. RD. DIV. NO.	STATE	COUNTY	PROJECT ID	ROAD / ROUTE NO.	SHEET NO.
3	SC	DORCHESTER	P037073	US 17A	62



SCALE: 1" = 10' HORIZONTAL 1" = 5' VERTICAL

LEGEND

-  WETLAND FILL IMPACT
-  WETLAND CLEARING IMPACT
-  NON-WETLAND WATER IMPACT



South Carolina Department of Transportation


SOUTH CAROLINA DEPARTMENT OF TRANSPORTATION  
US 17 ALTERNATE

CROSS SECTION SHEET

US 17 ALTERNATE  
RURAL ROADS SAFETY PROJECT




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FED. RD. DIV. NO.	STATE	COUNTY	PROJECT ID	ROAD / ROUTE NO.	SHEET NO.
3	SC	DORCHESTER	P037073	US 17A	63

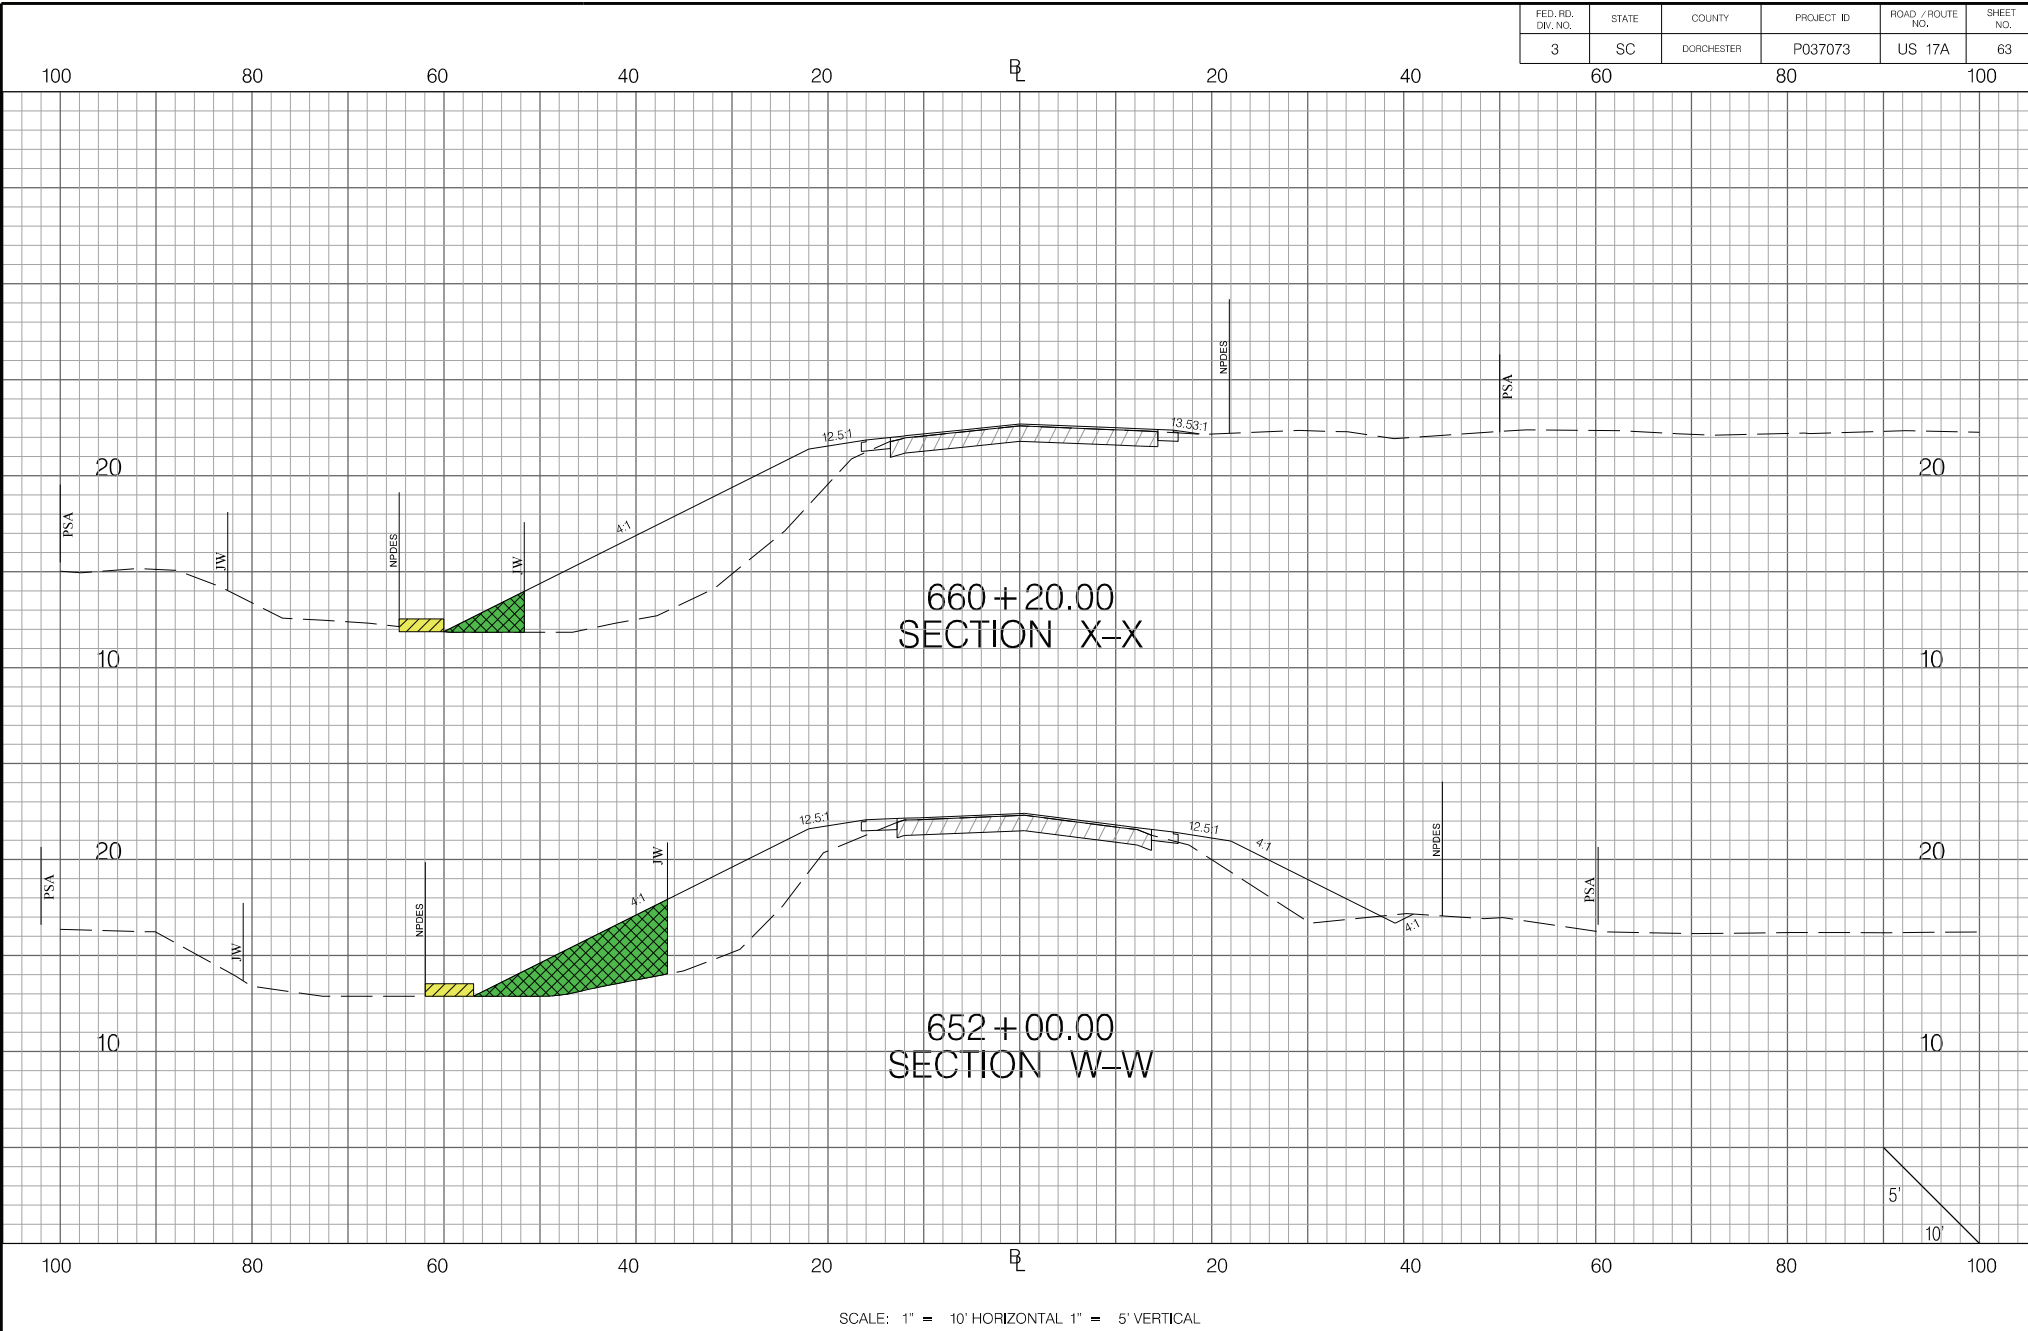

SCALE: 1" = 10' HORIZONTAL 1" = 5' VERTICAL

LEGEND

-  WETLAND FILL IMPACT
-  WETLAND CLEARING IMPACT
-  NON-WETLAND WATER IMPACT



South Carolina Department of Transportation

SOUTH CAROLINA DEPARTMENT OF TRANSPORTATION  
US 17 ALTERNATE


CROSS SECTION SHEET

US 17 ALTERNATE  
RURAL ROADS SAFETY PROJECT

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


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FED. RD. DIV. NO.	STATE	COUNTY	PROJECT ID	ROAD / ROUTE NO.	SHEET NO.
3	SC	DORCHESTER	P037073	US 17A	64

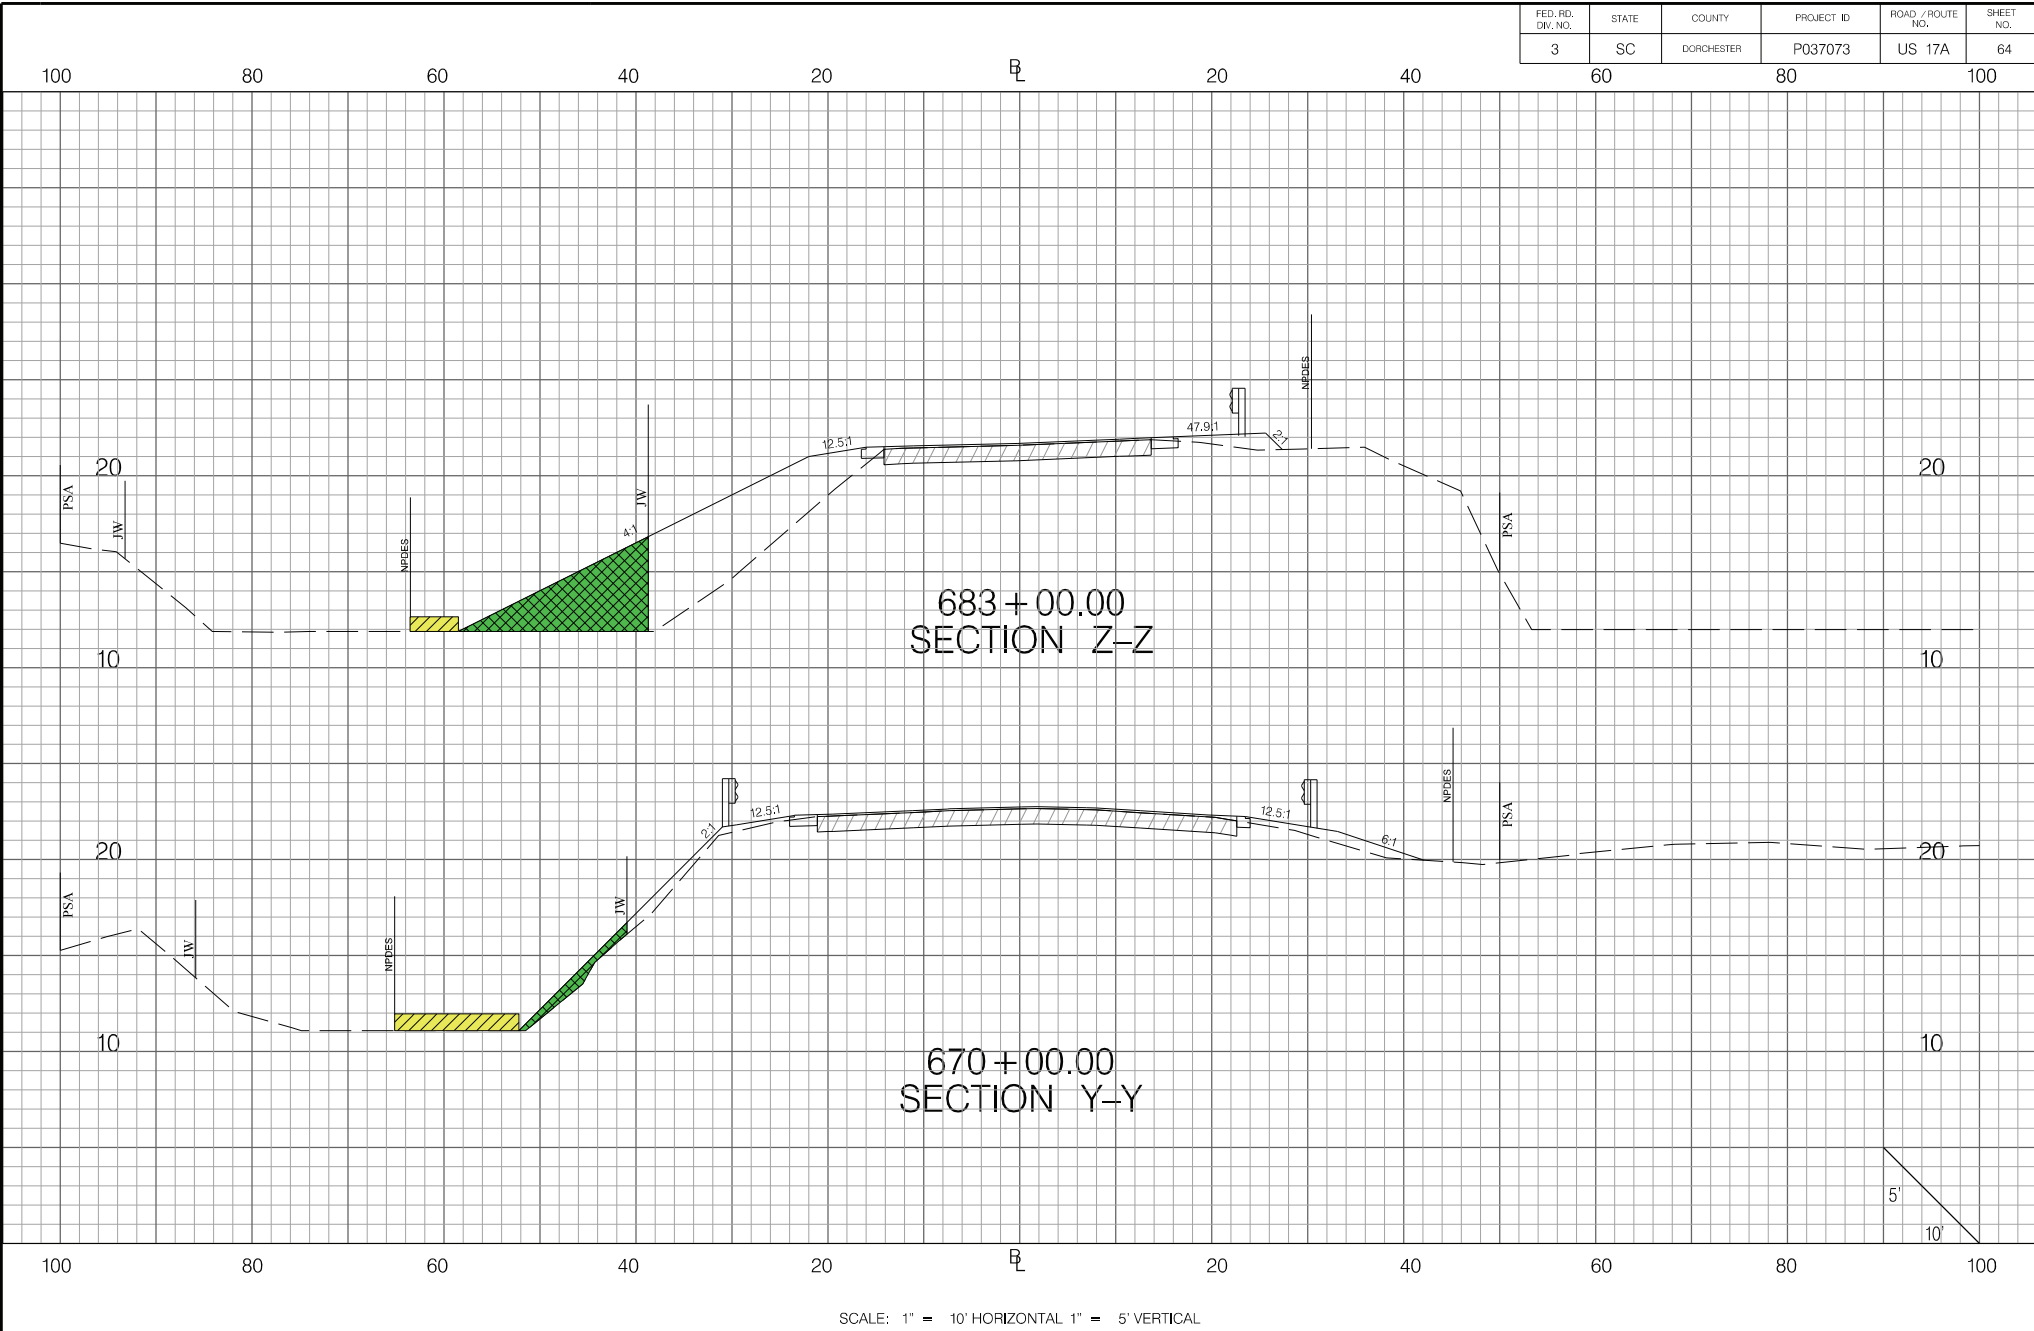

SCALE: 1" = 10' HORIZONTAL 1" = 5' VERTICAL

LEGEND

-  WETLAND FILL IMPACT
-  WETLAND CLEARING IMPACT
-  NON-WETLAND WATER IMPACT




South Carolina Department of Transportation

SOUTH CAROLINA DEPARTMENT OF TRANSPORTATION  
US 17 ALTERNATE

CROSS SECTION SHEET

US 17 ALTERNATE  
RURAL ROADS SAFETY PROJECT

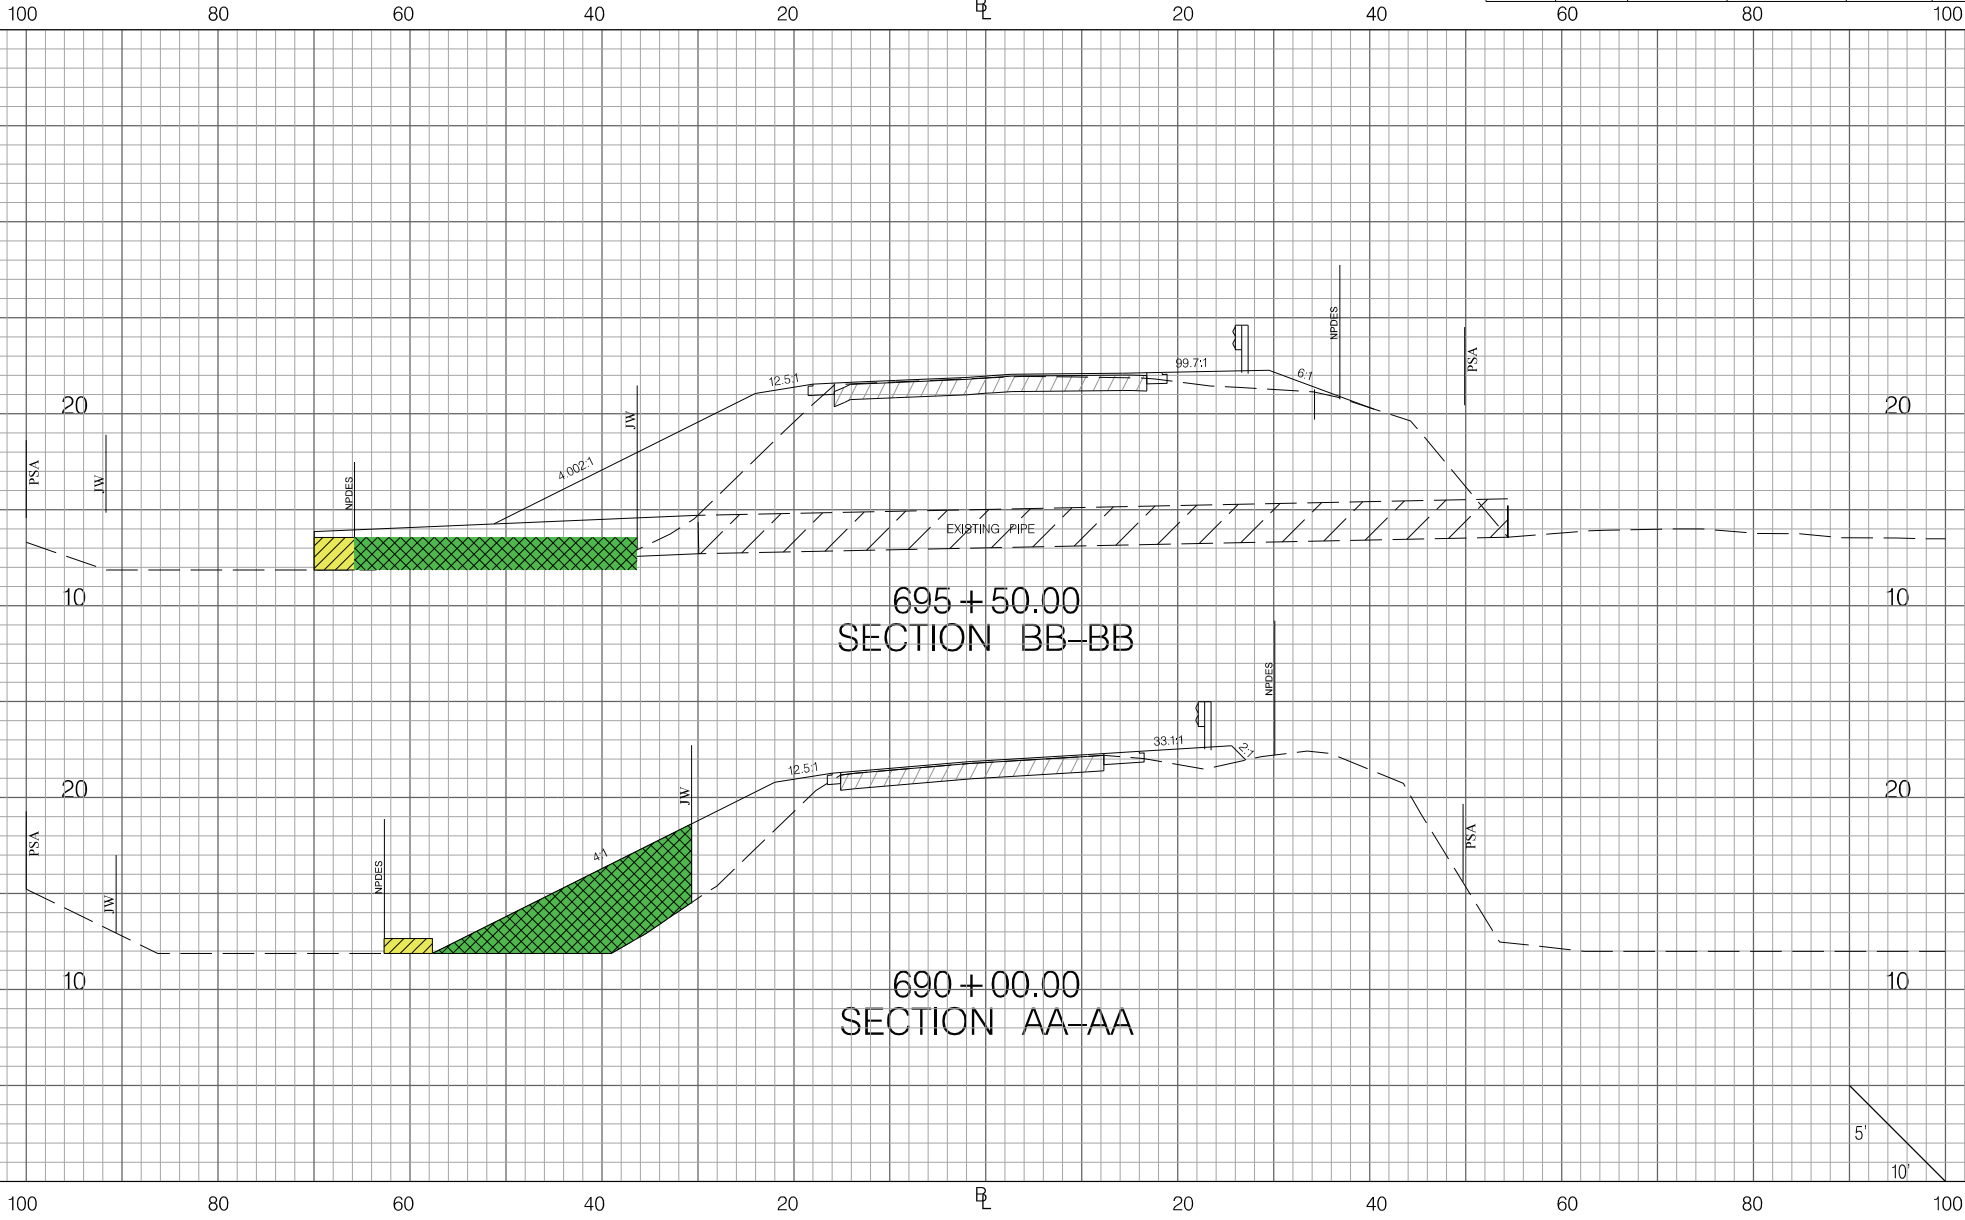


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3	SC	DORCHESTER	P037073	US 17A	65



100 80 60 40 20 20 40 60 80 100

SCALE: 1" = 10' HORIZONTAL 1" = 5' VERTICAL

LEGEND

-  WETLAND FILL IMPACT
-  WETLAND CLEARING IMPACT
-  NON-WETLAND WATER IMPACT



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SOUTH CAROLINA DEPARTMENT OF TRANSPORTATION  
US 17 ALTERNATE


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US 17 ALTERNATE  
RURAL ROADS SAFETY PROJECT

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FED. RD. DIV. NO.	STATE	COUNTY	PROJECT ID	ROAD / ROUTE NO.	SHEET NO.
3	SC	DORCHESTER	P037073	US 17A	66



SCALE: 1" = 10' HORIZONTAL 1" = 5' VERTICAL

LEGEND	
	WETLAND FILL IMPACT
	WETLAND CLEARING IMPACT
	NON-WETLAND WATER IMPACT

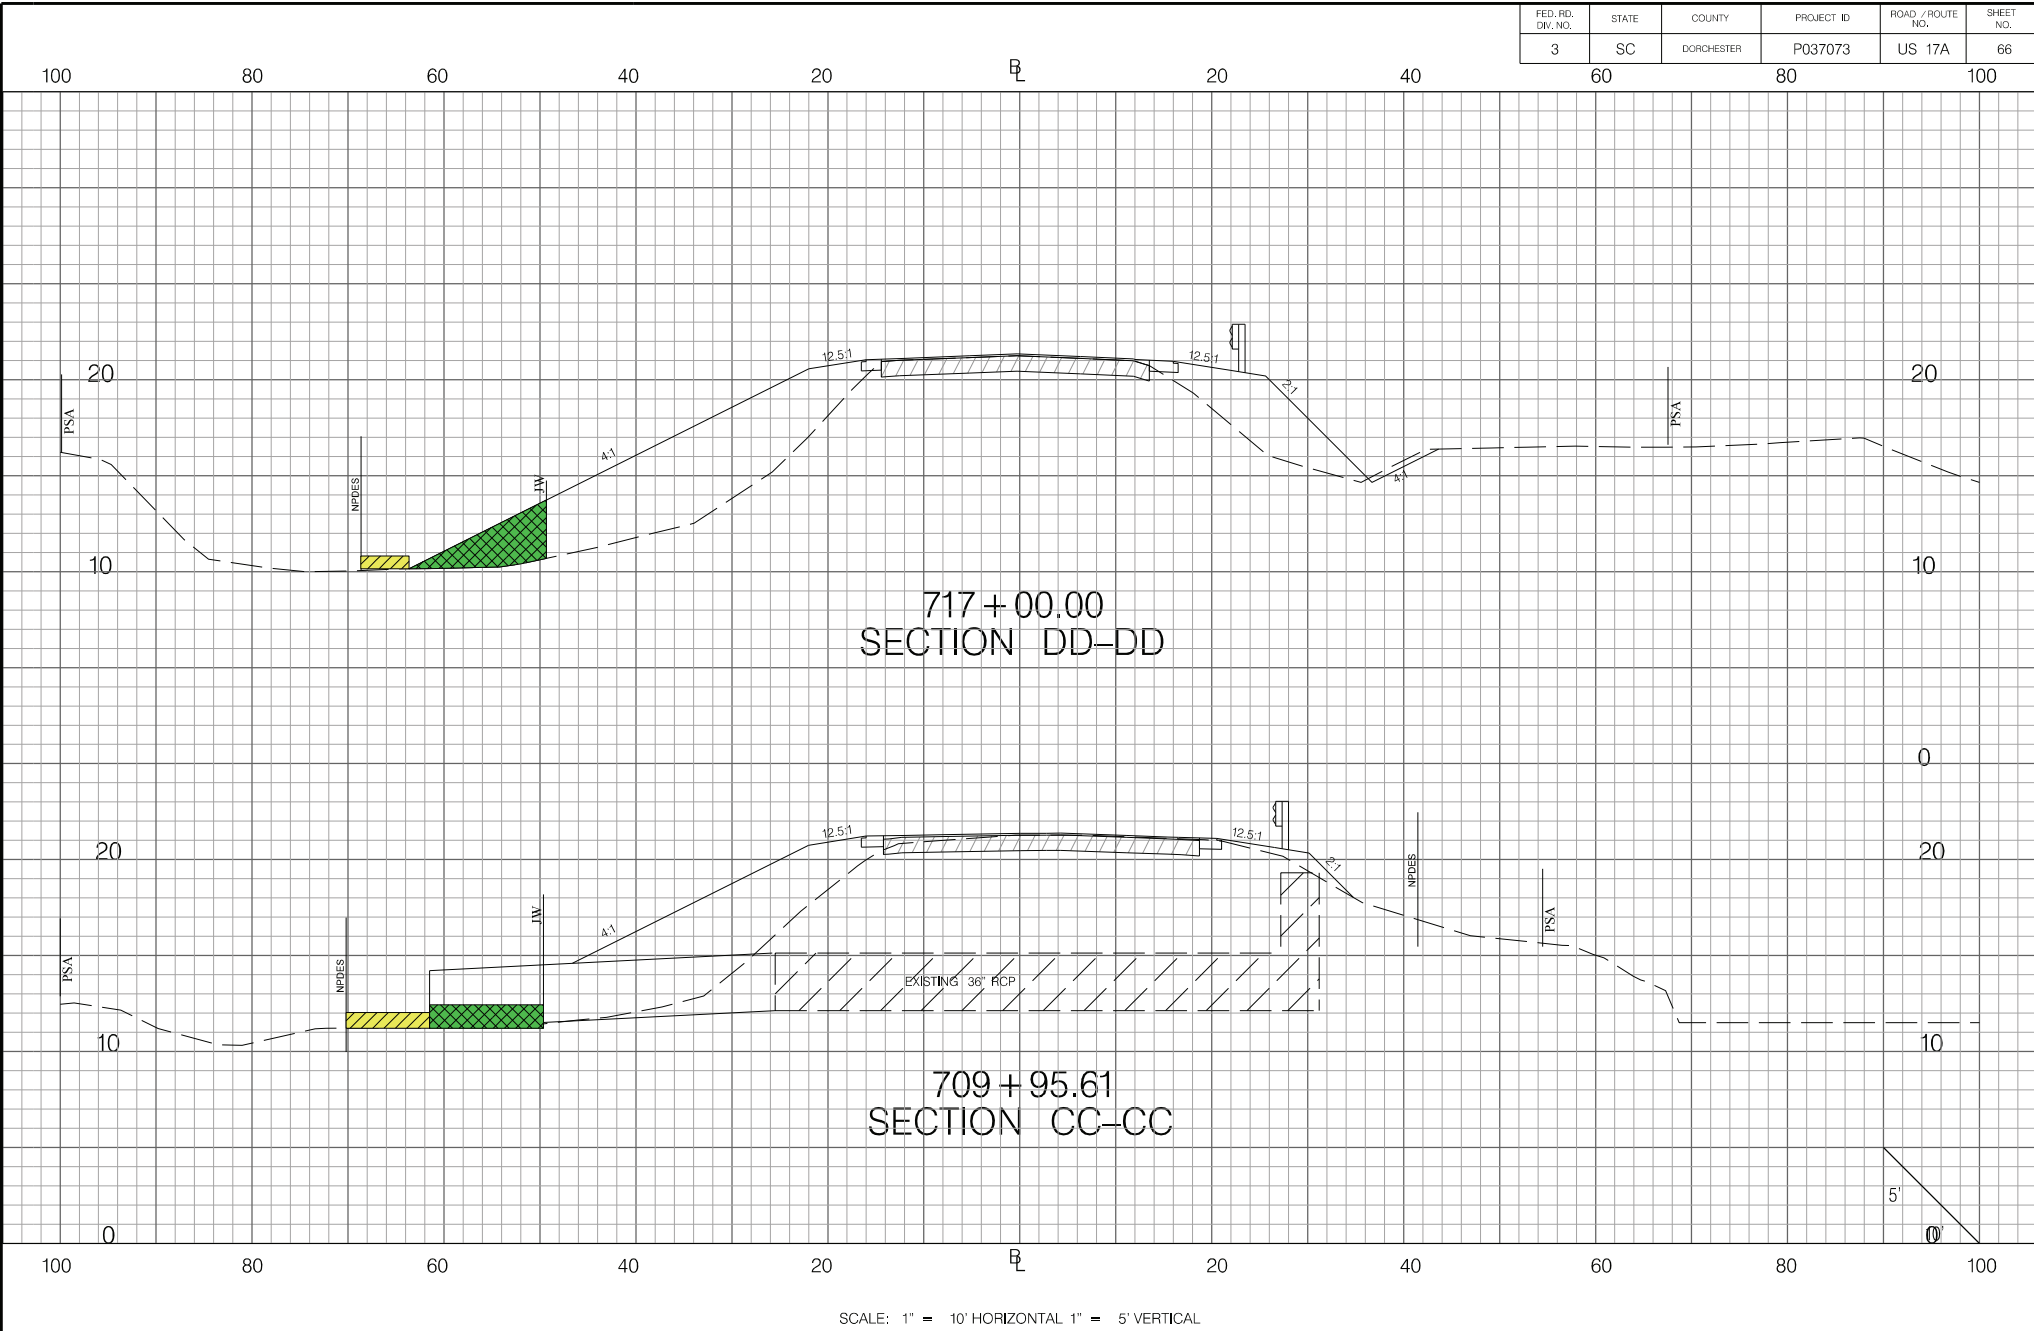


South Carolina Department of Transportation

SOUTH CAROLINA DEPARTMENT OF TRANSPORTATION US 17 ALTERNATE
CROSS SECTION SHEET
US 17 ALTERNATE RURAL ROADS SAFETY PROJECT



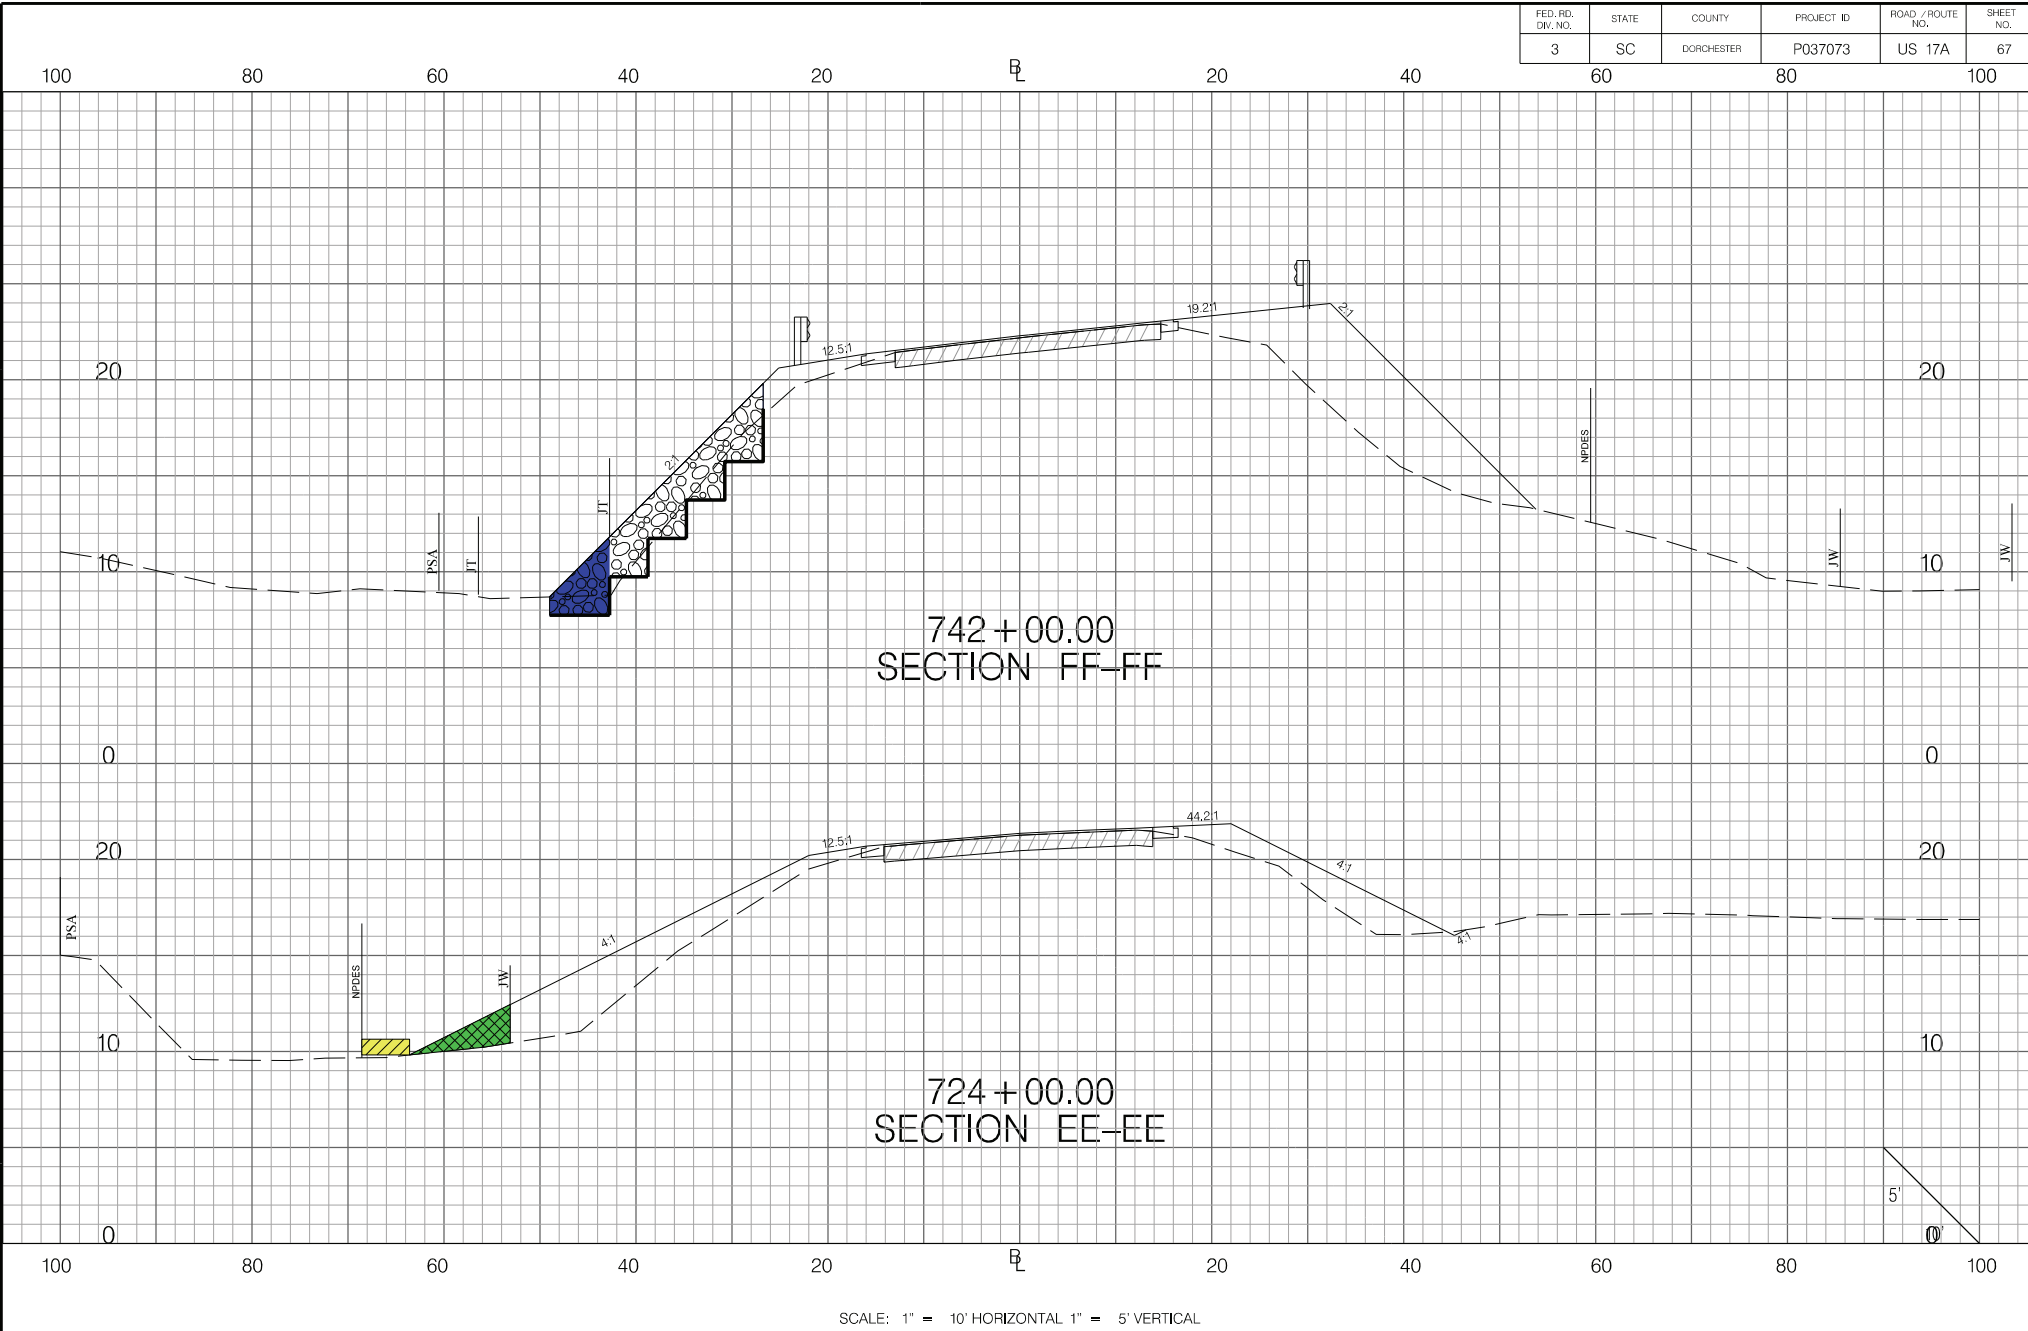

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FED. RD. DIV. NO.	STATE	COUNTY	PROJECT ID	ROAD / ROUTE NO.	SHEET NO.
3	SC	DORCHESTER	P037073	US 17A	67



SCALE: 1" = 10' HORIZONTAL 1" = 5' VERTICAL

LEGEND

-  WETLAND FILL IMPACT
-  WETLAND CLEARING IMPACT
-  NON-WETLAND WATER IMPACT
-  NON-WETLAND WATER ARMOR IMPACT



South Carolina Department of Transportation

SOUTH CAROLINA DEPARTMENT OF TRANSPORTATION  
US 17 ALTERNATE

CROSS SECTION SHEET

US 17 ALTERNATE  
RURAL ROADS SAFETY PROJECT